TRADITIONS

PRELIMINARY SP SITE PLAN

6922 NOLENSVILLE PIKE NASHVILLE, TENNESSEE

CASE NO. 2017SP-070-001

RESOURCE LIST

PROPERTY OWNER:

PHONE NO: (615) 405-4257 CONTACT: BÈRKÉLEY NANCE

ARCHITECT:

ESA ARCHITECTURE 1033 DEMONBREUN STREET, SUITE 800 NASHVILLE, TN 37203 PHONE: (615) 329-9445 CONTACT: MARK WATSON

CIVIL ENGINEER:

BATSON & ASSOCIATES ENGINEERING, INC. 5150 REMINGTON DRIVE BRENTWOOD, TN 37027 PHONE: (615) 424-4840 FAX: (615) 370-9363 CONTACT: GARRY BATSON

LAND SURVEYOR:

JAMES TERRY & ASSOCIATES, LAND SURVEYORS 2601 ELM HILL PIKE, SUITE R NASHVILLE, TENNESSEE 37214 PHONE: (615) 490-6920

LANDSCAPE ARCHITECT:

HEIBERT & ASSOCIATES, LLC. 1894 GENERAL GEORGE PATTON DRIVE FRANKLIN, TN 37067 PHONE: (615) 376-2421 FAX: (615) 376-2438 CONTACT: CONNOR BALL

DEVELOPMENT / CONSTRUCTION SCHEDULE BEGINNING NOVEMBER 2017 ENDING NOVEMBER 2018

PUBLIC WORKS CONSTRUCTION NOTES

- 1. ALL WORK WITHIN THE PUBLIC RIGHT-OF-WAY REQUIRES AN EXCAVATION PERMIT FROM THE DEPARTMENT OF PUBLIC WORKS.
- 2. PROOF-ROLLING OF ALL STREET SUB-GRADES IS REQUIRED IN THE PRESENCE OF THE PUBLIC WORKS INSPECTOR, REQUEST TO BE MADE 24 HOURS IN ADVANCE.
- 3. STOP SIGNS TO BE 30 INCH BY 30 INCH.
- 4. STREET SIGNS TO HAVE SIX INCH WHITE LETTERS ON A NINE INCH GREEN ALUMINUM BLADE, AND BE MOUNTED VERTICALLY STAGGERED.
- 5. ALL SIGNS TO HAVE 3M REFLECTIVE COATING.

BURKITT ROAD QUIET LANE VICINTY MAP

SCALE: N.T.S.

MAP: 181 PARCEL: 85 & 180

SHEET INDE

- SITE DEMOLITION PLAN
- SITE LAYOUT PLAN
- TURN LANE PLAN
- C-3 SITE AUTOTURN PLAN
- SITE UTILITY PLAN
- SITE GRADING & DRAINAGE PLAN
- EPSC PHASE 1
- EPSC PHASE 2
- EPSC PHASE 3
- SITE SOILS MAP
- SIGHT TRIANGLE PROFILE PLAN
- C-10 STANDARD DETAILS
- C-11 STANDARD DETAILS
- C-12 STANDARD DETAILS
- C-13 STANDARD DETAILS
- LANDSCAPE PLAN
- A2.01 EXTERIOR ELEVATIONS
- A2.02 EXTERIOR PERSPECTIVES

UTILITY COMPANIES:

ELECTRIC:

NASHVILLE ELECTRIC COMPANY 1214 CHURCH STREET NASHVILLE, TN 37203 (615) 747-3855

WATER AND SANITARY SEWER:

METROPOLITAN DEPARTMENT OF WATER AND SEWERAGE 1700 3RD AVENUE NORTH NASHVILLE, TN 37208 (615) 862-8600

NATURAL GAS:

NASHVILLE GAS 665 MAINSTREAM DRIVE NASHVILLE, TN 37228 (615) 734-0665

TELEPHONE:

AT&T (615) 557-6000

BATSON & ASSOCIATES Civil Engineering Consultants

5150 REMINGTON DRIVE **BRENTWOOD, TENNESSEE 37027** (615) 424-4840 ◆ FA□ (615) 370-9363


ISSUE DATE: 28 UN 2017 REVISED: 28 LUL 2017


DEVELOPMENT SUMMARY:

- COUNCIL DISTRICT 31st, FABIAN BEDNE
- OWNER OF RECORD: TRADITIONS OF SPRING HILL, 103 FORREST CROSSING BLVD, SUITE 204, FRANKLIN, TN 37064, (615) 405-4257
- SP NAME: TRADITIONS • SP NUMBER:
- CLUSTER: N/A • U.S. FEMA FIRM COMMUNITY PANEL: 47037C0456H, APRIL 5, 2017, ZONE "AY"


DEVELOPMENT / SITE DATA TABLE: • ACREAGE: 3.96 AC

- DENSITY: N/A
- DWELLING UNITS: N/A
- FLOOR AREA RATIO (FAR): 0.80
- IMPERVIOUS SURFACE RATIO (ISR): 0.80
- PARKING: 74 REQUIRED, 85 PROPOSED
- SQUARE FOOTAGE (GROSS) OF ALL LAND USES, EACH INDIVIDUAL USE, AND EACH INDIVIDUAL BUILDING / STRUCTURE: 131,095 SQ. FT.
- USES: ASSISTED LIVING FÁCILITY

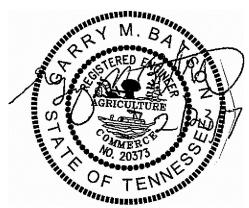

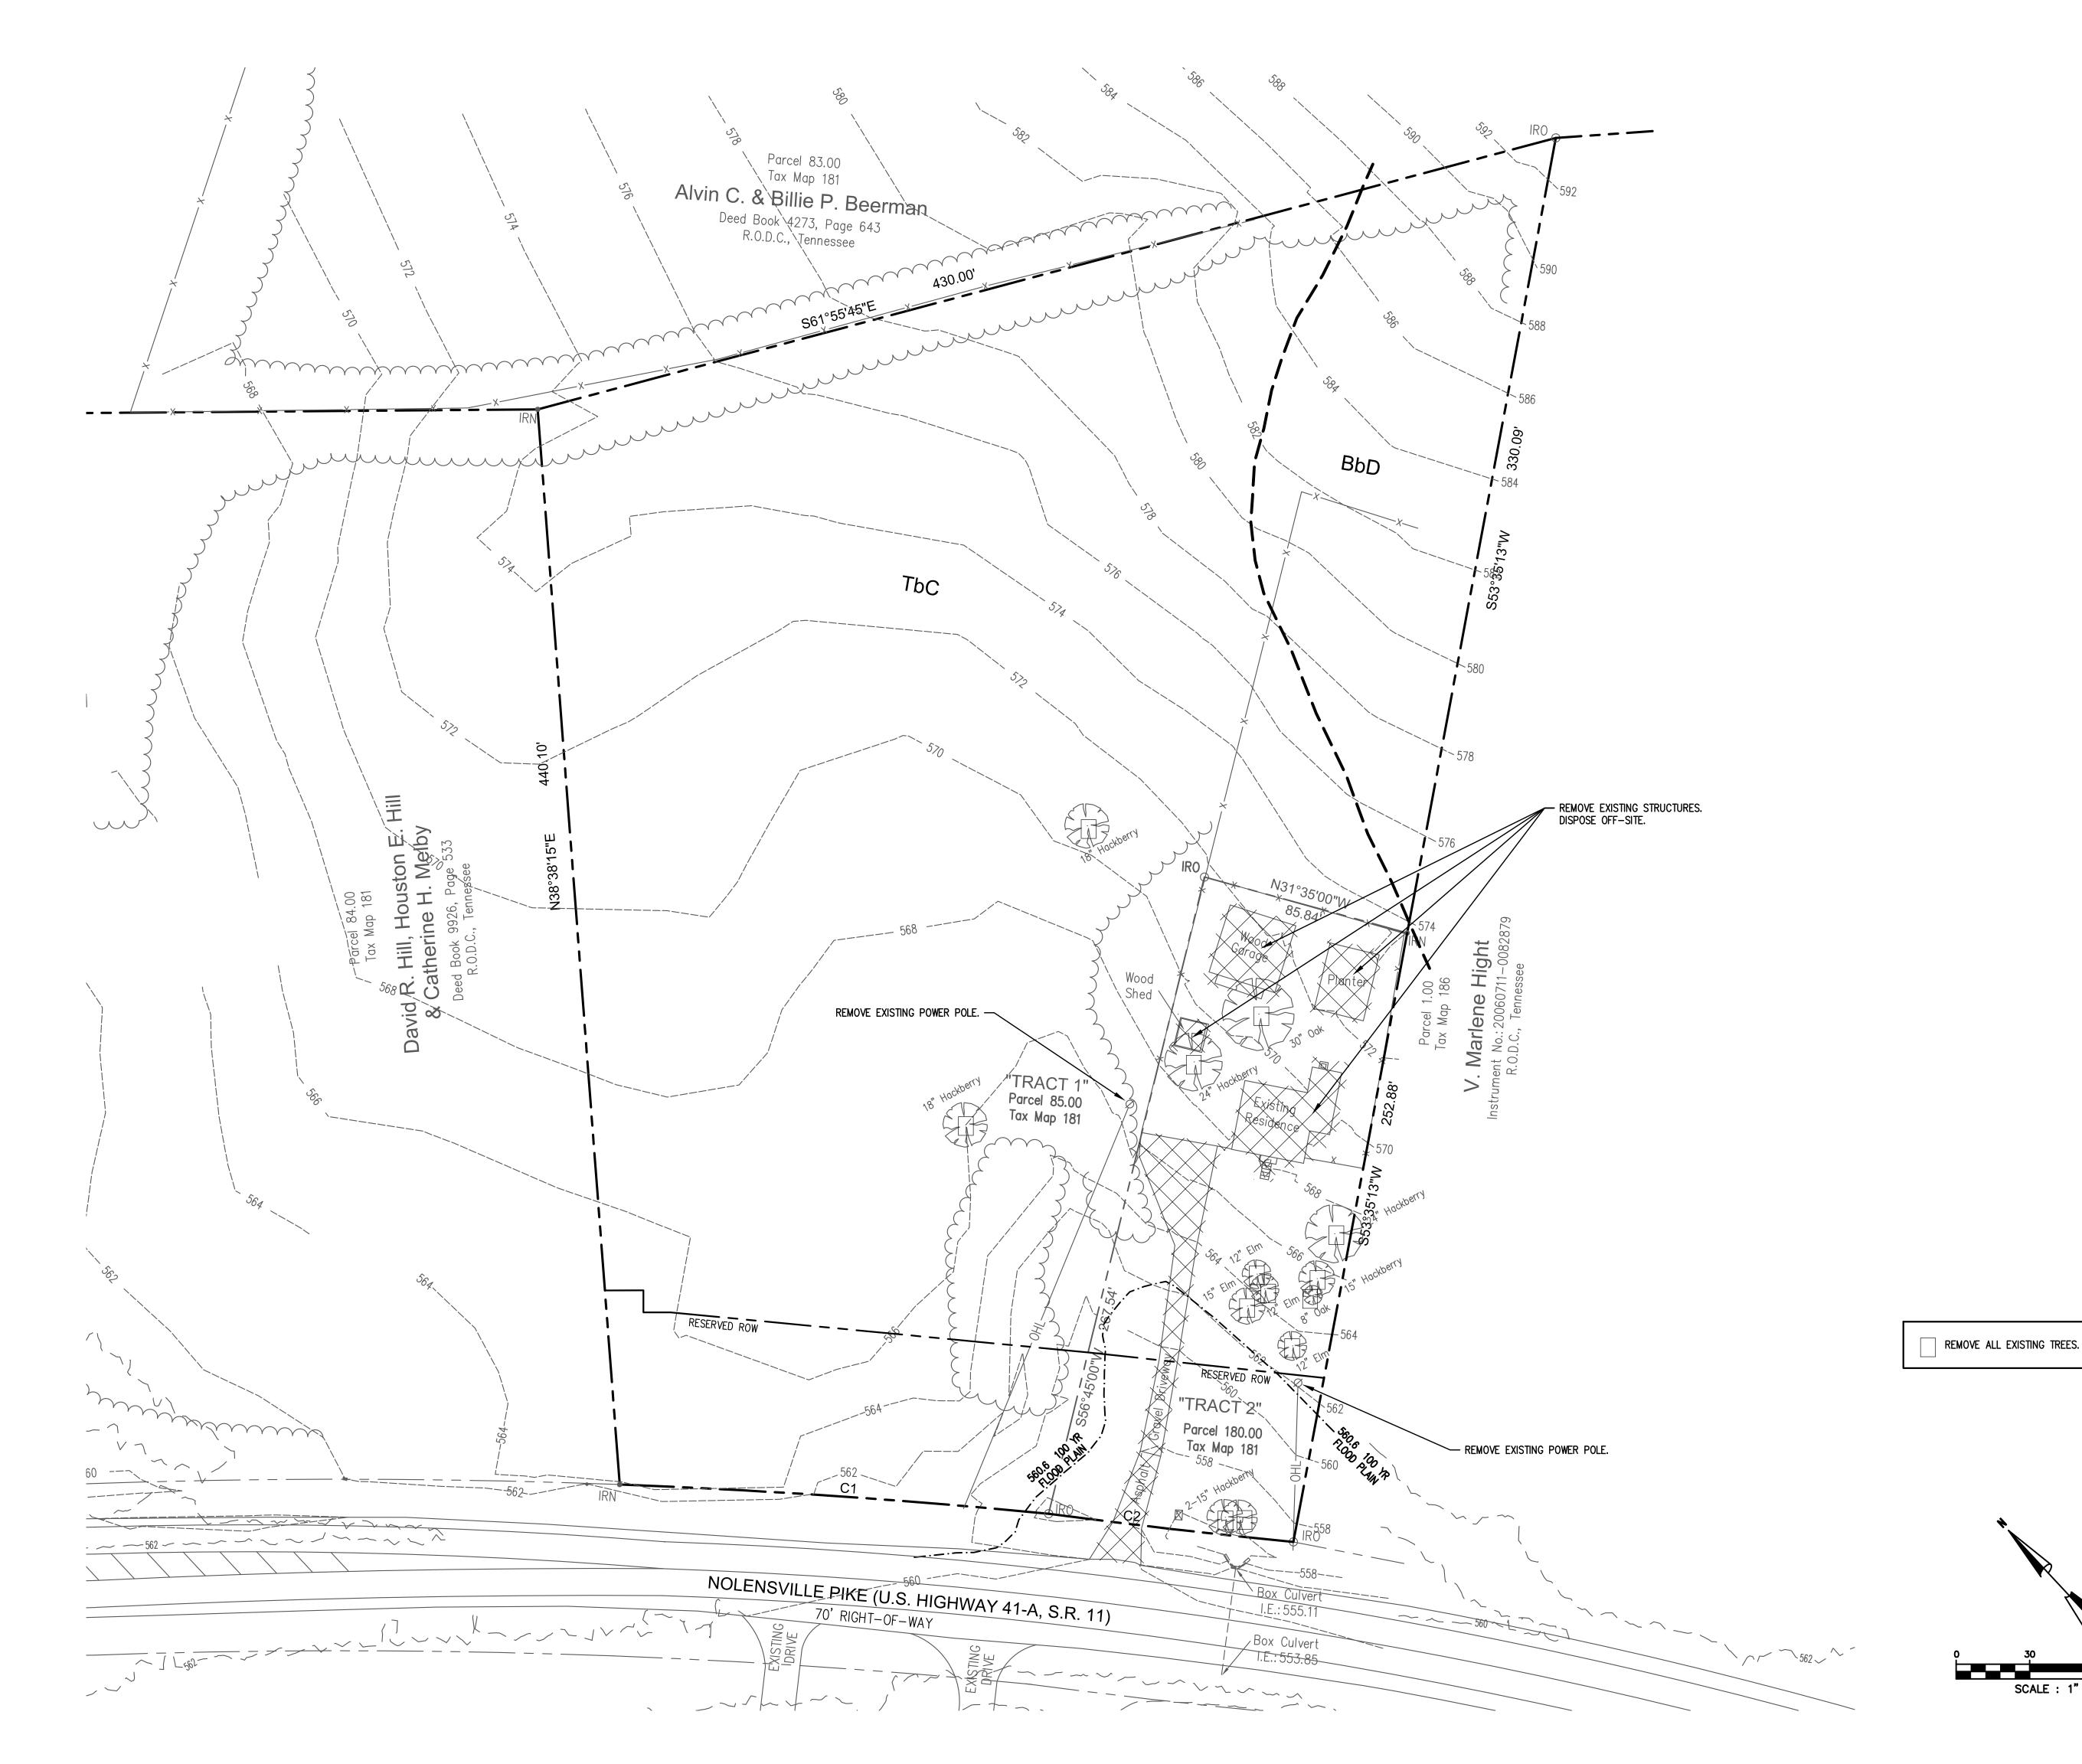



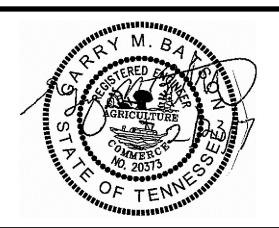

TRADITIONS PRELIMINARY

SP PLAN

6922 NOLENSVILLE PIKE NASHVILLE, TN

CASE NO. 2017SP-070-001 MAP: 181 PARCEL: 85 & 180

DESCRIPTION		DATE
COMMENT	1	19 JUL 2017
COMMENT	2	28 JUL 2017

PROŒCT NO. DATE 28 JUN 2017 DRAWN BY

CHECKED BY

SITE DEMOLITION PLAN

SHEET 1 OF 15

SCALE : 1" = 30'

ZONING REVIEW CHECKLIST NONRESIDENTIAL AND MULTIFAMILY CONSTRUCTION

APPLICATION # PROJECT NAME: MAP# / PARCEL # EXAMINER: USE - CHAPTER 17.08 AND 17.16 **A - APPROVED, D - DENIED, I - INCOMPLETE, P - PENDING, C - CONDITIONAL** DETERMINE THE USE: ASSISTED LIVING FACILITY PROPERTY ZONING: ARZA OVERLAY(S): N/A SURROUNDING ZONING: ARZA USE CHARTS (P, PC, SE, A): NONE REQUIRED SITE CRITERIA **SUPPLEMENTAL CHECKLIST ALSO REQUIRED FOR UDO** SUBDIVISION PLAT (NOTE ANY SPECIAL REQUIREMENTS SUCH AS EASEMENTS, SETBACK RESTRICTIONS AND ETC.) MINIMUM LOT SIZE: N/A SUBDIVISION SIZE: N/A BUILDING FOOTPRINT: 131,095 SQ, FT. FAR 0.80% MAXIMUM 0.80% REQUESTING SIRE AJUSTIMENTS / SLOPES OVER 11% 0.80% MAXIMUM 0.80% REQUESTING SIRE SETBACK / STREET TYPE(S): 40 FT. SIDE YARD: 20 FT. HEIGHT STANDARDS: 2:1 NUMBER OF FLOORS: 4 PARKING AND ACCESS - CHAPTER 17,20 **SUPPLEMENTAL CHECKLIST ALSO REQUIRED FOR UDO** RAMP LOCATION AND NUMBER: ONE SOUTHWEST DISTANCE TO INTERSECTIONS 50' MINIOR SIREET: 400 FT. 185' ARTERIAL STREET: NONE DISTANCE TO INTERSECTIONS 50' MINIOR SIREET: 400 FT. 185' ARTERIAL STREET: NONE REQUIRED PARKING BASED ON USE: NONE REQUIRED 90 PROVIDED SURFACING OVER 5 SPACES 1,750 SQ, FT.: PROVIDED NUMBER OF COMPACT SPACES / %: NONE REQUIRED NUMBER OF COMPACT SPACES / %: NONE / O% NUMBER OF HANDICAPPED SPACES: 4 SIDEVALKS REQUIRED: INTERNAL PROVIDED UNEFFER YARD ADJUSTMENT: NONE REQUIRED PERMICIEN LANDSCAPING (CAN NOT BE OVER FUTURE R.O.W.): NONE REQUIRED STANDARD FOR 4 ON MORE TAKEN PROVIDED UNEFFER YARD ADJUSTMENT: NONE REQUIRED STANDARD FOR 4 OR MORE LANES: PROVIDED UNEFFER YARD ADJUSTMENT: NONE REQUIRED STANDARD FOR 4 OR MORE LANES: NONE REQUIRED STANDARD FOR 4 OR MORE SAME AND FUTURE R.O.W.): NONE REQUIRED STANDARD FOR 4 OR MORE SAME AND FUTURE R.O.W.): NONE REQUIRED STANDARD FOR 4 OR MORE SAME AND FUTURE R.O.W.): NONE REQUIRED STANDARD FOR 4 OR MORE SAME AND FUTURE R.O.W.)	NONRESIDENTIAL AND MULTIFAMILY CONSTRUCTION	
USE — CHAPTER 17.08 AND 17.16 **A — APPROVED, D — DENIED, I — INCOMPLETE, P — PENDING, C — CONDITIONAL** DETERMINE THE USE: ASSISTED LUMING FACILITY PROPERTY ZONING: ARZA — OVERLAY(S): N/A — SURROUNDING ZONING: ARZA USE CHARTS (P. P.C, SE. A): NONE REQUIRED SITE ORTIERIA **SUPPLEMENTAL CHECKLIST ALSO REQUIRED FOR UDO** SUBDIVISION PLAT (NOTE ANY SPECIAL REQUIREMENTS SUCH AS EASEMENTS, SETBACK RESTRICTIONS AND ETC.) MINIMUM LOT SIZE: N/A — BUILDING FOOTPRINT: 131,095 SQ. FT. FAR — ADJUSTMENTS / SLOPES OVER 11% — 0.80% MAXIMUM — 0.80% REQUESTING ISR — ADJUSTMENTS / SLOPES OVER 11% — 0.80% MAXIMUM — 0.80% REQUESTING SIREET STBACK / STREET TYPE(S): 40 FT. FIREAT YARD: 20 FT. — REAR YARD: 20 FT. HEIGHT STANDARDS: 2:1 — NUMBER OF FLOORS: 4 PARKING AND ACCESS — CHAPTER 17.20 **SUPPLEMENTAL CHECKLIST ALSO REQUIRED FOR UDO** RAMP LOCATION AND NUMBER: ONE SOUTHWEST DISTANCE TO NEAREST EXISTING RAMP (MINIMUM 30'): 30+ FT. DISTANCE TO NEAREST EXISTING RAMP (MINIMUM 30'): 30+ FT. DISTANCE TO INTERSECTIONS 50 MINOR STREET: 400 FT. 185' ARTERIAL STREET: NONE 100' COLLECTOR: NONE — 250' CONTROLLED ACCESS RAMP: NONE REQUIRED PARKING BASED ON USE: 88 REQUIRED 90 PROVIDED SURFACING OVER 5 SPACES 1,750 SQ. FT.: PROVIDED SPACE SIZES, AISLE WIDTHS, ANGLE DATA: 9 FTX18 FT, 24 FT, 90' QUEUING LANGES: PROVIDED OVER 10 SPACES 20' QUEUING AT EXIT: PROVIDED NUMBER OF COMPACT SPACES / %: NONE REQUIRED POPEN HANDICAPPED SPACES 4 SIDEWALKS: PROVIDED UNERTO HANDICAPPED SPACES / %: NONE REQUIRED BUFFER YARD ADJUSTMENT: NONE REQUIRED BUFFER YARD ADJUSTMENT: NONE REQUIRED STANDARD FOR LESS THAN FOUR LANES: PROVIDED NUMBER OF LANDSCAPING CAN NOT BE OVER FUTURE R.O.W.): NONE REQUIRED STANDARD FOR LESS THAN FOUR LANES: PROVIDED NUMBER OF LANDSCAPING CAN NOT BE OVER FUTURE R.O.W.): NONE REQUIRED STANDARD FOR LESS THAN FOUR LANES: PROVIDED NETERIOR LANDSCAPING MINIMUM 8% AREA: PROVIDED NITERIOR LANDSCAPING MINIMUM 8% AREA: PROVIDED INTERIOR LANDSCAPING MINIMUM 8% AREA: PROVIDED NOR RECOURDED NOR REQUIRED LANDSCAP		
DETERMINE THE USE: ASSISTED LIVING FACILITY PROPERTY ZONING: AR2A USE CHARTS (P, PC, SE, A): NONE REQUIRED SITE CRITERIA **SUPPLEMENTAL CHECKUST ALSO REQUIRED FOR UDO** SUEDIVISION PLAT (NOITE ANY SPECIAL REQUIREMENTS SUCH AS EASEMENTS, SETBACK RESTRICTIONS AND ETC.) MINIMUM LOT SIZE: N/A BUILDING FOOTPRINT: 131,095 SQ, FT. FAR 0.80% MAXIMUM 0.80% REQUESTING SIRE ADJUSTMENTS / SLOPES OVER 11% 0.80% MAXIMUM 0.80% REQUESTING SIRE STEBACK / STREET TYPE(S): 40 FT. SIDE YARD: 20 FT. RECAR YARD: 20 FT. HEIGHT STANDARDS: 2.1 NUMBER OF FLOORS: 4 PARKING AND ACCESS — CHAPTER 17.20 **SUPPLEMENTAL CHECKUST ALSO REQUIRED FOR UDO** RAMP LOCATION AND NUMBER: ONE SOUTHWEST DISTANCE TO NEAREST EXISTING RAMP (MINIMUM 30'): 30+ FT. DISTANCE TO INTERSECTIONS 50' MINOR STREET: 400 FT. 100' COLLECTOR: NONE 100' COLLECTOR: NONE 250' CONTROLLED ACCESS RAMP: NONE REQUIRED LOADING BASED ON USE: 88 REQUIRED NONE PROVIDED SUFFACING OVER 5 SPACES 1,750 SQ. FT.: PROVIDED SUFFACING OVER 5 SPACES 1,750 SQ. FT.: PROVIDED VERFACING OVER 5 SPACES 1,750 SQ. FT.: PROVIDED OVER 10 SPACES 20' QUEUING AT EXIT: PROVIDED NOMBER OF COMPACT SPACES /*: NONE REQUIRED QUEUING LANGES. PROVIDED OVER 10 SPACES 20' QUEUING AT EXIT: PROVIDED SITANDARD FOR LANGES. PROVIDED SITANDARD STANDARD: INTERNAL PROVIDED SITANDARD FOR LORD STANDARD ON LISE: NONE REQUIRED PUBLIC PROVIDED SUFFACING OVER 5 SPACES 1,750 SQ. FT.: PROVIDED NUMBER OF HANDICAPPED SPACES. 4 SIDE MAIS STANDARD — CHAPTER 17.24 **SUPPLEMENTAL CHECKUST ALSO REQUIRED FOR UDO** REQUIRED LORDING STANDARD — CHAPTER 17.24 **SUPPLEMENTAL CHECKUST ALSO REQUIRED FOR UDO** STANDARD FOR LESS THAN FOUR LANES: PROVIDED STANDARD FOR LESS THAN FOUR LANES: PROVIDED STANDARD FOR LESS THAN FOUR LANES: NONE REQUIRED STANDARD FOR LESS THAN	MAP# / PARCEL # EXAMINER:	
DETERMINE THE USE: ASSISTED LIVING FACILITY PROPERTY ZONING: AR2A USE CHARTS (P, PC, SE, A): NONE REQUIRED SITE CRITERIA **SUPPLEMENTAL CHECKUST ALSO REQUIRED FOR UDO** SITE CRITERIA **SUPPLEMENTAL CHECKUST ALSO REQUIRED FOR UDO** SUBDIVISION PLAT (NOTE ANY SPECIAL REQUIREMENTS SUCH AS EASEMENTS, SETBACK RESTRICTIONS AND ETC.) MINIMUM LOT SIZE: N/A BUILDING FOOTPRINT: 131,095 SQ, FT. FAR 0.80% MAXIMUM 0.80% REQUESTING SIRE ADJUSTMENTS / SLOPES OVER 11% 0.80% MAXIMUM 0.80% REQUESTING SIRE STEBACK / STREET TYPE(S): 40 FT. SIDE YARD: 20 FT. RECAR YARD: 20 FT. HEICHT STANDARDS: 2:1 NUMBER OF FLOORS: 4 PARKING AND ACCESS — CHAPTER 17.20 **SUPPLEMENTAL CHECKUST ALSO REQUIRED FOR UDO** RAMP LOCATION AND NUMBER: ONE SOUTHWEST DISTANCE TO NEAREST EXISTING RAMP (MINIMUM 30'): 30+ FT. DISTANCE TO INTERSECTIONS 50' MINOR STREET: 400 FT. 100' COLLECTOR: NONE 250' CONTROLLED ACCESS RAMP: NONE REQUIRED PARKING BASED ON USE: 88 REQUIRED 90 PROVIDED SURFACING OVER 5 SPACES 1,750 SQ, FT.: PROVIDED SURFACING OVER 5 SPACES 1,750 SQ, FT.: PROVIDED OVER 10 SPACES 20' QUEUING AT EXIT: PROVIDED OVER 10 SPACES 20' QUEUING AT EXIT: PROVIDED NUMBER OF COMPACT SPACES /*: NONE / 0% NUMBER OF HANDICAPPED SPACES: NONE REQUIRED DISTANCE TO HANDICAPPED SPACES (**) **SUPPLEMENTAL CHECKUST ALSO REQUIRED FOR UDO** *** *** *************************	LISE - CHAPTER 17.08 AND 17.16 **A - APPROVED D - DENIED I - INCOMPLETE P - PENDING C - CONDITIONAL	4* 4
PROPERTY ZONING: AR2A OVERLAY(S): N/A SURROUNDING ZONING: AR2A USE CHARTS (P, PC, SE, A): NONE REQUIRED STEE CRITERIA **SUPPLEMENTAL CHECKLIST ALSO REQUIRED FOR UDO** SUBDIMSION PLAT (NOTE ANY SPECIAL REQUIREMENTS SUCH AS EASEMENTS, SETBACK RESTRICTIONS AND ETC.) MINIMUM LOT SIZE: N/A BUILDING FOOTPRINT: 131,095 SQ, FT. FAR O.80% MAXIMUM 0.80% REQUESTING ISR - ADJUSTMENTS / SLOPES OVER 11% 0.80% MAXIMUM 0.80% REQUESTING STREET SETBACK / STREET TYPE(S): 40 FT. SIDE YARD: 20 FT. REAR YARD: 20 FT. HEIGHT STANDARDS: 2:1 NUMBER OF FLOORS: 4 PARKING AND ACCESS - CHAPTER 17.20 **SUPPLEMENTAL CHECKLIST ALSO REQUIRED FOR UDO** RAMP LOCATION AND NUMBER: ONE SOUTHWEST DISTANCE TO INTERSECTIONS 50 MINOR STREET: 400 FT. 185' ARTERIAL STREET: NONE BISTANCE TO INTERSECTIONS 50 MINOR STREET: 400 FT. 185' ARTERIAL STREET: NONE REQUIRED PARKING BASED ON USE: NONE REQUIRED 90 PROVIDED REQUIRED LOADING BASED ON USE: NONE REQUIRED NONE PROVIDED SURFACING OVER 5 SPACES 1,750 SQ, FT.: PROVIDED SURFACING OVER 5 SPACES 1,750 SQ, FT.: PROVIDED OVER 10 SPACES 20' QUEUING AT EXIT: PROVIDED NUMBER OF COMPACT SPACES 1,750 SQ, FT.: PROVIDED NUMBER OF HANDICAPPED SPACES: 4 SIDEWALKS REQUIRED: INTERNAL PROVIDED PUBLIC PROVIDED NUMBER OF HANDICAPPED SPACES: 4 SIDEWALKS REQUIRED: INTERNAL PROVIDED PUBLIC PROVIDED NUMBER OF COMPACT SPACES 1,750 SQ, FT.: PROVIDED NUMBER OF HANDICAPPED SPACES: 4 SIDEWALKS REQUIRED: INTERNAL PROVIDED NUMBER OF HANDICAPPED SPACES: 4 SIDEWALKS REQUIRED: INTERNAL PROVIDED NUMBER OF HANDICAPPED SPACES: 4 SIDEWALKS REQUIRED: INTERNAL PROVIDED NUMBER OF HANDICAPPED SPACES: 4 SIDEWALKS REQUIRED: INTERNAL PROVIDED NUMBER OF HANDICAPPED SPACES: 4 SIDEWALKS REQUIRED: INTERNAL PROVIDED NUMBER OF HANDICAPPED SPACES: 4 SIDEWALKS REQUIRED: INTERNAL PROVIDED NONE PROVIDED NONE PROVIDED NONE PROV		
USE CHARTS (P, PC, SE, A): NONE REQUIRED STEE CRITERIA **SUPPLEMENTAL CHECKLIST ALSO REQUIRED FOR UDO** SUBDIMISION PLAT (NOTE ANY SPECIAL REQUIREMENTS SUCH AS EASEMENTS, SETBACK RESTRICTIONS AND ETC.) MINIMUM LOT SIZE: N/A BUILDING FOOTPRINT: 131,095 SQ. FT. FAR 0.80% MAXIMUM 0.80% REQUESTING STREET SETBACK / STREET TYPE(S): 40 FT. SIDE YARD: 20 FT. REAR YARD: 20 FT. REAR YARD: 20 FT. HEIGHT STANDARDS: 2:1 NUMBER OF FLOORS: 4 PARKING AND ACCESS — CHAPTER 17.20 **SUPPLEMENTAL CHECKLIST ALSO REQUIRED FOR UDO** RAMP LOCATION AND NUMBER: ONE SOUTHWEST DISTANCE TO NEAREST EXISTING RAMP (MINIMUM 30'): 30+ FT. DISTANCE TO NEAREST EXISTING RAMP (MINIMUM 30'): 30+ FT. DISTANCE TO INTERSECTIONS 50' MINOR STREET: 400 FT. 185' ARTERIAL STREET: NONE 100' COLLECTOR: NONE 250' CONTROLLED ACCESS RAMP: NONE REQUIRED PARKING BASED ON USE: 88 REQUIRED 90 PROVIDED REQUIRED LOADING BASED ON USE: 88 REQUIRED 90 PROVIDED SURFACING OVER 5 SPACES 1,750 SQ. FT.: PROVIDED SPACE SIZES, AISLE WIDTHS, ANGLE DATA: 9 FTX18 FT, 24 FT, 90' QUEUING LANES: PROVIDED OVER 10 SPACES 20' QUEUING AT EXIT: PROVIDED NUMBER OF COMPACT SPACES / %: NONE / 0% NUMBER OF HANDICAPPED SPACES: 4 SIDEWALKS REQUIRED: INTERNAL PROVIDED DUFFER YARD ADJUSTMENT: NONE REQUIRED STANDARD FOR 4 OR MORE LANES: NONE REQUIRED STANDARD FOR 12ST HAND FOUR LANES: PROVIDED STANDARD FOR 12ST HAND FOUR LANES: NONE REQUIRED STANDARD FOR 12ST HAND FOUR LANES: NO		†
SITE CRITERIA **SUPPLEMENTAL CHECKLIST ALSO REQUIRED FOR UDO** SUBDIVISION PLAT (NOTE ANY SPECIAL REQUIREMENTS SUCH AS EASEMENTS, SETBACK RESTRICTIONS AND ETC.) MINIMUM LOT SIZE: N/A BUILDING FOOTPRINT: 131,095 SQ. FT. FAR 0.80% MAXIMUM 0.80% REQUESTING SIRECT SETBACK / SIREET TYPE(S): 40 FT. SIDE YARD: 20 FT. REAR YARD: 20 FT. HEIGHT STANDARDS: 2:1 NUMBER OF FLOORS: 4 PARKING AND ACCESS - CHAPTER 17.20 **SUPPLEMENTAL CHECKLIST ALSO REQUIRED FOR UDO** RAMP LOCATION AND NUMBER: ONE SOUTHWEST DISTANCE TO INTERSECTIONS 50′ MINOR SIREET: 400 FT. 185′ ARTERIAL SIREET: NONE DISTANCE TO INTERSECTIONS 50′ MINOR SIREET: 400 FT. 185′ ARTERIAL SIREET: NONE REQUIRED PARKING BASED ON USE: 88 REQUIRED 90 PROVIDED REQUIRED LOADING BASED ON USE: NONE REQUIRED NONE PROVIDED SURFACING OVER 5 SPACES 1,750 SQ. FT.: PROVIDED SURFACING OVER 5 SPACES 1,750 SQ. FT.: PROVIDED OVER 10 SPACES SEZES, AISLE WIDTHS, ANGE DATA: 9 FT/X8 FT, 24 FT, 90′ QUEUING LANES: PROWOED OVER 10 SPACES 20′ QUEUING AT EXIT: PROVIDED NUMBER OF HANDICAPPED SPACES: 4 SIDEWALKS REQUIRED: INTERNAL PROVIDED PUBLIC PROVIDED LANDSCAPING STANDARD - CHAPTER 17.24 **SUPPLEMENTAL CHECKLIST ALSO REQUIRED FOR UDO** REQUIRED BUFFER YARDS. NONE REQUIRED OVER 10 SPACES 20′ QUEUING AT EXIT: PROVIDED NUMBER OF HANDICAPPED SPACES: 4 SIDEWALKS REQUIRED: INTERNAL PROVIDED PUBLIC PROVIDED LANDSCAPING STANDARD - CHAPTER 17.24 **SUPPLEMENTAL CHECKLIST ALSO REQUIRED FOR UDO** REQUIRED BUFFER YARDS. NONE REQUIRED STANDARD FOR 4 OR MORE LANES: NONE REQUIRED STANDARD FOR LESS THAN FOUR LANES: PROVIDED INTERIOR LANDSCAPING (CAN NOT BE OVER FUTURE R.O.W.): NONE REQUIRED STANDARD FOR LESS THAN FOUR LANES: PROVIDED INTERIOR LANDSCAPING (CAN NOT BE OVER FUTURE R.O.W.): NONE REQUIRED STANDARD FOR LESS THAN FOUR LANES: PROVIDED INTERIOR LANDSCAPING (CAN NOT BE OVER FUTURE R.O.W.): NONE REQUIRED STANDARD FOR LESS THAN FOUR LANES: PROVIDED OPAQUE FENCE ADJACENT TO PARKING AREA: PROVIDED INTERIOR LANDSCAPING (CAN NOT BE OVER FUTURE R.O.W.): PROVIDED OPAQUE FENCE ADJACENT TO PARKING	USE CHARTS (P. PC. SE. A): NONE REQUIRED	\top
SUBDIVISION PLAT (NOTE ANY SPECIAL REQUIREMENTS SUCH AS EASEMENTS, SETBACK RESTRICTIONS AND ETC.) MINIMUM LOT SIZE: N/A BUILDING FOOTPRINT: 131,095 SQ, FT. FAR 0.80% MAXIMUM 0.80% REQUESTING ISR - ADJUSTMENTS / SLOPES OVER 11% 0.80% MAXIMUM 0.80% REQUESTING STREET SETBACK / STREET TYPE(S): 40 FT. SIDE YARD: 20 FT. REAR YARD: 20 FT. HEIGHT STANDARDS: 2:1 NUMBER OF FLOORS: 4 PARKING AND ACCESS - CHAPTER 17.20 **SUPPLEMENTAL CHECKLIST ALSO REQUIRED FOR UDO** RAMP LOCATION AND NUMBER: ONE SOUTHWEST DISTANCE TO NEAREST EXISTING RAMP (MINIMUM 30'): 30+ FT. DISTANCE TO INTERSECTIONS 50' MINOR STREET: 400 FT. 185' ARTERIAL STREET: NONE 100' COLLECTOR: NONE 250' CONTROLLED ACCESS RAMP: NONE REQUIRED PARKING BASED ON USE: 88 REQUIRED 90 PROVIDED SURFACING OVER 5 SPACES 1,750 SQ. FT.: PROVIDED SURFACING OVER 5 SPACES 1,750 SQ. FT.: PROVIDED SPACE SIZES, AISLE WIDTHS, ANGLE DATA: 9 FTX18 FT, 24 FT, 90' QUEUING LANES: PROVIDED OVER 10 SPACES 20' QUEUING AT EXIT: PROVIDED NUMBER OF COMPACT SPACES / %: NONE / 0% NUMBER OF HANDICAPPED SPACES / %: NONE / 0% NUMBER OF HANDICAPPED SPACES: 1,750 ROSE STACES INTERNAL PROVIDED LANDSCAPING STANDARD - CHAPTER 17.24 **SUPPLEMENTAL CHECKLIST ALSO REQUIRED FOR UDO** REQUIRED BUFFER YARDS: NONE REQUIRED SIDEWALKS REQUIRED: INTERNAL PROVIDED PERIMETER LANDSCAPING (CAN NOT BE OVER FUTURE R.O.W.): NONE REQUIRED STANDARD FOR 4 OR MORE LANES: NONE REQUIRED STANDARD FOR LESS THAN FOUR LANES: PROVIDED STANDARD FOR LESS THAN FOUR LANES: PROVIDED JOPAQUE FENCE ADJACENT TO PARKING AREAS 5' MINIMUM WIDTH W/ TREES - 2.5' W/ TREE ISLANDS: NONE REQUIRED STANDARD FOR LESS THAN FOUR LANES: PROVIDED JOPAQUE FENCE ADJACENT TO PARKING AREAS 5' MINIMUM WIDTH W/ TREES - 2.5' W/ TREE ISLANDS: NONE REQUIRED STANDARD FOR LESS THAN FOUR EXALS: NONE REQUIRED STANDARD FOR LESS THAN FOUR LANES: PROVIDED OPAQUE FENCE ADJACENT TO PARKING AREAS 5' MINIMUM WIDTH W/ TREES - 2.5' W/ TREE ISLANDS: NONE REQUIRED STANDARD FOR LESS THAN FOUR EXALSES THAN FOUR FENCE PERMITTED): PROVIDED OPAQ		
MINIMUM LOT SIZE: N/A BUILDING FOOTPRINT: 131,095 SQ, FT. FAR 0.80% MAXIMUM 0.80% REQUESTING SIRECT SETBACK / STREET TYPE(S): 40 FT. SIDE YARD: 20 FT. RECAR YARD: 20 FT. HEIGHT STANDARDS: 2:1 NUMBER OF FLOORS: 4 PARKING AND ACCESS — CHAPTER 17.20 **SUPPLEMENTAL CHECKLIST ALSO REQUIRED FOR UDO** RAMP LOCATION AND NUMBER: ONE SOUTHWEST DISTANCE TO INTERSECTIONS 50 MINIMUM 30'): 30+ FT. DISTANCE TO INTERSECTIONS 50 MINIMUM 30'): 30+ FT. DISTANCE TO INTERSECTIONS 50 MINIMOR STREET: 400 FT. 185' ARTERIAL STREET: NONE 100' COLLECTOR: NONE 250' CONTROLLED ACCESS RAMP: NONE REQUIRED PARKING BASED ON USE: 88 REQUIRED 90 PROVIDED REQUIRED LOADING BASED ON USE: NONE REQUIRED NONE PROVIDED SURFACING OVER 5 SPACES 1,750 SQ, FT.: PROVIDED SPACE SIZES, AISLE MIDTHS, ANGLE DATA: 9 FTX18 FT, 24 FT, 90' QUEUING LANES: PROVIDED OVER 10 SPACES 20' QUEUING AT EXIT: PROVIDED NUMBER OF COMPACT SPACES 4 SIDEWALKS REQUIRED: INTERNAL PROVIDED DURDED STANDARD — CHAPTER 17.24 **SUPPLEMENTAL CHECKLIST ALSO REQUIRED FOR UDO** REQUIRED BUFFER YARDS: NONE REQUIRED PERIMETER LANDSCAPING (CAN NOT BE OVER FUTURE R.O.W.): NONE REQUIRED STANDARD FOR LESS THAN FOUR LANES: PROVIDED INTERNAL PROVIDED DISTANCE TO PARKING BASED ON USE: NONE REQUIRED STANDARD FOR LESS THAN FOUR LANES: PROVIDED DUSTED STANDARD — CHAPTER 17.24 **SUPPLEMENTAL CHECKLIST ALSO REQUIRED FOR UDO** REQUIRED BUFFER YARDS: NONE REQUIRED STANDARD FOR LESS THAN FOUR LANES: PROVIDED DISTANDARD FOR LESS THAN FOUR LANES: PROVIDED STANDARD FOR LESS THAN FOUR LANES: PROVIDED INTERIOR LANDSCAPING (CAN NOT BE OVER FUTURE R.O.W.): NONE REQUIRED STANDARD FOR LESS THAN FOUR LANES: PROVIDED JOE LINES ADJACENT TO PARKING AREAS 5' MINIMUM WIDTH W/ TREES — 2.5' W/ TREE ISLANDS: NONE REQUIRED STANDARD FOR LESS THAN FOUR LANES: PROVIDED JOE LINES ADJACENT TO PARKING AREAS 5' MINIMUM WIDTH W/ TREES — 2.5' W/ TREE ISLANDS: NONE REQUIRED JOE LINES ADJACENT TO PARKING AREAS 5' MINIMUM WIDTH W/ TREES — 2.5' W/ TREE ISLANDS: NONE REQUIRED JOE LANDSCAPING MINIMUM B	SUBDIVISION PLAT (NOTE ANY SPECIAL REQUIREMENTS SUCH AS EASEMENTS, SETBACK RESTRICTIONS AND ETC.)	
SIREET SETBACK / STREET TYPE(S): 40 FT. REAR YARD: 20 FT. HEIGHT STANDARDS: 2:1 NUMBER OF FLOORS: 4 PARKING AND ACCESS — CHAPTER 17.20 **SUPPLEMENTAL CHECKLIST ALSO REQUIRED FOR UDO** RAMP LOCATION AND NUMBER: ONE SOUTHWEST DISTANCE TO INERREST EXISTING RAMP (MINIMUM 30'): 30+ FT. DISTANCE TO INTERSECTIONS 50' MINOR STREET: 400 FT. 185' ARTERIAL STREET: NONE 100' COLLECTOR: NONE 250' CONTROLLED ACCESS RAMP: NONE REQUIRED PARKING BASED ON USE: 88 REQUIRED 90 PROVIDED REQUIRED LOADING BASED ON USE: NONE REQUIRED NONE PROVIDED SURFACING OVER 5 SPACES 1,750 SQ. FT.: PROVIDED SURFACING OVER 5 SPACES 1,750 SQ. FT.: PROVIDED SURFACING OVER 5 SPACES 1,750 SQ. FT.: PROVIDED OVER 10 SPACES 20' QUEUING AT EXIT: PROVIDED OVER 10 SPACES 20' QUEUING AT EXIT: PROVIDED NUMBER OF COMPACT SPACES / %: NONE / 0% NUMBER OF HANDICAPPED SPACES: 4 SIDEWALKS REQUIRED: INTERNAL PROVIDED PUBLIC PROVIDED LANDSCAPING STANDARD — CHAPTER 17.24 **SUPPLEMENTAL CHECKLIST ALSO REQUIRED FOR UDO** REQUIRED BUFFER YARDS: NONE REQUIRED BUFFER YARD ADJUSTIMENT: NONE REQUIRED STANDARD FOR 4 OR MORE LANES: NONE REQUIRED STANDARD FOR LESS THAN FOUR LANES: PROVIDED STANDARD FOR LESS THAN FOUR LANES: NONE REQUIRED STANDARD FOR LESS THAN FOUR LANES: PROVIDED SIDE LINES ADJACENT TO PARKING AREAS 5' MINIMUM WIDTH W/ TREES — 2.5' W/ TREE ISLANDS: NONE REQUIRED INTERIOR LANDSCAPING MINIMUM 8% AREA: PROVIDED OPAQUE FENCE ADJACENT TO PARKING AREAS 5' MINIMUM WIDTH W/ TREES — 2.5' W/ TREE ISLANDS: NONE REQUIRED STANDARD FOR LESS THAN FOUR LANES: PROVIDED OPAQUE FENCE ADJACENT TO PARKING AREAS 5' MINIMUM WIDTH W/ TREES — 2.5' W/ TREE ISLANDS: NONE REQUIRED STANDARD FOR LESS THAN FOUR LANES: PROVIDED OPAQUE FENCE ADJACENT TO RESIDENTAL IN PARKING AREA: NONE REQUIRED SCREENING AROUND DUMPSTERS (NO CHAIN LINK FENCE PERMITTED): PROVIDED		
SIREET SETBACK / STREET TYPE(S): 40 FT. REAR YARD: 20 FT. HEIGHT STANDARDS: 2:1 NUMBER OF FLOORS: 4 PARKING AND ACCESS — CHAPTER 17.20 **SUPPLEMENTAL CHECKLIST ALSO REQUIRED FOR UDO** RAMP LOCATION AND NUMBER: ONE SOUTHWEST DISTANCE TO INERSEST EXISTING RAMP (MINIMUM 30'): 30+ FT. DISTANCE TO INTERSECTIONS 50' MINOR STREET: 400 FT. 185' ARTERIAL STREET: NONE 100' COLLECTOR: NONE 250' CONTROLLED ACCESS RAMP: NONE REQUIRED PARKING BASED ON USE: 88 REQUIRED 90 PROVIDED REQUIRED LOADING BASED ON USE: NONE REQUIRED NONE PROVIDED SURFACING OVER 5 SPACES 1,750 SQ. FT.: PROVIDED SURFACING OVER 5 SPACES 1,750 SQ. FT.: PROVIDED SURFACING OVER 5 SPACES 1,750 SQ. FT.: PROVIDED OVER 10 SPACES 20' QUEUING AT EXIT: PROVIDED OVER 10 SPACES 20' QUEUING AT EXIT: PROVIDED NUMBER OF COMPACT SPACES / %: NONE / 0% NUMBER OF HANDICAPPED SPACES: 4 SIDEWALKS REQUIRED: INTERNAL PROVIDED PUBLIC PROVIDED UNUMBER OF HANDICAPPED SPACES: 4 SIDEWALKS REQUIRED: INTERNAL PROVIDED PUBLIC PROVIDED DUFFER YARD ADJUSTMENT: NONE REQUIRED STANDARD FOR 4 OR MORE LANES: NONE REQUIRED STANDARD FOR 4 OR MORE LANES: NONE REQUIRED STANDARD FOR LESS THAN FOUR LANES: PROVIDED STANDARD FOR LESS THAN FOUR LANES: NONE REQUIRED STANDARD FOR LESS THAN FOUR LANES: NONE REQUIRED STANDARD FOR LESS THAN FOUR LANES: PROVIDED SIDE LINES ADJACENT TO PARKING AREAS 5' MINIMUM WIDTH W/ TREES - 2.5' W/ TREE ISLANDS: NONE REQUIRED STANDARD FOR LESS THAN FOUR LANES: PROVIDED SCREENING AROUND DUMPSTERS (NO CHAIN LINK FENCE PERMITTED): PROVIDED SCREENING AROUND DUMPSTERS (NO CHAIN LINK FENCE PERMITTED): PROVIDED		
SIREET SETBACK / STREET TYPE(S): 40 FT. REAR YARD: 20 FT. HEIGHT STANDARDS: 2:1 NUMBER OF FLOORS: 4 PARKING AND ACCESS — CHAPTER 17.20 **SUPPLEMENTAL CHECKLIST ALSO REQUIRED FOR UDO** RAMP LOCATION AND NUMBER: ONE SOUTHWEST DISTANCE TO INTERSECTIONS 50' MINOR STREET: 400 FT. 185' ARTERIAL STREET: NONE 100' COLLECTOR: NONE 250' CONTROLLED ACCESS RAMP: NONE REQUIRED PARKING BASED ON USE: 88 REQUIRED 90 PROVIDED REQUIRED LOADING BASED ON USE: NONE REQUIRED NONE PROVIDED SURFACING OVER 5 SPACES 1,750 SQ. FT.: PROVIDED SURFACING OVER 5 SPACES 1,750 SQ. FT.: PROVIDED SURFACING OVER 5 SPACES 1,750 SQ. FT.: PROVIDED OVER 10 SPACES 20' QUEUING AT EXIT: PROVIDED OVER 10 SPACES 20' QUEUING AT EXIT: PROVIDED NUMBER OF COMPACT SPACES / %: NONE / 0% NUMBER OF HANDICAPPED SPACES: 4 SIDEWALKS REQUIRED: INTERNAL PROVIDED PUBLIC PROVIDED LANDSCAPING STANDARD — CHAPTER 17.24 **SUPPLEMENTAL CHECKLIST ALSO REQUIRED FOR UDO** REQUIRED BUFFER YARDS: NONE REQUIRED BUFFER YARD ADJUSTMENT: NONE REQUIRED STANDARD FOR 4 OR MORE LANES: NONE REQUIRED STANDARD FOR LESS THAN FOUR LANES: NONE REQUIRED STANDARD FOR LESS THAN FOUR LANES: NONE REQUIRED STANDARD FOR LESS THAN FOUR LANES: NONE REQUIRED SIDE LINES ADJACENT TO PARKING AREAS 5' MINIMUM WIDTH W/ TREES — 2.5' W/ TREE ISLANDS: NONE REQUIRED SCREENING AROUND DUMPSTERS (NO CHAIN LINK FENCE PERMITTED): PROVIDED SCREENING AROUND DUMPSTERS (NO CHAIN LINK FENCE PERMITTED): PROVIDED TREE DENSITY:	ISR - ADJUSTMENTS / SLOPES OVER 11% 0.80% MAXIMUM 0.80% REQUESTING	
SIDE YARD: 20 FT. REAR YARD: 20 FT. HEIGHT STANDARDS: 2:1 NUMBER OF FLOORS: 4 PARKING AND ACCESS — CHAPTER 17.20 **SUPPLEMENTAL CHECKLIST ALSO REQUIRED FOR UDO** RAMP LOCATION AND NUMBER: ONE SOUTHWEST DISTANCE TO NEAREST EXISTING RAMP (MINIMUM 30'): 30+ FT. DISTANCE TO INTERSECTIONS 50' MINOR STREET: 400 FT. 185' ARTERIAL STREET: NONE 100' COLLECTOR: NONE 250' CONTROLLED ACCESS RAMP: NONE REQUIRED PARKING BASED ON USE: 88 REQUIRED 90 PROVIDED REQUIRED LOADING BASED ON USE: NONE REQUIRED NONE PROVIDED SUPFACING OVER 5 SPACES 1,750 SQ. FT.: PROVIDED SPACE SIZES, AISLE WIDTHS, ANGLE DATA: 9 FTX18 FT, 24 FT, 90' QUEUING LANES: PROVIDED OVER 10 SPACES 20' QUEUING AT EXIT: PROVIDED NUMBER OF COMPACT SPACES / %: NONE / 0% NUMBER OF HANDICAPPED SPACES: 4 SIDEWALKS REQUIRED: INTERNAL PROVIDED PUBLIC PROVIDED LANDSCAPING STANDARD — CHAPTER 17.24 **SUPPLEMENTAL CHECKLIST ALSO REQUIRED FOR UDO** REQUIRED BUFFER YARDS: NONE REQUIRED DUFFER YARD ADJUSTMENT: NONE REQUIRED STANDARD FOR 4 OR MORE LANES: NONE REQUIRED STANDARD FOR LESS THAN FOUR LANES: PROVIDED STANDARD FOR LESS THAN FOUR LANES: PROVIDED SIDE LINES ADJACENT TO PARKING AREA: PROVIDED SCREENING AROUND DUMPSTERS (NO CHAIN LINK FENCE PERMITTED): PROVIDED SCREENING AROUND DUMPSTERS (NO CHAIN LINK FENCE PERMITTED): PROVIDED TREE DENSITY:	STREET SETBACK / STREET TYPE(S): 40 FT.	
HEIGHT STANDARDS: 2:1 NUMBER OF FLOORS: 4 PARKING AND ACCESS — CHAPTER 17.20 **SUPPLEMENTAL CHECKLIST ALSO REQUIRED FOR UDO** RAMP LOCATION AND NUMBER: ONE SOUTHWEST DISTANCE TO NEAREST EXISTING RAMP (MINIMUM 30'): 30+ FT. DISTANCE TO INTERSECTIONS 50' MINOR STREET: 400 FT. 100' COLLECTOR: NONE 100' COLLECTOR: NONE 250' CONTROLLED ACCESS RAMP: NONE REQUIRED PARKING BASED ON USE: 88 REQUIRED 90 PROVIDED REQUIRED LOADING BASED ON USE: NONE REQUIRED NONE PROVIDED SURFACING OVER 5 SPACES 1,750 SQ. FT.: PROVIDED SPACE SIZES, AISLE WIDTHS, ANGLE DATA: 9 FTX18 FT, 24 FT, 90' QUEUING LANES: PROVIDED OVER 10 SPACES 20' QUEUING AT EXIT: PROVIDED NUMBER OF COMPACT SPACES / %: NONE / 0% NUMBER OF HANDICAPPED SPACES: 4 SIDEWALKS REQUIRED: INTERNAL PROVIDED PUBLIC PROVIDED LANDSCAPING STANDARD — CHAPTER 17.24 **SUPPLEMENTAL CHECKLIST ALSO REQUIRED FOR UDO** REQUIRED BUFFER YARDS: NONE REQUIRED BUFFER YARD ADJUSTMENT: NONE REQUIRED STANDARD FOR 4 OR MORE LANES: NONE REQUIRED STANDARD FOR 4 OR MORE LANES: NONE REQUIRED STANDARD FOR LESS THAN FOUR LANES: PROVIDED SIDE UNIES ADJACENT TO PARKING AREAS 5' MINIMUM WIDTH W/ TREES — 2.5' W/ TREE ISLANDS: NONE REQUIRED INTERNAL DIVISION OF A STANDARD HOR LESS THAN FOUR LANES: PROVIDED SCREENING AROUND DUMPSTERS (NO CHAIN LINK FENCE PERMITTED): PROVIDED SCREENING AROUND DUMPSTERS (NO CHAIN LINK FENCE PERMITTED): PROVIDED TREE DENSITY:		
PARKING AND ACCESS - CHAPTER 17.20 **SUPPLEMENTAL CHECKLIST ALSO REQUIRED FOR UDO** RAMP LOCATION AND NUMBER: ONE SOUTHWEST DISTANCE TO NEAREST EXISTING RAMP (MINIMUM 30'): 30+ FT. DISTANCE TO INTERSECTIONS 50' MINOR STREET: 400 FT. 185' ARTERIAL STREET: NONE 100' COLLECTOR: NONE 250' CONTROLLED ACCESS RAMP: NONE REQUIRED PARKING BASED ON USE: 88 REQUIRED 90 PROWIDED REQUIRED LOADING BASED ON USE: NONE REQUIRED NONE PROVIDED SURFACING OVER 5 SPACES 1,750 SQ. FT.: PROVIDED SPACE SIZES, AISLE WIDTHS, ANGLE DATA: 9 FTX18 FT, 24 FT, 90' QUEUING LANES: PROVIDED OVER 10 SPACES 20' QUEUING AT EXIT: PROVIDED NUMBER OF COMPACT SPACES / %: NONE / 0% NUMBER OF HANDICAPPED SPACES: 4 SIDEWALKS REQUIRED: INTERNAL PROVIDED PUBLIC PROVIDED LANDSCAPING STANDARD - CHAPTER 17.24 **SUPPLEMENTAL CHECKLIST ALSO REQUIRED FOR UDO** REQUIRED BUFFER YARDS: NONE REQUIRED STANDARD FOR 4 OR MORE LANES: NONE REQUIRED STANDARD FOR LESS THAN FOUR LANES: PROVIDED INTERNOR MINIMUM 8% AREA: PROVIDED OPAQUE FENCE ADJACENT TO PARKING AREAS 5' MINIMUM WIDTH W/ TREES - 2.5' W/ TREE ISLANDS: NONE REQUIRED INTERNOR MINIMUM 8% AREA: PROVIDED OPAQUE FENCE ADJACENT TO RESIDENTIAL IN PARKING AREA: NONE REQUIRED SCREENING AROUND DUMPSTERS (NO CHAIN LINK FENCE PERMITTED): PROVIDED TREE DENSITY:	REAR YARD: 20 FT.	
RAMP LOCATION AND NUMBER: ONE SOUTHWEST DISTANCE TO NEAREST EXISTING RAMP (MINIMUM 30'): 30+ FT. DISTANCE TO INTERSECTIONS 50' MINOR STREET: 400 FT. 185' ARTERIAL STREET: NONE 100' COLLECTOR: NONE 250' CONTROLLED ACCESS RAMP: NONE REQUIRED PARKING BASED ON USE: 88 REQUIRED 90 PROVIDED REQUIRED LOADING BASED ON USE: NONE REQUIRED NONE PROVIDED SURFACING OVER 5 SPACES 1,750 SQ. FT.: PROVIDED SPACE SIZES, AISLE WIDTHS, ANGLE DATA: 9 FTX18 FT, 24 FT, 90' QUEUING LANES: PROVIDED OVER 10 SPACES 20' QUEUING AT EXIT: PROVIDED NUMBER OF COMPACT SPACES / %: NONE / 0% NUMBER OF HANDICAPPED SPACES: 4 SIDEWALKS REQUIRED: INTERNAL PROVIDED PUBLIC PROVIDED LANDSCAPING STANDARD - CHAPTER 17.24 **SUPPLEMENTAL CHECKLIST ALSO REQUIRED FOR UDO** REQUIRED BUFFER YARDS: NONE REQUIRED BUFFER YARD ADJUSTMENT: NONE REQUIRED STANDARD FOR 4 OR MORE LANES: NONE REQUIRED STANDARD FOR 4 OR MORE LANES: NONE REQUIRED STANDARD FOR LESS THAN FOUR LANES: PROVIDED STANDARD FOR LESS THAN FOUR LANES: PROVIDED STANDARD FOR LESS THAN FOUR LANES: PROVIDED OPAQUE FENCE ADJACENT TO PARKING AREAS 5' MINIMUM WIDTH W/ TREES - 2.5' W/ TREE ISLANDS: NONE REQUIRED INTERIOR LANDSCAPING MINIMUM 8% AREA: PROVIDED OPAQUE FENCE ADJACENT TO RESIDENTIAL IN PARKING AREA: NONE REQUIRED SCREENING AROUND DUMPSTERS (NO CHAIN LINK FENCE PERMITTED): PROVIDED TREE DENSITY:	HEIGHT STANDARDS: 2:1 NUMBER OF FLOORS: 4	
DISTANCE TO NEAREST EXISTING RAMP (MINIMUM 30'): 30+ FT. DISTANCE TO INTERSECTIONS 50' MINOR STREET: 400 FT. 185' ARTERIAL STREET: NONE 100' COLLECTOR: NONE 250' CONTROLLED ACCESS RAMP: NONE REQUIRED PARKING BASED ON USE: 88 REQUIRED 90 PROVIDED REQUIRED LOADING BASED ON USE: NONE REQUIRED NONE PROVIDED SURFACING OVER 5 SPACES 1,750 SQ. FT.: PROVIDED SPACE SIZES, AISLE WIDTHS, ANGLE DATA: 9 FTX18 FT, 24 FT, 90' QUEUING LANES: PROVIDED OVER 10 SPACES 20' QUEUING AT EXIT: PROVIDED NUMBER OF COMPACT SPACES / %: NONE / 0% NUMBER OF HANDICAPPED SPACES: 4 SIDEWALKS REQUIRED: INTERNAL PROVIDED PUBLIC PROVIDED LANDSCAPING STANDARD - CHAPTER 17.24 **SUPPLEMENTAL CHECKLIST ALSO REQUIRED FOR UDO** REQUIRED BUFFER YARDS: NONE REQUIRED BUFFER YARD ADJUSTMENT: NONE REQUIRED PERIMETER LANDSCAPING (CAN NOT BE OVER FUTURE R.O.W.): NONE REQUIRED STANDARD FOR 4 OR MORE LANES: NONE REQUIRED STANDARD FOR LESS THAN FOUR LANES: PROVIDED STANDARD FOR LESS THAN FOUR LANES: PROVIDED OPAQUE FENCE ADJACENT TO PARKING AREAS 50' MINIMUM WIDTH W/ TREES - 2.5' W/ TREE ISLANDS: NONE REQUIRED INTERIOR LANDSCAPING MINIMUM 8% AREA: PROVIDED OPAQUE FENCE ADJACENT TO RESIDENTIAL IN PARKING AREA: NONE REQUIRED SCREENING AROUND DUMPSTERS (NO CHAIN LINK FENCE PERMITTED): PROVIDED TREE DENSITY:		
DISTANCE TO INTERSECTIONS 50' MINOR STREET: 400 FT. 100' COLLECTOR: NONE 250' CONTROLLED ACCESS RAMP: NONE REQUIRED PARKING BASED ON USE: 88 REQUIRED 90 PROVIDED REQUIRED LOADING BASED ON USE: NONE REQUIRED NONE PROVIDED SURFACING OVER 5 SPACES 1,750 SQ. FT.: PROVIDED SPACE SIZES, AISLE WIDTHS, ANGLE DATA: 9 FTx18 FT, 24 FT, 90' QUEUING LANES: PROVIDED OVER 10 SPACES 20' QUEUING AT EXIT: PROVIDED NUMBER OF COMPACT SPACES / %: NONE / 0% NUMBER OF COMPACT SPACES / %: NONE / 0% NUMBER OF HANDICAPPED SPACES: 4 SIDEWALKS REQUIRED: INTERNAL PROVIDED PUBLIC PROVIDED LANDSCAPING STANDARD - CHAPTER 17.24 **SUPPLEMENTAL CHECKLIST ALSO REQUIRED FOR UDO** REQUIRED BUFFER YARDS: NONE REQUIRED BUFFER YARD ADJUSTMENT: NONE REQUIRED PERIMETER LANDSCAPING (CAN NOT BE OVER FUTURE R.O.W.): NONE REQUIRED STANDARD FOR 4 OR MORE LANES: NONE REQUIRED STANDARD FOR LESS THAN FOUR LANES: PROVIDED SIDE LINES ADJACENT TO PARKING AREAS 5' MINIMUM WIDTH W/ TREES - 2.5' W/ TREE ISLANDS: NONE REQUIRED INTERIOR LANDSCAPING MINIMUM 8% AREA: PROVIDED SOPAQUE FENCE ADJACENT TO RESIDENTIAL IN PARKING AREA: NONE REQUIRED SCREENING AROUND DUMPSTERS (NO CHAIN LINK FENCE PERMITTED): PROVIDED TREE DENSITY:		
100' COLLECTOR: NONE 250' CONTROLLED ACCESS RAMP: NONE REQUIRED PARKING BASED ON USE: 88 REQUIRED 90 PROVIDED REQUIRED LOADING BASED ON USE: NONE REQUIRED NONE PROVIDED SURFACING OVER 5 SPACES 1,750 SQ. FT.: PROVIDED SPACE SIZES, AISLE WIDTHS, ANGLE DATA: 9 FTx18 FT, 24 FT, 90' QUEUING LANES: PROVIDED OVER 10 SPACES 20' QUEUING AT EXIT: PROVIDED NUMBER OF COMPACT SPACES / %: NONE / 0% NUMBER OF HANDICAPPED SPACES: 4 SIDEWALKS REQUIRED: INTERNAL PROVIDED PUBLIC PROVIDED LANDSCAPING STANDARD — CHAPTER 17.24 **SUPPLEMENTAL CHECKLIST ALSO REQUIRED FOR UDO** REQUIRED BUFFER YARDS: NONE REQUIRED BUFFER YARD ADJUSTMENT: NONE REQUIRED BUFFER LANDSCAPING (CAN NOT BE OVER FUTURE R.O.W.): NONE REQUIRED STANDARD FOR 4 OR MORE LANES: NONE REQUIRED STANDARD FOR LESS THAN FOUR LANES: PROVIDED SIDE LINES ADJACENT TO PARKING AREAS 5' MINIMUM WIDTH W/ TREES — 2.5' W/ TREE ISLANDS: NONE REQUIRED INTERIOR LANDSCAPING MINIMUM 8% AREA: PROVIDED OPAQUE FENCE ADJACENT TO RESIDENTIAL IN PARKING AREA: NONE REQUIRED SCREENING AROUND DUMPSTERS (NO CHAIN LINK FENCE PERMITTED): PROVIDED TREE DENSITY:	DISTANCE TO NEAREST EXISTING RAMP (MINIMUM 30'): 30+ FT.	
REQUIRED PARKING BASED ON USE: 88 REQUIRED 90 PROVIDED REQUIRED LOADING BASED ON USE: NONE REQUIRED NONE PROVIDED SURFACING OVER 5 SPACES 1,750 SQ. FT.: PROVIDED SPACE SIZES, AISLE WIDTHS, ANGLE DATA: 9 FTx18 FT, 24 FT, 90* QUEUING LANES: PROVIDED OVER 10 SPACES 20' QUEUING AT EXIT: PROVIDED NUMBER OF COMPACT SPACES / %: NONE / 0% NUMBER OF HANDICAPPED SPACES: 4 SIDEWALKS REQUIRED: INTERNAL PROVIDED PUBLIC PROVIDED LANDSCAPING STANDARD - CHAPTER 17.24 **SUPPLEMENTAL CHECKLIST ALSO REQUIRED FOR UDO*** REQUIRED BUFFER YARDS: NONE REQUIRED BUFFER YARD ADJUSTMENT: NONE REQUIRED BUFFER LANDSCAPING (CAN NOT BE OVER FUTURE R.O.W.): NONE REQUIRED STANDARD FOR 4 OR MORE LANES: NONE REQUIRED STANDARD FOR LESS THAN FOUR LANES: PROVIDED SIDE LINES ADJACENT TO PARKING AREAS 5' MINIMUM WIDTH W/ TREES - 2.5' W/ TREE ISLANDS: NONE REQUIRED INTERIOR LANDSCAPING MINIMUM 8% AREA: PROVIDED OPAQUE FENCE ADJACENT TO RESIDENTIAL IN PARKING AREA: NONE REQUIRED SCREENING AROUND DUMPSTERS (NO CHAIN LINK FENCE PERMITTED): PROVIDED TREE DENSITY:	DISTANCE TO INTERSECTIONS 50' MINOR STREET: 400 FT. 185' ARTERIAL STREET: NONE	
REQUIRED LOADING BASED ON USE: NONE REQUIRED NONE PROVIDED SURFACING OVER 5 SPACES 1,750 SQ. FT.: PROVIDED SPACE SIZES, AISLE WIDTHS, ANGLE DATA: 9 FTx18 FT, 24 FT, 90* QUEUING LANES: PROVIDED OVER 10 SPACES 20' QUEUING AT EXIT: PROVIDED NUMBER OF COMPACT SPACES / %: NONE / 0% NUMBER OF HANDICAPPED SPACES: 4 SIDEWALKS REQUIRED: INTERNAL PROVIDED PUBLIC PROVIDED LANDSCAPING STANDARD - CHAPTER 17.24 **SUPPLEMENTAL CHECKLIST ALSO REQUIRED FOR UDO** REQUIRED BUFFER YARDS: NONE REQUIRED BUFFER YARD ADJUSTMENT: NONE REQUIRED PERIMETER LANDSCAPING (CAN NOT BE OVER FUTURE R.O.W.): NONE REQUIRED STANDARD FOR 4 OR MORE LANES: NONE REQUIRED STANDARD FOR LESS THAN FOUR LANES: PROVIDED SIDE LINES ADJACENT TO PARKING AREAS 5' MINIMUM WIDTH W/ TREES - 2.5' W/ TREE ISLANDS: NONE REQUIRED INTERIOR LANDSCAPING MINIMUM 8% AREA: PROVIDED OPAQUE FENCE ADJACENT TO RESIDENTIAL IN PARKING AREA: NONE REQUIRED SCREENING AROUND DUMPSTERS (NO CHAIN LINK FENCE PERMITTED): PROVIDED TREE DENSITY:		
REQUIRED LOADING BASED ON USE: NONE REQUIRED NONE PROVIDED SURFACING OVER 5 SPACES 1,750 SQ. FT.: PROVIDED SPACE SIZES, AISLE WIDTHS, ANGLE DATA: 9 FTx18 FT, 24 FT, 90* QUEUING LANES: PROVIDED OVER 10 SPACES 20' QUEUING AT EXIT: PROVIDED NUMBER OF COMPACT SPACES / %: NONE / 0% NUMBER OF HANDICAPPED SPACES: 4 SIDEWALKS REQUIRED: INTERNAL PROVIDED PUBLIC PROVIDED LANDSCAPING STANDARD - CHAPTER 17.24 **SUPPLEMENTAL CHECKLIST ALSO REQUIRED FOR UDO** REQUIRED BUFFER YARDS: NONE REQUIRED BUFFER YARD ADJUSTMENT: NONE REQUIRED PERIMETER LANDSCAPING (CAN NOT BE OVER FUTURE R.O.W.): NONE REQUIRED STANDARD FOR 4 OR MORE LANES: NONE REQUIRED STANDARD FOR LESS THAN FOUR LANES: PROVIDED SIDE LINES ADJACENT TO PARKING AREAS 5' MINIMUM WIDTH W/ TREES - 2.5' W/ TREE ISLANDS: NONE REQUIRED INTERIOR LANDSCAPING MINIMUM 8% AREA: PROVIDED OPAQUE FENCE ADJACENT TO RESIDENTIAL IN PARKING AREA: NONE REQUIRED SCREENING AROUND DUMPSTERS (NO CHAIN LINK FENCE PERMITTED): PROVIDED TREE DENSITY:	REQUIRED PARKING BASED ON USE: 88 REQUIRED 90 PROVIDED	
SPACE SIZES, AISLE WIDTHS, ANGLE DATA: 9 FTx18 FT, 24 FT, 90° QUEUING LANES: PROVIDED OVER 10 SPACES 20' QUEUING AT EXIT: PROVIDED NUMBER OF COMPACT SPACES / %: NONE / 0% NUMBER OF HANDICAPPED SPACES: 4 SIDEWALKS REQUIRED: INTERNAL PROVIDED PUBLIC PROVIDED LANDSCAPING STANDARD - CHAPTER 17.24 **SUPPLEMENTAL CHECKLIST ALSO REQUIRED FOR UDO** REQUIRED BUFFER YARDS: NONE REQUIRED BUFFER YARD ADJUSTMENT: NONE REQUIRED PERIMETER LANDSCAPING (CAN NOT BE OVER FUTURE R.O.W.): NONE REQUIRED STANDARD FOR 4 OR MORE LANES: NONE REQUIRED STANDARD FOR LESS THAN FOUR LANES: PROVIDED SIDE LINES ADJACENT TO PARKING AREAS 5' MINIMUM WIDTH W/ TREES - 2.5' W/ TREE ISLANDS: NONE REQUIRED INTERIOR LANDSCAPING MINIMUM 8% AREA: PROVIDED OPAQUE FENCE ADJACENT TO RESIDENTIAL IN PARKING AREA: NONE REQUIRED SCREENING AROUND DUMPSTERS (NO CHAIN LINK FENCE PERMITTED): PROVIDED TREE DENSITY:	REQUIRED LOADING BASED ON USE: NONE REQUIRED NONE PROVIDED	
QUEUING LANES: PROVIDED OVER 10 SPACES 20' QUEUING AT EXIT: PROVIDED NUMBER OF COMPACT SPACES / %: NONE / 0% NUMBER OF HANDICAPPED SPACES: 4 SIDEWALKS REQUIRED: INTERNAL PROVIDED PUBLIC PROVIDED LANDSCAPING STANDARD — CHAPTER 17.24 **SUPPLEMENTAL CHECKLIST ALSO REQUIRED FOR UDO** REQUIRED BUFFER YARDS: NONE REQUIRED BUFFER YARD ADJUSTMENT: NONE REQUIRED PERIMETER LANDSCAPING (CAN NOT BE OVER FUTURE R.O.W.): NONE REQUIRED STANDARD FOR 4 OR MORE LANES: NONE REQUIRED STANDARD FOR LESS THAN FOUR LANES: PROVIDED SIDE LINES ADJACENT TO PARKING AREAS 5' MINIMUM WIDTH W/ TREES — 2.5' W/ TREE ISLANDS: NONE REQUIRED INTERIOR LANDSCAPING MINIMUM 8% AREA: PROVIDED OPAQUE FENCE ADJACENT TO RESIDENTIAL IN PARKING AREA: NONE REQUIRED SCREENING AROUND DUMPSTERS (NO CHAIN LINK FENCE PERMITTED): PROVIDED TREE DENSITY:	SURFACING OVER 5 SPACES 1,750 SQ. FT.: PROVIDED	
OVER 10 SPACES 20' QUEUING AT EXIT: PROVIDED NUMBER OF COMPACT SPACES / %: NONE / 0% NUMBER OF HANDICAPPED SPACES: 4 SIDEWALKS REQUIRED: INTERNAL PROVIDED PUBLIC PROVIDED LANDSCAPING STANDARD - CHAPTER 17.24 **SUPPLEMENTAL CHECKLIST ALSO REQUIRED FOR UDO** REQUIRED BUFFER YARDS: NONE REQUIRED BUFFER YARD ADJUSTMENT: NONE REQUIRED PERIMETER LANDSCAPING (CAN NOT BE OVER FUTURE R.O.W.): NONE REQUIRED STANDARD FOR 4 OR MORE LANES: NONE REQUIRED STANDARD FOR LESS THAN FOUR LANES: PROVIDED SIDE LINES ADJACENT TO PARKING AREAS 5' MINIMUM WIDTH W/ TREES - 2.5' W/ TREE ISLANDS: NONE REQUIRED INTERIOR LANDSCAPING MINIMUM 8% AREA: PROVIDED OPAQUE FENCE ADJACENT TO RESIDENTIAL IN PARKING AREA: NONE REQUIRED SCREENING AROUND DUMPSTERS (NO CHAIN LINK FENCE PERMITTED): PROVIDED TREE DENSITY:		
NUMBER OF COMPACT SPACES / %: NONE / 0% NUMBER OF HANDICAPPED SPACES: 4 SIDEWALKS REQUIRED: INTERNAL PROVIDED PUBLIC PROVIDED LANDSCAPING STANDARD - CHAPTER 17.24 **SUPPLEMENTAL CHECKLIST ALSO REQUIRED FOR UDO** REQUIRED BUFFER YARDS: NONE REQUIRED BUFFER YARD ADJUSTMENT: NONE REQUIRED PERIMETER LANDSCAPING (CAN NOT BE OVER FUTURE R.O.W.): NONE REQUIRED STANDARD FOR 4 OR MORE LANES: NONE REQUIRED STANDARD FOR LESS THAN FOUR LANES: PROVIDED SIDE LINES ADJACENT TO PARKING AREAS 5' MINIMUM WIDTH W/ TREES - 2.5' W/ TREE ISLANDS: NONE REQUIRED INTERIOR LANDSCAPING MINIMUM 8% AREA: PROVIDED OPAQUE FENCE ADJACENT TO RESIDENTIAL IN PARKING AREA: NONE REQUIRED SCREENING AROUND DUMPSTERS (NO CHAIN LINK FENCE PERMITTED): PROVIDED TREE DENSITY:	QUEUING LANES: PROVIDED	
NUMBER OF HANDICAPPED SPACES: 4 SIDEWALKS REQUIRED: INTERNAL PROVIDED PUBLIC PROVIDED LANDSCAPING STANDARD - CHAPTER 17.24 **SUPPLEMENTAL CHECKLIST ALSO REQUIRED FOR UDO** REQUIRED BUFFER YARDS: NONE REQUIRED BUFFER YARD ADJUSTMENT: NONE REQUIRED PERIMETER LANDSCAPING (CAN NOT BE OVER FUTURE R.O.W.): NONE REQUIRED STANDARD FOR 4 OR MORE LANES: NONE REQUIRED STANDARD FOR LESS THAN FOUR LANES: PROVIDED SIDE LINES ADJACENT TO PARKING AREAS 5' MINIMUM WIDTH W/ TREES - 2.5' W/ TREE ISLANDS: NONE REQUIRED INTERIOR LANDSCAPING MINIMUM 8% AREA: PROVIDED OPAQUE FENCE ADJACENT TO RESIDENTIAL IN PARKING AREA: NONE REQUIRED SCREENING AROUND DUMPSTERS (NO CHAIN LINK FENCE PERMITTED): PROVIDED TREE DENSITY:		
SIDEWALKS REQUIRED: INTERNAL PROVIDED PUBLIC PROVIDED LANDSCAPING STANDARD - CHAPTER 17.24 **SUPPLEMENTAL CHECKLIST ALSO REQUIRED FOR UDO** REQUIRED BUFFER YARDS: NONE REQUIRED BUFFER YARD ADJUSTMENT: NONE REQUIRED PERIMETER LANDSCAPING (CAN NOT BE OVER FUTURE R.O.W.): NONE REQUIRED STANDARD FOR 4 OR MORE LANES: NONE REQUIRED STANDARD FOR LESS THAN FOUR LANES: PROVIDED SIDE LINES ADJACENT TO PARKING AREAS 5' MINIMUM WIDTH W/ TREES - 2.5' W/ TREE ISLANDS: NONE REQUIRED INTERIOR LANDSCAPING MINIMUM 8% AREA: PROVIDED OPAQUE FENCE ADJACENT TO RESIDENTIAL IN PARKING AREA: NONE REQUIRED SCREENING AROUND DUMPSTERS (NO CHAIN LINK FENCE PERMITTED): PROVIDED TREE DENSITY:		
REQUIRED BUFFER YARDS: NONE REQUIRED BUFFER YARD ADJUSTMENT: NONE REQUIRED PERIMETER LANDSCAPING (CAN NOT BE OVER FUTURE R.O.W.): NONE REQUIRED STANDARD FOR 4 OR MORE LANES: NONE REQUIRED STANDARD FOR LESS THAN FOUR LANES: PROVIDED SIDE LINES ADJACENT TO PARKING AREAS 5' MINIMUM WIDTH W/ TREES — 2.5' W/ TREE ISLANDS: NONE REQUIRED INTERIOR LANDSCAPING MINIMUM 8% AREA: PROVIDED OPAQUE FENCE ADJACENT TO RESIDENTIAL IN PARKING AREA: NONE REQUIRED SCREENING AROUND DUMPSTERS (NO CHAIN LINK FENCE PERMITTED): PROVIDED TREE DENSITY:		
REQUIRED BUFFER YARDS: NONE REQUIRED BUFFER YARD ADJUSTMENT: NONE REQUIRED PERIMETER LANDSCAPING (CAN NOT BE OVER FUTURE R.O.W.): NONE REQUIRED STANDARD FOR 4 OR MORE LANES: NONE REQUIRED STANDARD FOR LESS THAN FOUR LANES: PROVIDED SIDE LINES ADJACENT TO PARKING AREAS 5' MINIMUM WIDTH W/ TREES — 2.5' W/ TREE ISLANDS: NONE REQUIRED INTERIOR LANDSCAPING MINIMUM 8% AREA: PROVIDED OPAQUE FENCE ADJACENT TO RESIDENTIAL IN PARKING AREA: NONE REQUIRED SCREENING AROUND DUMPSTERS (NO CHAIN LINK FENCE PERMITTED): PROVIDED TREE DENSITY:	<u>SIDEWALKS REQUIRED: INTERNAL PROVIDED PUBLIC PROVIDED</u>	
BUFFER YARD ADJUSTMENT: NONE REQUIRED PERIMETER LANDSCAPING (CAN NOT BE OVER FUTURE R.O.W.): NONE REQUIRED STANDARD FOR 4 OR MORE LANES: NONE REQUIRED STANDARD FOR LESS THAN FOUR LANES: PROVIDED SIDE LINES ADJACENT TO PARKING AREAS 5' MINIMUM WIDTH W/ TREES - 2.5' W/ TREE ISLANDS: NONE REQUIRED INTERIOR LANDSCAPING MINIMUM 8% AREA: PROVIDED OPAQUE FENCE ADJACENT TO RESIDENTIAL IN PARKING AREA: NONE REQUIRED SCREENING AROUND DUMPSTERS (NO CHAIN LINK FENCE PERMITTED): PROVIDED TREE DENSITY:	LANDSCAPING STANDARD — CHAPTER 17.24 **SUPPLEMENTAL CHECKLIST ALSO REQUIRED FOR UDO**	
PERIMETER LANDSCAPING (CAN NOT BE OVER FUTURE R.O.W.): NONE REQUIRED STANDARD FOR 4 OR MORE LANES: NONE REQUIRED STANDARD FOR LESS THAN FOUR LANES: PROVIDED SIDE LINES ADJACENT TO PARKING AREAS 5' MINIMUM WIDTH W/ TREES — 2.5' W/ TREE ISLANDS: NONE REQUIRED INTERIOR LANDSCAPING MINIMUM 8% AREA: PROVIDED OPAQUE FENCE ADJACENT TO RESIDENTIAL IN PARKING AREA: NONE REQUIRED SCREENING AROUND DUMPSTERS (NO CHAIN LINK FENCE PERMITTED): PROVIDED TREE DENSITY:	REQUIRED BUFFER YARDS: NONE REQUIRED	
STANDARD FOR 4 OR MORE LANES: NONE REQUIRED STANDARD FOR LESS THAN FOUR LANES: PROVIDED SIDE LINES ADJACENT TO PARKING AREAS 5' MINIMUM WIDTH W/ TREES - 2.5' W/ TREE ISLANDS: NONE REQUIRED INTERIOR LANDSCAPING MINIMUM 8% AREA: PROVIDED OPAQUE FENCE ADJACENT TO RESIDENTIAL IN PARKING AREA: NONE REQUIRED SCREENING AROUND DUMPSTERS (NO CHAIN LINK FENCE PERMITTED): PROVIDED TREE DENSITY:		
STANDARD FOR LESS THAN FOUR LANES: PROVIDED SIDE LINES ADJACENT TO PARKING AREAS 5' MINIMUM WIDTH W/ TREES - 2.5' W/ TREE ISLANDS: NONE REQUIRED INTERIOR LANDSCAPING MINIMUM 8% AREA: PROVIDED OPAQUE FENCE ADJACENT TO RESIDENTIAL IN PARKING AREA: NONE REQUIRED SCREENING AROUND DUMPSTERS (NO CHAIN LINK FENCE PERMITTED): PROVIDED TREE DENSITY:		
SIDE LINES ADJACENT TO PARKING AREAS 5' MINIMUM WIDTH W/ TREES — 2.5' W/ TREE ISLANDS: NONE REQUIRED INTERIOR LANDSCAPING MINIMUM 8% AREA: PROVIDED OPAQUE FENCE ADJACENT TO RESIDENTIAL IN PARKING AREA: NONE REQUIRED SCREENING AROUND DUMPSTERS (NO CHAIN LINK FENCE PERMITTED): PROVIDED TREE DENSITY:	STANDARD FOR 4 OR MORE LANES: NONE REQUIRED	
INTERIOR LANDSCAPING MINIMUM 8% AREA: PROVIDED OPAQUE FENCE ADJACENT TO RESIDENTIAL IN PARKING AREA: NONE REQUIRED SCREENING AROUND DUMPSTERS (NO CHAIN LINK FENCE PERMITTED): PROVIDED TREE DENSITY:	STANDARD FOR LESS THAN FOUR LANES: PROVIDED	
OPAQUE FENCE ADJACENT TO RESIDENTIAL IN PARKING AREA: NONE REQUIRED SCREENING AROUND DUMPSTERS (NO CHAIN LINK FENCE PERMITTED): PROVIDED TREE DENSITY:		<u> </u>
SCREENING AROUND DUMPSTERS (NO CHAIN LINK FENCE PERMITTED): PROVIDED TREE DENSITY:		↓
TREE DENSITY:		
•		Щ
ALLED AT AS ADDRESSED THOSE OPENIAL FEATURES PROJURED FOR DO OF AND A LIGHT ALL OPENIAL	TREE DENSITY:	Ш
CHAPTER 17.16 ADDRESSES THUSE SPECIAL FEATURES REQUIRED FOR PC, SE AND A USE. ALL SPECIAL	CHAPTER 17.16 ADDRESSES THOSE SPECIAL FEATURES REQUIRED FOR PC, SE AND A USE. ALL SPECIAL	

REQUIREMENTS ARE TO BE REVIEWED AS PART OF THE ZONING PLAN REVIEW AND SPECIAL FEATURES CHAPTER 17.28 IDENTIFIED ON PLANS. ENVIRONMENTAL AND OPERATIONAL STANDARDS. CHAPTER ADDRESSES DEVELOPMENT STANDARDS FOR ENVIRONMENTALLY SENSITIVE LOTS AND CAN REQUIRE ADDITIONAL CALCULATIONS. IT ALSO

CHAPTER 17.32 ADDRESSES THE NOISE LIGHT, AND OTHER POLLUTIONS CONTROLS ALONG WITH STORAGE OF FLAMMABLE GOODS. CHAPTER 17.36 SIGN REGULATIONS. SIGN PERMITS ARE APPLIED FOR ON SEPARATE APPLICATIONS AND ARE NOT

CHAPTER 17.40 PART OF THE ZONING REVIEW FOR BUILDING PERMIT. THIS SECTION OUTLINES SPECIAL RESTRICTIONS AND ENABLING LANGUAGE FOR OVERLAY DISTRICTS. ADDRESSES THE ADMINISTRATIVE PROVISIONS OF THE CODE ALONG WITH POWERS OF THE BOARD OF

FLOOR	S	1BR	SH	2BR	TOTAL
FIRST					
IL	2	5	_	1	8 UNITS (9 BEDS)
AL	_	-	-	-	-
ا میر ا		I	I	I	04 10070 /04 0500

ı	FIK51					
I	IL	2	5	_	1	8 UNITS (9 BEDS)
١	AL	_	-	-	_	_
	MC	24	_	_	_	24 UNITS (24 BEDS)
	SECOND					
	L	5	11	_	1	17 UNITS (18 BEDS)
	AL	8	10	5	1	24 UNITS (25 BEDŚ)
	THIRD					
	L	5	11	_	1	17 UNITS (18 BEDS)
	AL	6	11	5	1 1	23 UNITS (24 BEDS)
Ī	FOURTH					•
	IL	5	11	_	1	17 UNITS (18 BEDS)
	TOTAL					
	L	17	38	_	4	59 UNITS (63 BEDS)
	AL	14	21	10	2	47 UNITS (49 BEDS)
	MC	24	_	_	_	24 UNITS (24 BEDS)
					•	

GENERAL SITE NOTES:


- 1. THE PURPOSE OF THIS SP IS TO PERMIT AN ASSISTED CARE LIVING FACILITY AND A MAXIMUM OF 59 MULTI-FAMILY RESIDENTIAL UNITS. (SEE TABLE ABOVE)
- 2. FEDERAL COMPLIANCE: ALL DEVELOPMENT WITHIN THE BOUNDARIES OF THIS PLAN MEETS THE REQUIREMENTS OF THE AMERICANS WITH DISABILITIES ACT AND THE FAIR HOUSING ACT. ADA: HTTP://WWW.ADA.GOV U.S. JUSTICE DEPT.: HTTP://WWW.JUSTICE.GOV/CRT/HOUSING/FAIRHOUSING/ABOUT_FAIRHOUSINGACT.HTM
- 3. DIMENSIONS SHOWN ARE TO THE FACE-OF-CURB UNLESS OTHERWISE NOTED.
- 4. REFER TO ARCHITECTURAL PLANS FOR EXACT DIMENSIONS AND LOCATIONS OF UTILITY SERVICE ENTRY LOCATIONS, PORCHES, RAMPS, SIDEWALKS, AND PRECISE BUILDING DIMENSIONS.
- 5. ALL CURB RETURN RADII TO BE A MINIMUM OF 3 FEET UNLESS NOTED OTHERWISE HEREON.
- 6. CONTRACTOR SHALL BE RESPONSIBLE FOR REMOVAL AND DISPOSAL OF ALL DEBRIS, MATERIAL AND RUBBISH RESULTING FROM THE PREVIOUS AND CURRENT DEMOLITION OPERATIONS. DISPOSAL PROCEDURES SHALL BE IN ACCORDANCE WITH ALL LOCAL, STATE, AND FEDERAL REGULATIONS GOVERNING SUCH OPERATIONS.
- THE LOCATION OF ALL PROPERTY LINES AND EXISTING UTILITIES, THE LEGAL DESCRIPTION, TOPOGRAPHIC CONTOURS, AND SPOT ELEVATIONS, AND ALL PHYSICAL FEATURES INCLUDING STRUCTURE LOCATIONS WERE PROVIDED BY: JAMES TERRY & ASSOCIATES, LAND SURVEYORS 2601 ELM HILL PIKE, SUITE R

NASHVILLE, TENNESSEE 37214 PHONE: (615) 490-6920

- 8. THE CONTRACTOR SHALL VERIFY LOCATIONS OF ALL EXISTING UTILITIES (INCLUDING STORM DRAINAGE PIPES OR STRUCTURES) BEFORE COMMENCEMENT OF CONSTRUCTION.
- 9. THE CONTRACTOR SHALL COMPLY WITH ALL PERTINENT PROVISIONS OF THE MANUAL OF ACCIDENT PREVENTION IN CONSTRUCTION ISSUED BY AGC OF AMERICA, INC., AND THE SAFETY AND HEALTH REGULATIONS FOR CONSTRUCTION ISSUED BY THE U.S. DEPARTMENT OF LABOR.
- 10. CONTRACTOR SHALL GIVE ALL NECESSARY NOTICES AND OBTAIN ALL PERMITS.

GENERAL PLAN CONSISTENCY:

- 1. THE EXISTING PROPERTY HAS A SMALL RESIDENTIAL HOUSE ON ONE OF THE TWO LOTS. THE LARGER LOT IS VACANT. THE GENERAL PLAN CALLS FOR THIS PROPERTY BEING DEVELOPED RESIDENTIAL WHICH THE PROPOSED ASSISTED LIVING SITE IS ALLOWED.
- 2. THE NORTHERN PROPERTY LINE OF THE SP ALSO IS THE LINE IN THE GENERAL PLAN WHERE THE PROPERTY TO OUR NORTH IS PLANNED FOR COMMERCIAL USE.

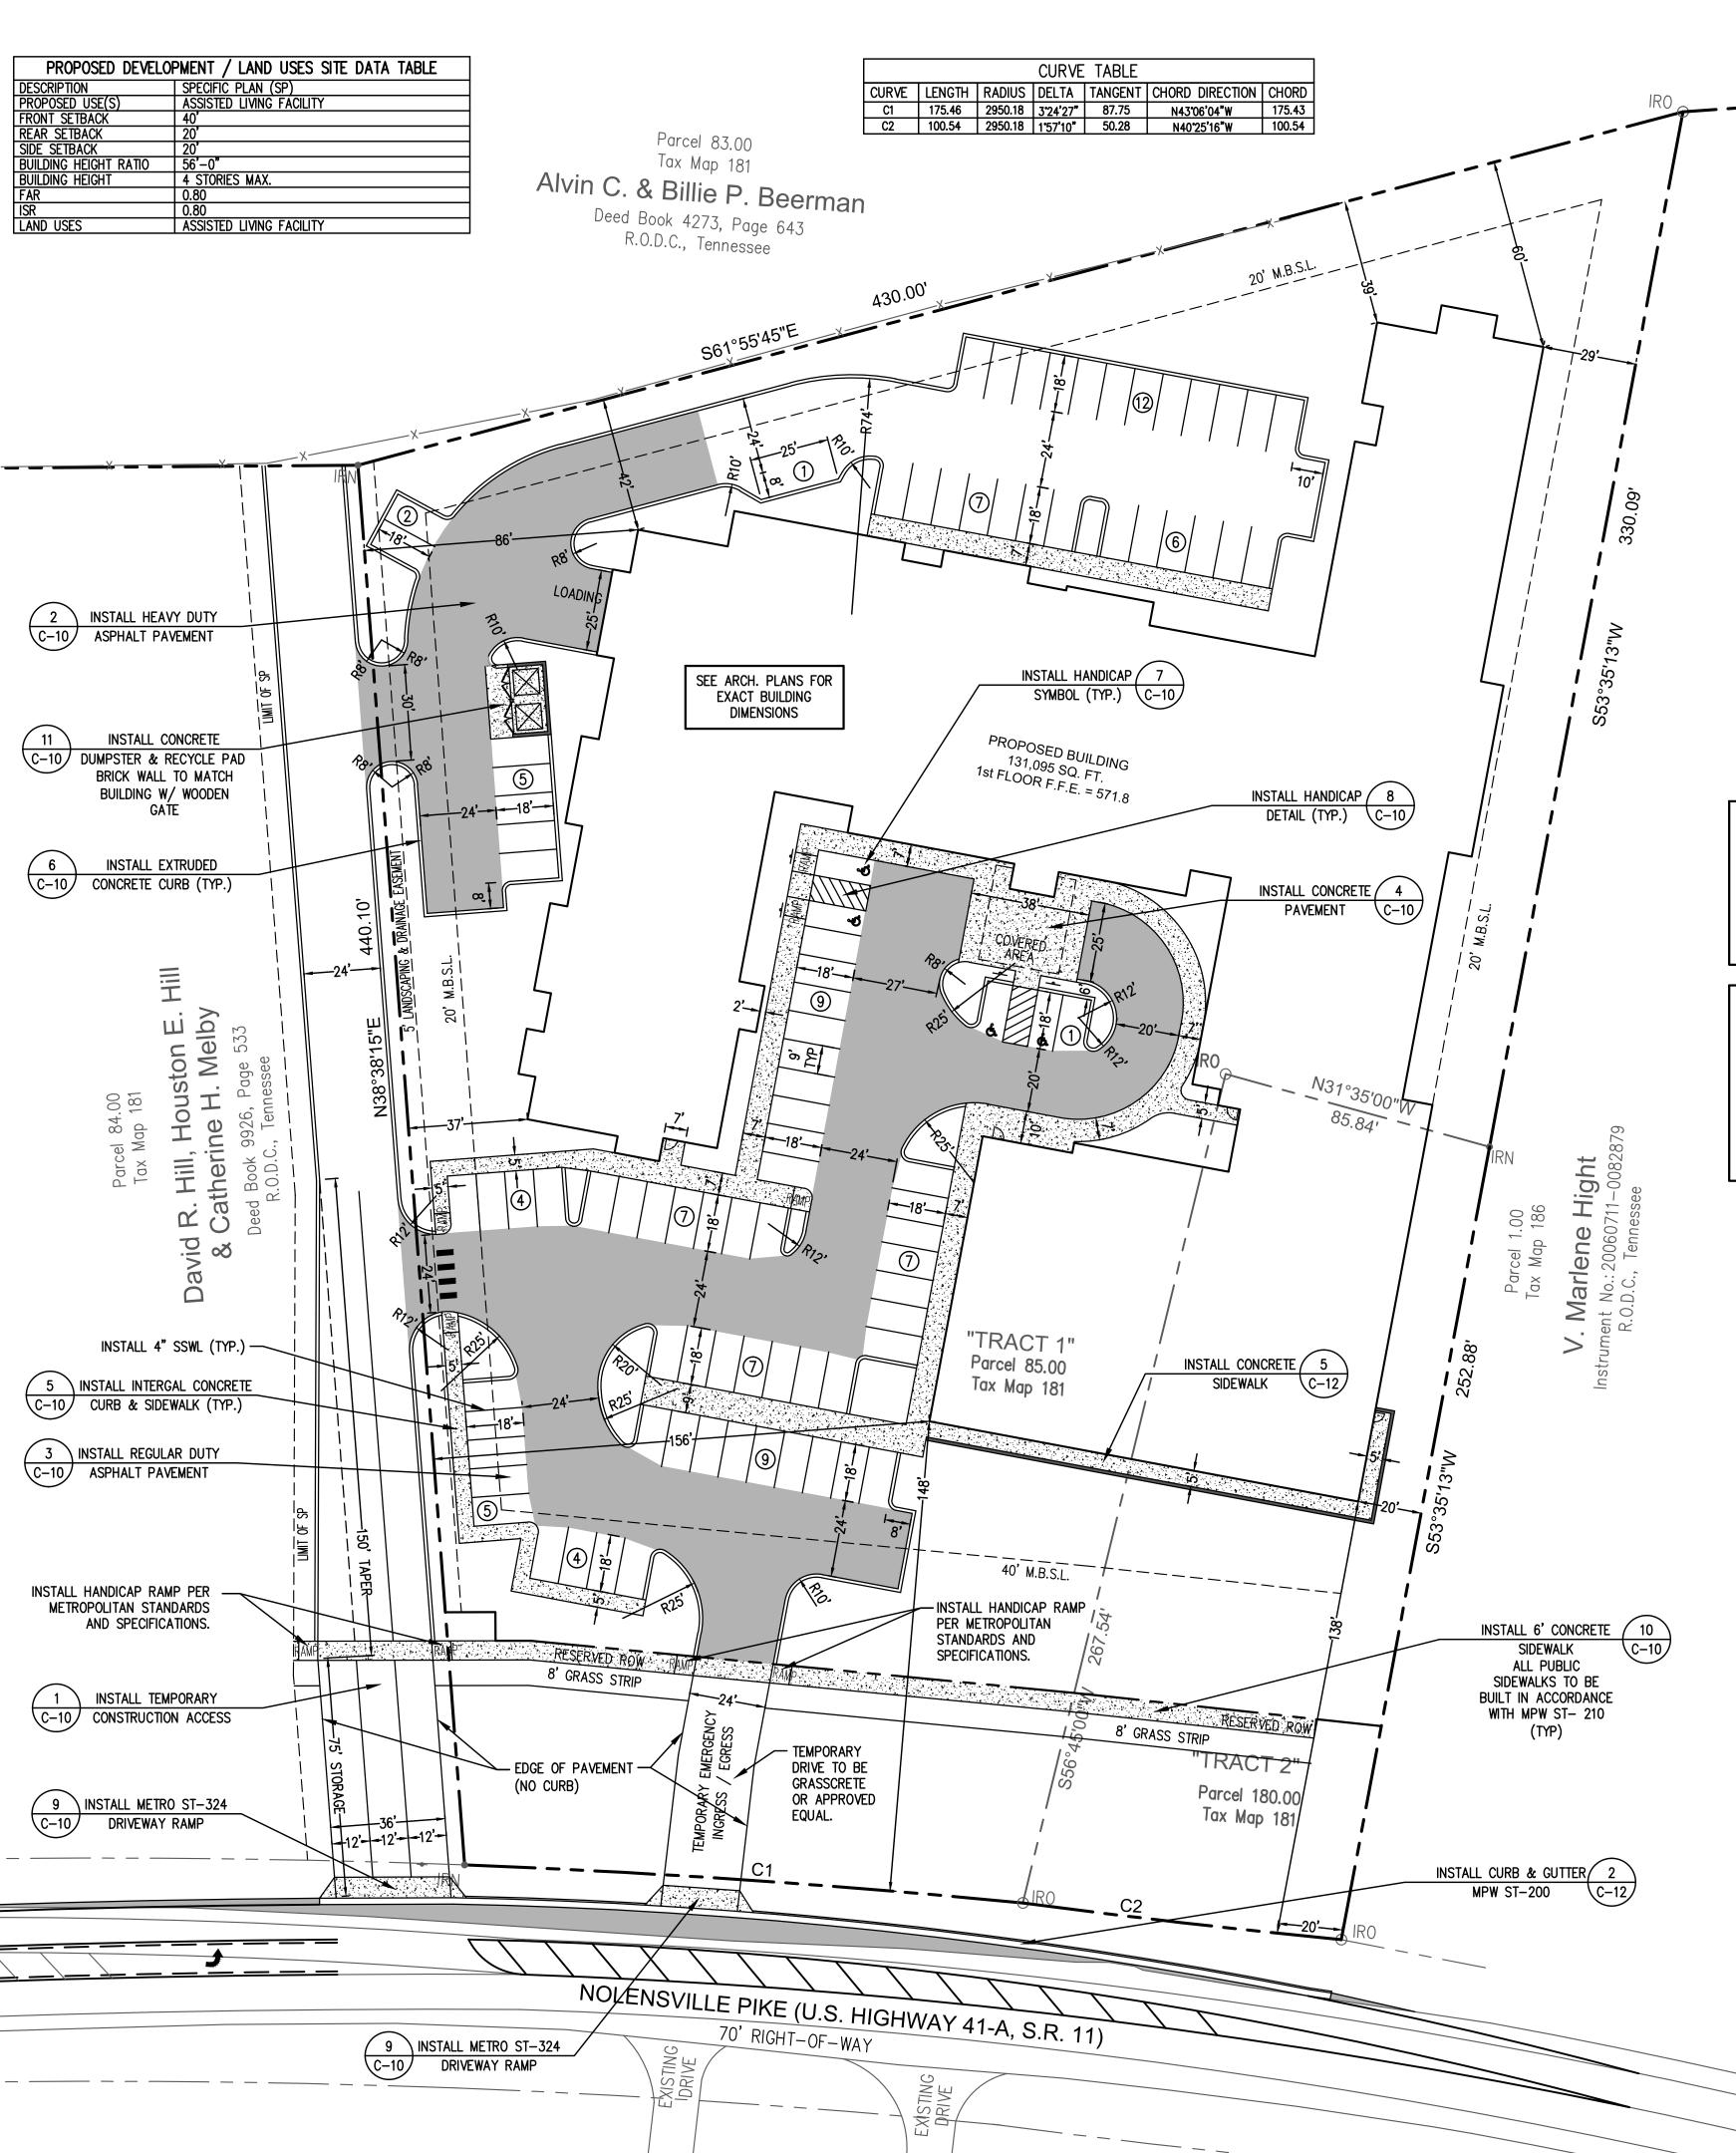

BUILDING MATERIAL LIST

DOORS ·EXTERIOR SERVICE DOORS ARE TO BE FLUSH STEEL DOORS IN GALVANIZED HOLLOW METAL FRAMES. EXTERIOR ENTRY DOORS AND DOORS IN VESTIBULE AT MEMORY CARE TO BE FULL-GLASS STOREFRONT TYPE DOORS.

ENTRY DOORS AT IL/AL ENTRY VESTIBULE ARE TO BE BI-PARTING AUTOMATIC GLASS ENTRY DOORS. EXTERIOR DOORS AT PORCHES AND COURTYARDS ARE TO BE A FIBERGLASS FRENCH STYLE PATIO DOORS.

WINDOWS

EXTERIOR WINDOWS TO BE FIBERGLASS SINGLE-HUNG IN STANDARD FACTORY COLOR. (MARVIN INTEGRITY OR APPROVED · WINDOWS IN MEMORY CARE UNIT TO HAVE OPENING RESTRICTORS

TO PREVENT OPENING BEYOND 4". WALL CLADDING

EXTERIOR WALLS ARE TO BE A COMBINATION OF FIBER CEMENT PANELS (SMOOTH OR BRICK-LOOK) AND FIBER CEMENT LAP-SIDING BOARD AND/OR BOARD AND BATTEN. NICHIHA OR APPROVED SIMILAR.

·TRIM AND SOFFIT MATERIALS ARE TO BE A PAINTED FIBER CEMENT BOARD (NICHIHA OR APPROVED SIMILAR). PER CURRENT ENERGY CODE REQUIREMENTS, EXTERIOR WALLS AT THE AL/IL ARE TO BE INSULATED WITH R-13 BATT INSULATION AND CONTINUOUS R-7.5 RIGID INSULATION AND WALLS AT THE MC ARE TO HAVE R-21(5.25" HIGH-DENSITY) BATT INSULATION.

ROOFING

ROOFING AT MEMORY CARE SLOPES AND GABLES IS TO BE A 20-YEAR FIBERGLASS SHINGLE; FLAT ROOF AREAS TO BE A SINGLE-PLY MEMBRANE. GABLED ROOFS WILL BE DRAINED TO GUTTERS AND DOWNSPOUTS, FLAT ROOF AREAS WILL NEED RAINWATER LEADERS RUN THROUGH THE BUILDING. SLOPED ROOFS WILL BE INSULATED WITH VENTED, INSULATED PANELS ABOVE TRUSSES AND FLAT ROOFS TO HAVE TAPERED RIGID INSULATION BOARDS ON DECKING, CONTINUOUS R-20 AT ALL LOCATIONS.

PORCH CONCRETE FLOOR SLABS ARE TO BE FINISHED WITH A CHEMICAL STAIN PROCESS.


THE FINAL SITE PLAN/ BUILDING PERMIT SITE PLAN SHALL DEPICT THE REQUIRED PUBLIC SIDEWALKS, ANY REQUIRED GRASS STRIP OR FRONTAGE ZONE AND THE LOCATION OF ALL EXISTING AND PROPOSED VERTICAL OBSTRUCTIONS WITHIN THE REQUIRED SIDEWALK AND GRASS STRIP OR FRONTAGE ZONE. PRIOR TO THE ISSUANCE OF USE AND OCCUPANCY PERMITS, EXISTING VERTICAL OBSTRUCTIONS SHALL BE RELOCATED OUTSIDE OF THE REQUIRED SIDEWALK. VERTICAL OBSTRUCTIONS ARE ONLY PERMITTED WITHIN THE REQUIRED GRASS STRIP OR FRONTAGE ZONE.

THE SPECIFIC PLAN PROCESS IS A MULTI-STEP PROCESS. IF THE PRELIMINARY SP IS APPROVED, THERE ARE ADDITIONAL STEPS REQUIRED PRIOR TO ISSUANCE OF A BUILDING PERMIT. THESE STEPS INCLUDE: FINAL SITE PLAN AND BUILDING PERMIT REVIEW. THE FINAL SITE PLAN IS SUBMITTED THROUGH THE NORMAL PLANNING COMMISSION REVIEW PROCESS. FOR BUILDING PERMIT REVIEW, WHEN APPLYING FOR A BUILDING PERMIT YOU MUST SUBMIT 3 COPIES OF PLANS AND A REVIEW FEE OF \$250 DIRECTLY TO THE PLANNING FRONT COUNTER FOR PROCESSING. WE DO NOT NEED THE COMPLETE BUILDING PERMIT SET. PLEASE SUBMIT ONLY SITE PLAN, LANDSCAPING PLAN, GRADING PLAN, AND BUILDING ELEVATIONS.


PARKING SUMMARY

- 86 REGULAR PARKING SPACES
- 4 HANDICAP PARKING SPACES
- 90 TOTAL PARKING SPACES 88 REQUIRED PARKING SPACES
- 1 PER BED FOR 63 INDEPENDENT BEDS
- $(63 \times 1 = 63 \text{ SPACES})$ 1 PER 3 BEDS FOR 73 ASSISTED LIVING & MEMORY CARE BEDS
- (73 / 3 = 25 SPACES)
- = 88 REQUIRED PARKING SPACES


LEGEND

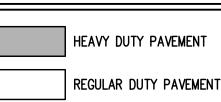

CONCRETE SIDEWALK/PAVEMENT INDICATES NUMBER OF PARKING SPACES IN ROW

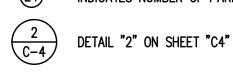

SSWL 4" SINGLE SOLID WHITE LINE

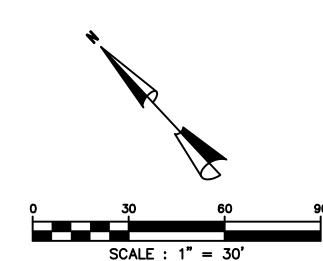

MAP: 181 PARCEL: 85 & 180 **DESCRIPTION** DATE

CASE NO. 2017SP-070-001

TRADITIONS

PRELIMINARY

SP PLAN

6922 NOLENSVILLE PIKE

NASHVILLE, TN

BATSON & ASSOCIATES

Civil Engineering Consultants

5150 REMINGTON DRIVE


BRENTWOOD, TENNESSEE 37027 (615) 424-4840 • FA□ (615) 370-9363


COMMENT	1	19 JUL 201
COMMENT	2	28 JUL 201
PROŒCT NO.		
DATE		28 JUN 201
DRAWN BY		N
CHECKED BY		GM

SITE LAYOUT PLAN

SHEET 2 OF 15



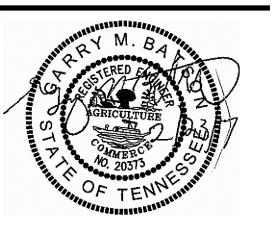

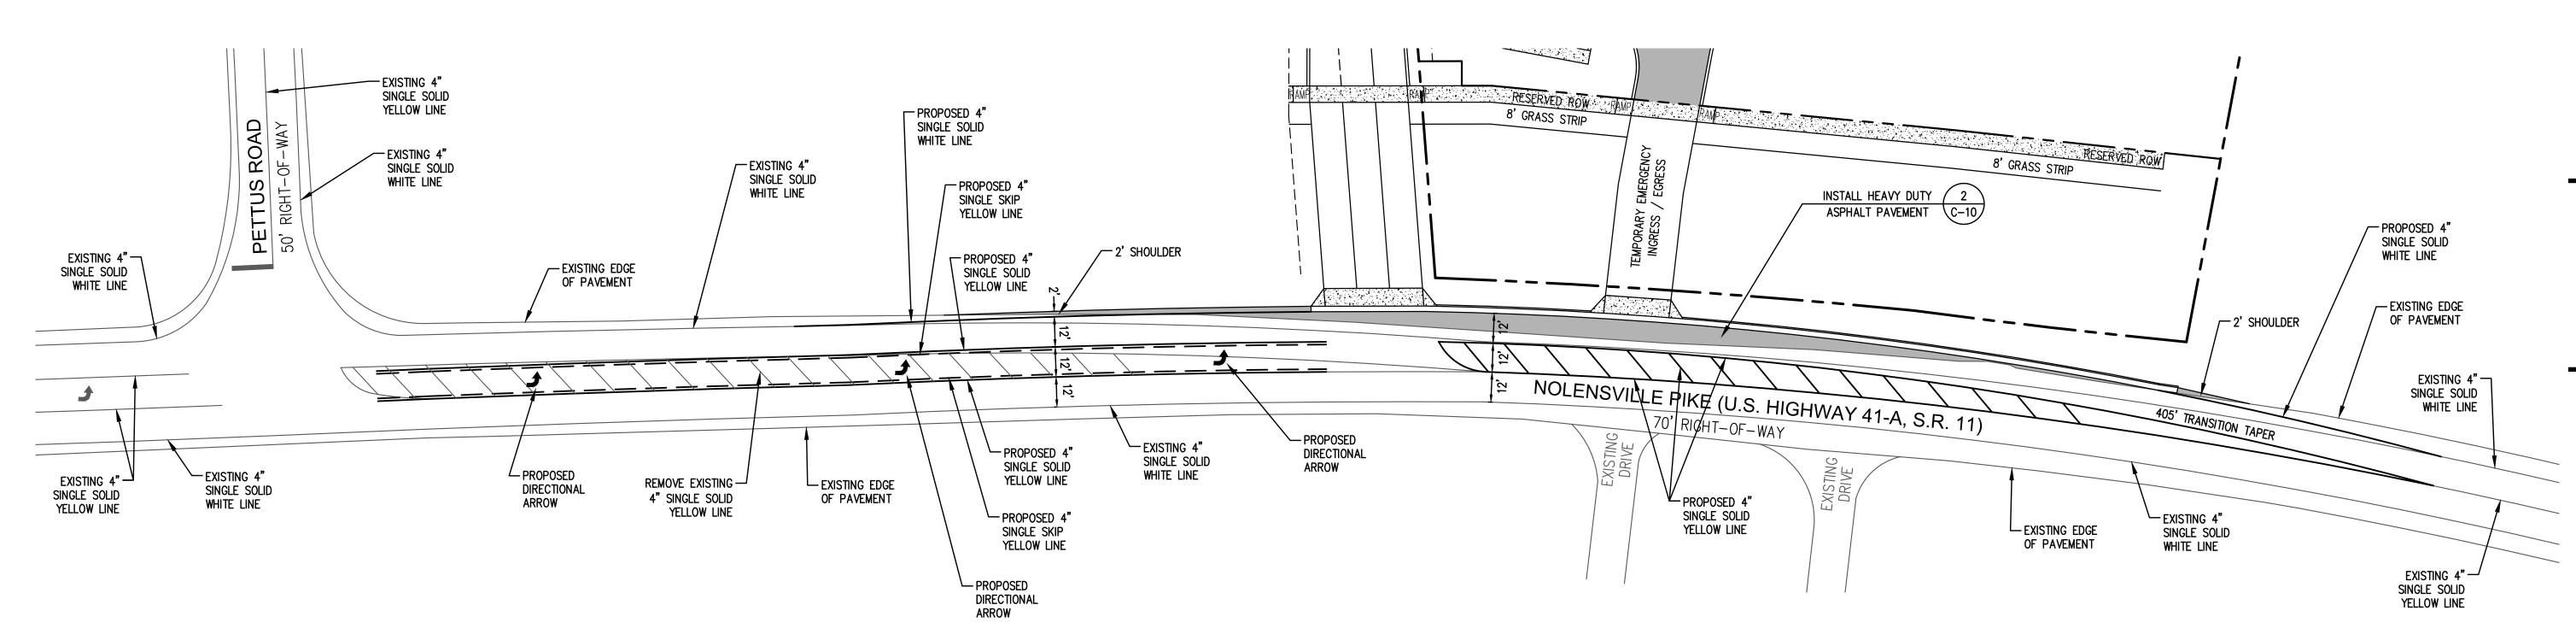

TRANSITION LENGTH = $\frac{\text{WS }^2}{45}$ = $\frac{12 (45)^2}{60}$ = 405' W = 12 FEETS = 45 MPH

SCALE : 1" = 30'

TRADITIONS

PRELIMINARY SP PLAN

6922 NOLENSVILLE PIKE NASHVILLE, TN

CASE NO. 2017SP-070-001 MAP: 181 PARCEL: 85 & 180

COMMENT	1	19 JUL 20
COMMENT	2	28 JUL 20


PROŒCT NO.	
DATE	28 JUN 20
DRAWN BY	
CHECKED BY	G


TURN LANE PLAN

SHEET 3 OF 15


LEGEND

HEAVY DUTY PAVEMENT

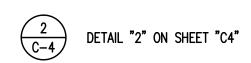

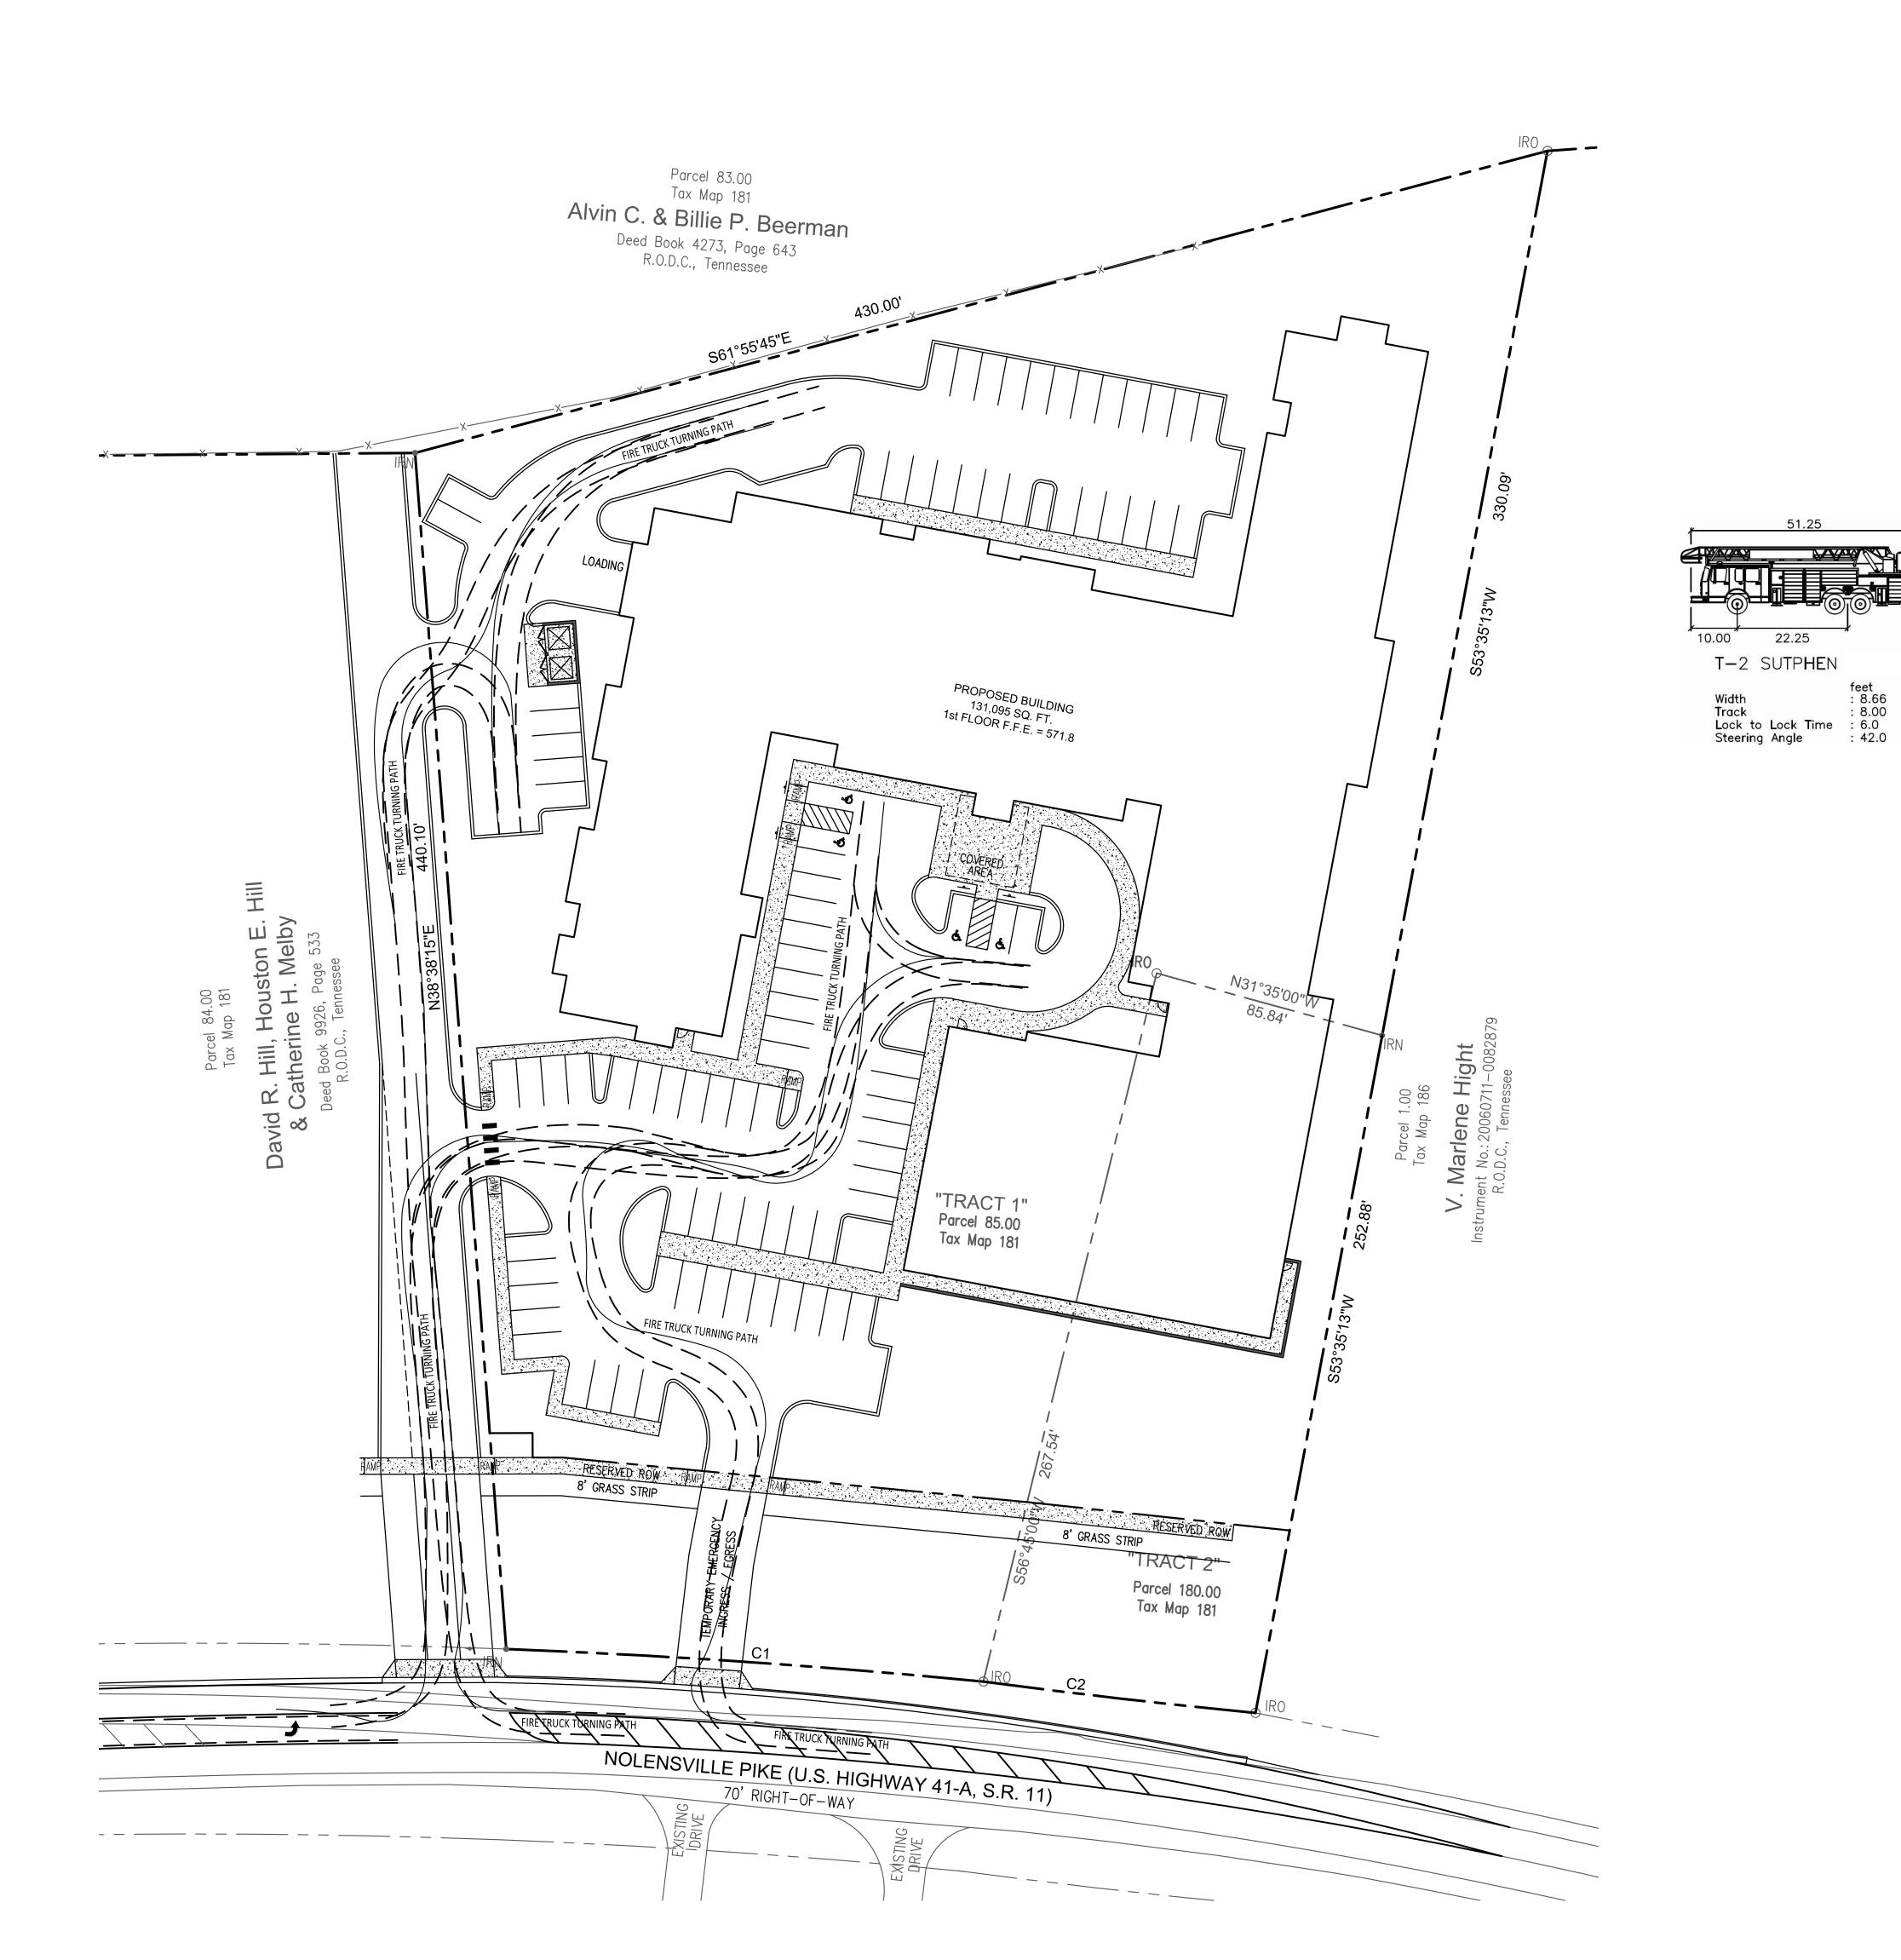



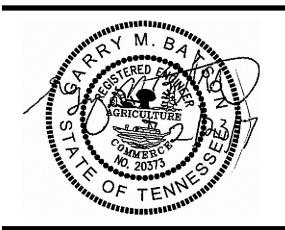

TRADITIONS PRELIMINARY

6922 NOLENSVILLE PIKE NASHVILLE, TN

SP PLAN


CASE NO. 2017SP-070-001 MAP: 181 PARCEL: 85 & 180

DESCRIPTION		DAT
COMMENT	1	19 JUL 20
COMMENT	2	28 JUL 20
PROŒCT NO.		
DATE		28 JUN 20
DRAWN BY		N
CHECKED BY		GN

SITE AUTOTURN PLAN

C-3

SHEET 4 OF 15

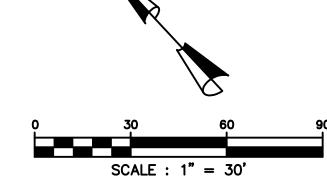

UTILITY COMPANIES: ELECTRIC: NASHVILLE ELECTRIC COMPANY 1214 CHURCH STREET Parcel 83.00 NASHVILLE, TN 37203 Tax Map 181 (615) 747-3855 Alvin C. & Billie P. Beerman WATER AND SANITARY SEWER: Deed Book 4273, Page 643 R.O.D.C., Tennessee METROPOLITAN DEPARTMENT OF WATER AND SEWERAGE 1700 3RD AVENUE NORTH NASHVILLE, TN 37208 (615) 862-8600 NATÚRAL GAS: NASHVILLE GAS 665 MAINSTREAM DRIVE NASHVILLE, TN 37228 (615) 734-0665 TELEPHONE: AT&T (615) 557-6000 CABLE: COMCAST 660 MAINSTREAM DRIVE NASHVILLE, TN 37228 (615) 244-5900 HVAC UNITS ARE SCREENED ON ROOF. PROPOSED BUILDING WATER PLAN NOTES 131,095 SQ. FT. 1st FLOOR F.F.E. = 571.8 1. ALL WATER CONSTRUCTION SHALL BE IN ACCORDANCE WITH SPECIFICATIONS AND STANDARD DETAILS OF THE HARPETH VALLEY UTILITIES DISTRICT. 2. THE DEVELOPER IS RESPONSIBLE FOR REIMBURSING THE HARPETH VALLEY UTILITIES DISTRICT THE COST OF 3. THE CONTRACTOR IS TO PROVIDE AND MAINTAIN THE CONSTRUCTION IDENTIFICATION SIGN FOR PRIVATE DEVELOPMENT APPROVED. 4. REDUCED PRESSURE BACKFLOW PREVENTION DEVICES (RPBP) OR DUAL CHECK VALVE WILL BE REQUIRED ON ALL TEST AND FILL LINES (JUMPER) NEEDED FOR WATER MAIN CONSTRUCTION AND MUST BE APPROVED BY .1' COVERER THE METRO WATER SERVICÈS. AREA 5. ALL WATER METERS SHALL BE 18" BELOW FINISHED GRADE. 6. UPON COMPLETION OF CONSTRUCTION OF WATER, THE ENGINEER SHALL PROVIDE THE DEPARTMENT WITH A COMPLETE SET OF AS-BUILT PLANS ON MOIST ERASABLE MYLARS IN REVERSE AND IN DIGITAL (*.DWG) · INSTALL FORMAT. WATER LINE PLANS SHALL BE SEALED BY A LICENSED PROFESSIONAL ENGINEER OR A REGISTERED PIV LAND SURVEYOR AND SHALL INCLUDE OFFSET DISTANCE FROM THE ROADWAY CENTERLINE, OR PROPERTY LINE RIGHT OF WAY, LINE DEPTH, LOCATIONS OF HYDRANTS, VALVES, REDUCERS, TEES AND PRESSURE REDUCING N31°35'00"W DEVICES WHERE APPLICABLE. ALL DRAWINGS MUST BE COMPLETED AND SUBMITTED PRIOR TO ACCEPTANCE OF THE WATER MAINS INTO THE PUBLIC SYSTEM AND ANY CONNECTIONS BEING MADE. FDC 7. PRESSURE REGULATING DEVICES WILL BE REQUIRED ON THE CUSTOMER SIDE OF THE METER. High INSTALL 2" DOMESTIC WATER 9 INSTALL 6"x6" TEE W/ Marlen FIRE HYDRANT ASSEMBLY TO METRO STANDARDS. INSTALL 6" - INSTALL 6" REDUCED PRESSURE FIRE SERVICE BACKFLOW PREVENTOR IN ABOVE GROUND HOT BOX ENCLOSURE W/ HEATER. 'TRACT 1" INSTALL 2" DOMESTIC — Parcel 85.00 REDUCED PRESSURE - INSTALL 6"x6" TEE Tax Map 181 BACKFLOW PREVENTOR IN ABOVE GROUND HOT BOX —— INSTALL 6" GATE VALVE W/ BOX. ENCLOSURE W/ HEATER. INSTALL 6" GATE VALVE W/ BOX. INSTALL 2" DOMESTIC WATER INSTALL 6" FIRE LINE METER W/ METER METER W/ METER VAULT. — INSTALL 6" GATE VALVE W/ BOX. INSTALL 4" GATE VALVE W/ BOX -— INSTALL 6"x6" TEE & PLUG W/ 2" COMPRESSION FITTING W/ 2" COPPER INSTALL 6"x4" TEE — RESERVED ROW RAMP 8' GRASS STRIP RESERVED ROW 8' GRASS STRIP -INSTALL 300 L.F. OF 6" PVC SEWER SERVICE @ 1% MIN. SLOPE. TRACT 2" INSTALL 6" PVC CLEAN OUT 5' FROM Parcel 180.00 BUILDING & EVERY 75'. Tax Map 181 TRAFFIC BEARING WHERE REQUIRED. LEGEND 4 8"W-TAPPING SLEEVE AND VALVE (SEE PLAN FOR SIZE) SANITARY SEWER CLEANOUT INSTALL 8" TAPPING ———— GATE VALVE (SEE PLAN FOR SIZE) SLEEVE & VALVE W/ NOLENSVILLE PIKE (U.S. HIGHWAY 41-A, S.R. 11) 8"x6" REDUCER ON REDUCER (SEE PLAN FOR SIZE) EXISTING WATER LINE. 70' RIGHT-OF-WAY ——2"DW—— PROPOSED DOMESTIC WATER LINE REPAIR PAVEMENT AS REQUIRED PER Box Culvert ——6"SA — PROPOSED SANITARY SEWER LINE METRO STANDARDS T.E.: 553.85 PROPOSED FIRE HYDRANT TIE TO EXISTING SEWER LINE.

PROPOSED FIRE DEPARTMENT CONNECTION

GENERAL UTILITY NOTES


- 1. ALL GAS, ELECTRIC, AND TELEPHONE SERVICE LINES AND EXTENSIONS ARE TO BE CONSTRUCTED TO THE RESPECTIVE UTILITY COMPANY SPECIFICATIONS. UTILITY CONNECTIONS TO BE COORDINATED WITH THE APPROPRIATE UTILITY COMPANY.
- 2. THE GENERAL CONTRACTOR IS PARTICULARLY CAUTIONED THAT THE LOCATION AND/OR ELEVATION OF THE EXISTING UTILITIES SHOWN HEREON ARE BASED ON UTILITY COMPANY RECORDS, AND WHERE POSSIBLE, FIELD MEASUREMENTS. THE CONTRACTOR SHALL NOT RELY UPON THIS INFORMATION AS BEING EXACT OR COMPLETE. THE CONTRACTOR SHALL CALL TENNESSEE ONE CALL OR THE APPROPRIATE UTILITY COMPANY AT LEAST 48 HOURS PRIOR TO ANY EXCAVATION AND REQUEST FIELD VERIFICATION OF UTILITY LOCATIONS. IT SHALL BE THE CONTRACTOR'S RESPONSIBILITY TO RELOCATE EXISTING UTILITIES CONFLICTING WITH IMPROVEMENTS SHOWN HEREON IN ACCORDANCE WITH ALL LOCAL, STATE, AND FEDERAL REGULATIONS GOVERNING SUCH OPERATIONS.
- 3. BEFORE INSTALLATION OF STORM OR SANITARY SEWER, THE CONTRACTOR SHALL EXCAVATE AND VERIFY ALL CROSSINGS, AND INFORM THE CLIENT AND THE ENGINEER OF ANY CONFLICTS. THE ENGINEER WILL BE HELD HARMLESS IN THE EVENT HE IS NOT NOTIFIED OF DESIGN CONFLICTS PRIOR TO CONSTRUCTION.
- 4. REFER TO ARCHITECTURAL/MECHANICAL PLANS FOR EXACT BUILDING UTILITY ENTRANCE LOCATIONS AND TO VERIFY SERVICE LINE SIZES.
- 5. A 10-FOOT MINIMUM HORIZONTAL SEPARATION IS TO BE MAINTAINED BETWEEN WATER AND SANITARY SEWER LINES.

6. ALL CONSTRUCTION OF WATER LINES AND APPURTENANCES AND SANITARY SEWER LINES, APPURTENANCES

- AND GREASE INTERCEPTOR SHALL BE PERFORMED IN ACCORDANCE WITH THE MOST RECENTLY APPROVED STANDARD SPECIFICATIONS AND DETAILS OF HARPETH VALLEY UTILITIES DISTRICT.

 7. BEFORE TYING INTO EXISTING LINES, THE NEW LINES ARE TO BE FLUSHED AND TESTED BY THE
- CONTRACTOR. ALL LINES TO BE TIED TO EXISTING WATER AND SANITARY SEWER LINES ARE TO BE INSPECTED PRIOR TO CONNECTION BY HARPETH VALLEY UTILITIES DISTRICT.
- 8. THE CONTRACTOR SHALL PAY ANY APPLICABLE WATER AND SEWERAGE SERVICE INSPECTION FEES.
- 9. THE CONTRACTOR IS TO VERIFY THE EXACT LOCATION OF ALL EXISTING UTILITIES, TAKING CARE TO PROTECT UTILITIES THAT ARE TO REMAIN, REPAIR ANY DAMAGE ACCORDING TO THE LOCAL STANDARDS AND AT THE CONTRACTOR'S EXPENSE, COORDINATE ALL CONSTRUCTION WITH THE APPROPRIATE UTILITY COMPANY.
- 10. THE CONTRACTOR SHALL BE RESPONSIBLE FOR COORDINATING THE SEQUENCING OF CONSTRUCTION FOR ALL UTILITY LINES SO THAT WATER LINES AND GAS LINES DO NOT CONFLICT WITH SANITARY SEWERS, SANITARY SEWER SERVICES OR STORM SEWERS.
- 11. THE CONTRACTOR SHALL EXERCISE EXTREME CAUTION IN THE USE OF EQUIPMENT IN AND AROUND OVERHEAD AND UNDERGROUND ELECTRICAL WIRES AND SERVICES. IF AT ANY TIME IN THE PURSUIT OF THE WORK, THE CONTRACTOR MUST WORK IN THE CLOSE PROXIMITY OF THE ABOVE—NOTED WIRES, THE ELECTRIC COMPANY SHALL BE CONTACTED PRIOR TO SUCH WORK AND THE PROPER SAFETY MEASURES TAKEN. A THROUGH EXAMINATION OF THE OVERHEAD AND UNDERGROUND WIRES IN THE PROJECT AREA SHOULD BE MADE BY THE CONTRACTOR PRIOR TO THE INITIATION OF CONSTRUCTION.
- 12. THE CONTRACTOR'S FIELD REPRESENTATIVE SHALL NOTIFY THE HARPETH VALLEY UTILITIES DISTRICT PRIOR TO COMMENCING ANY WORK ON THE PROPOSED SEWER IMPROVEMENTS.
- 13. SEWER IMPROVEMENT CONSTRUCTION SHALL BE SUBJECT TO INSPECTION AND FINAL ACCEPTANCE OF THE HARPETH VALLEY UTILITIES DISTRICT.
- 14. THE OWNER AND ENGINEER DO NOT ASSUME RESPONSIBILITY FOR THE POSSIBILITY THAT, DURING CONSTRUCTION UTILITIES OTHER THAN THOSE SHOWN MAY BE ENCOUNTERED OR THAT THE ACTUAL LOCATION OF THOSE SHOWN MAY BE DIFFERENT FROM THE LOCATION DESIGNATED ON THE CONTRACT DRAWINGS. IN AREAS WHERE IT IS NECESSARY THAT EXACT LOCATIONS BE KNOW OF UNDERGROUND UTILITIES, THE CONTRACTOR SHALL, AT HIS OWN EXPENSE, FURNISH ALL LABOR AND TOOLS NECESSARY TO EITHER VERIFY AND SUBSTANTIATE OR DEFINITELY ESTABLISH THE POSITION OF UNDERGROUND UTILITY
- 15. AT LOCATIONS WHERE THE SEWER LINE OF WATER LINE IS UNDERNEATH PROPOSED PAVEMENT, THE TRENCH SHALL BE BACKFILLED TO SUBGRADE WITH CRUSHED STONE.
- 16. ANY AND ALL FEES, LICENSES AND PERMITS NECESSARY FOR THIS CONSTRUCTION ARE TO BE OBTAINED PRIOR TO INITIATION OF CONSTRUCTION AND THE COST OF SAME TO BE BORNE BY THE CONTRACTOR.
- 17. ALL SANITARY SEWER LINES, INCLUDING SERVICE LINES, SHALL BE LOW PRESSURE AIR TESTED BY THE CONTRACTOR. THE TEST SHALL BE CONDUCTED IN THE PRESENCE OF A HARPETH VALLEY UTILITIES DISTRICT REPRESENTATIVE.
- 18. ALL DRIVES SHALL BE CONSTRUCTED TO SUBGRADE, AND ALL PROPOSED FILLS SHALL BE MADE AND COMPACTED PRIOR TO CONSTRUCTION OF SANITARY SEWERS.
- 19. CONTRACTOR IS RESPONSIBLE FOR ALL HORIZONTAL AND VERTICAL BENDS, JOINTS, AND FITTINGS TO CONSTRUCT UTILITIES.
- 20. ALL SANITARY SEWER SERVICE LINES SHALL MAINTAIN A MINIMUM 1% SLOPE.
- 21. SITE CONTRACTOR SHALL CONSTRUCT ALL UTILITY SERVICES TO WITHIN 5' OF BUILDING. BUILDING CONTRACTOR SHALL MAKE ALL CONNECTIONS.

SEE SHEET C-13 FOR UTILITY DETAILS

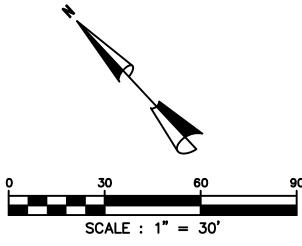

MWS □ MWS □




5150 REMINGTON DRIVE

BRENTWOOD, TENNESSEE 37027

(615) 424-4840 • FA□ (615) 370-9363

Civil Engineering Consultants

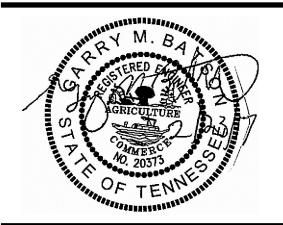

TRADITIONS PRELIMINARY

SP PLAN

6922 NOLENSVILLE PIKE NASHVILLE, TN

CASE NO. 2017SP-070-001 MAP: 181 PARCEL: 85 & 180


DESCRIPTION		DATE
COMMENT	1	19 JUL 2017
COMMENT	2	28 JUL 2017

PROŒCT NO.	-
DATE	28 JUN 2017
DRAWN BY	NI
CHECKED BY	GME

SITE UTILITY PLAN

C-4

SHEET 5 OF 15

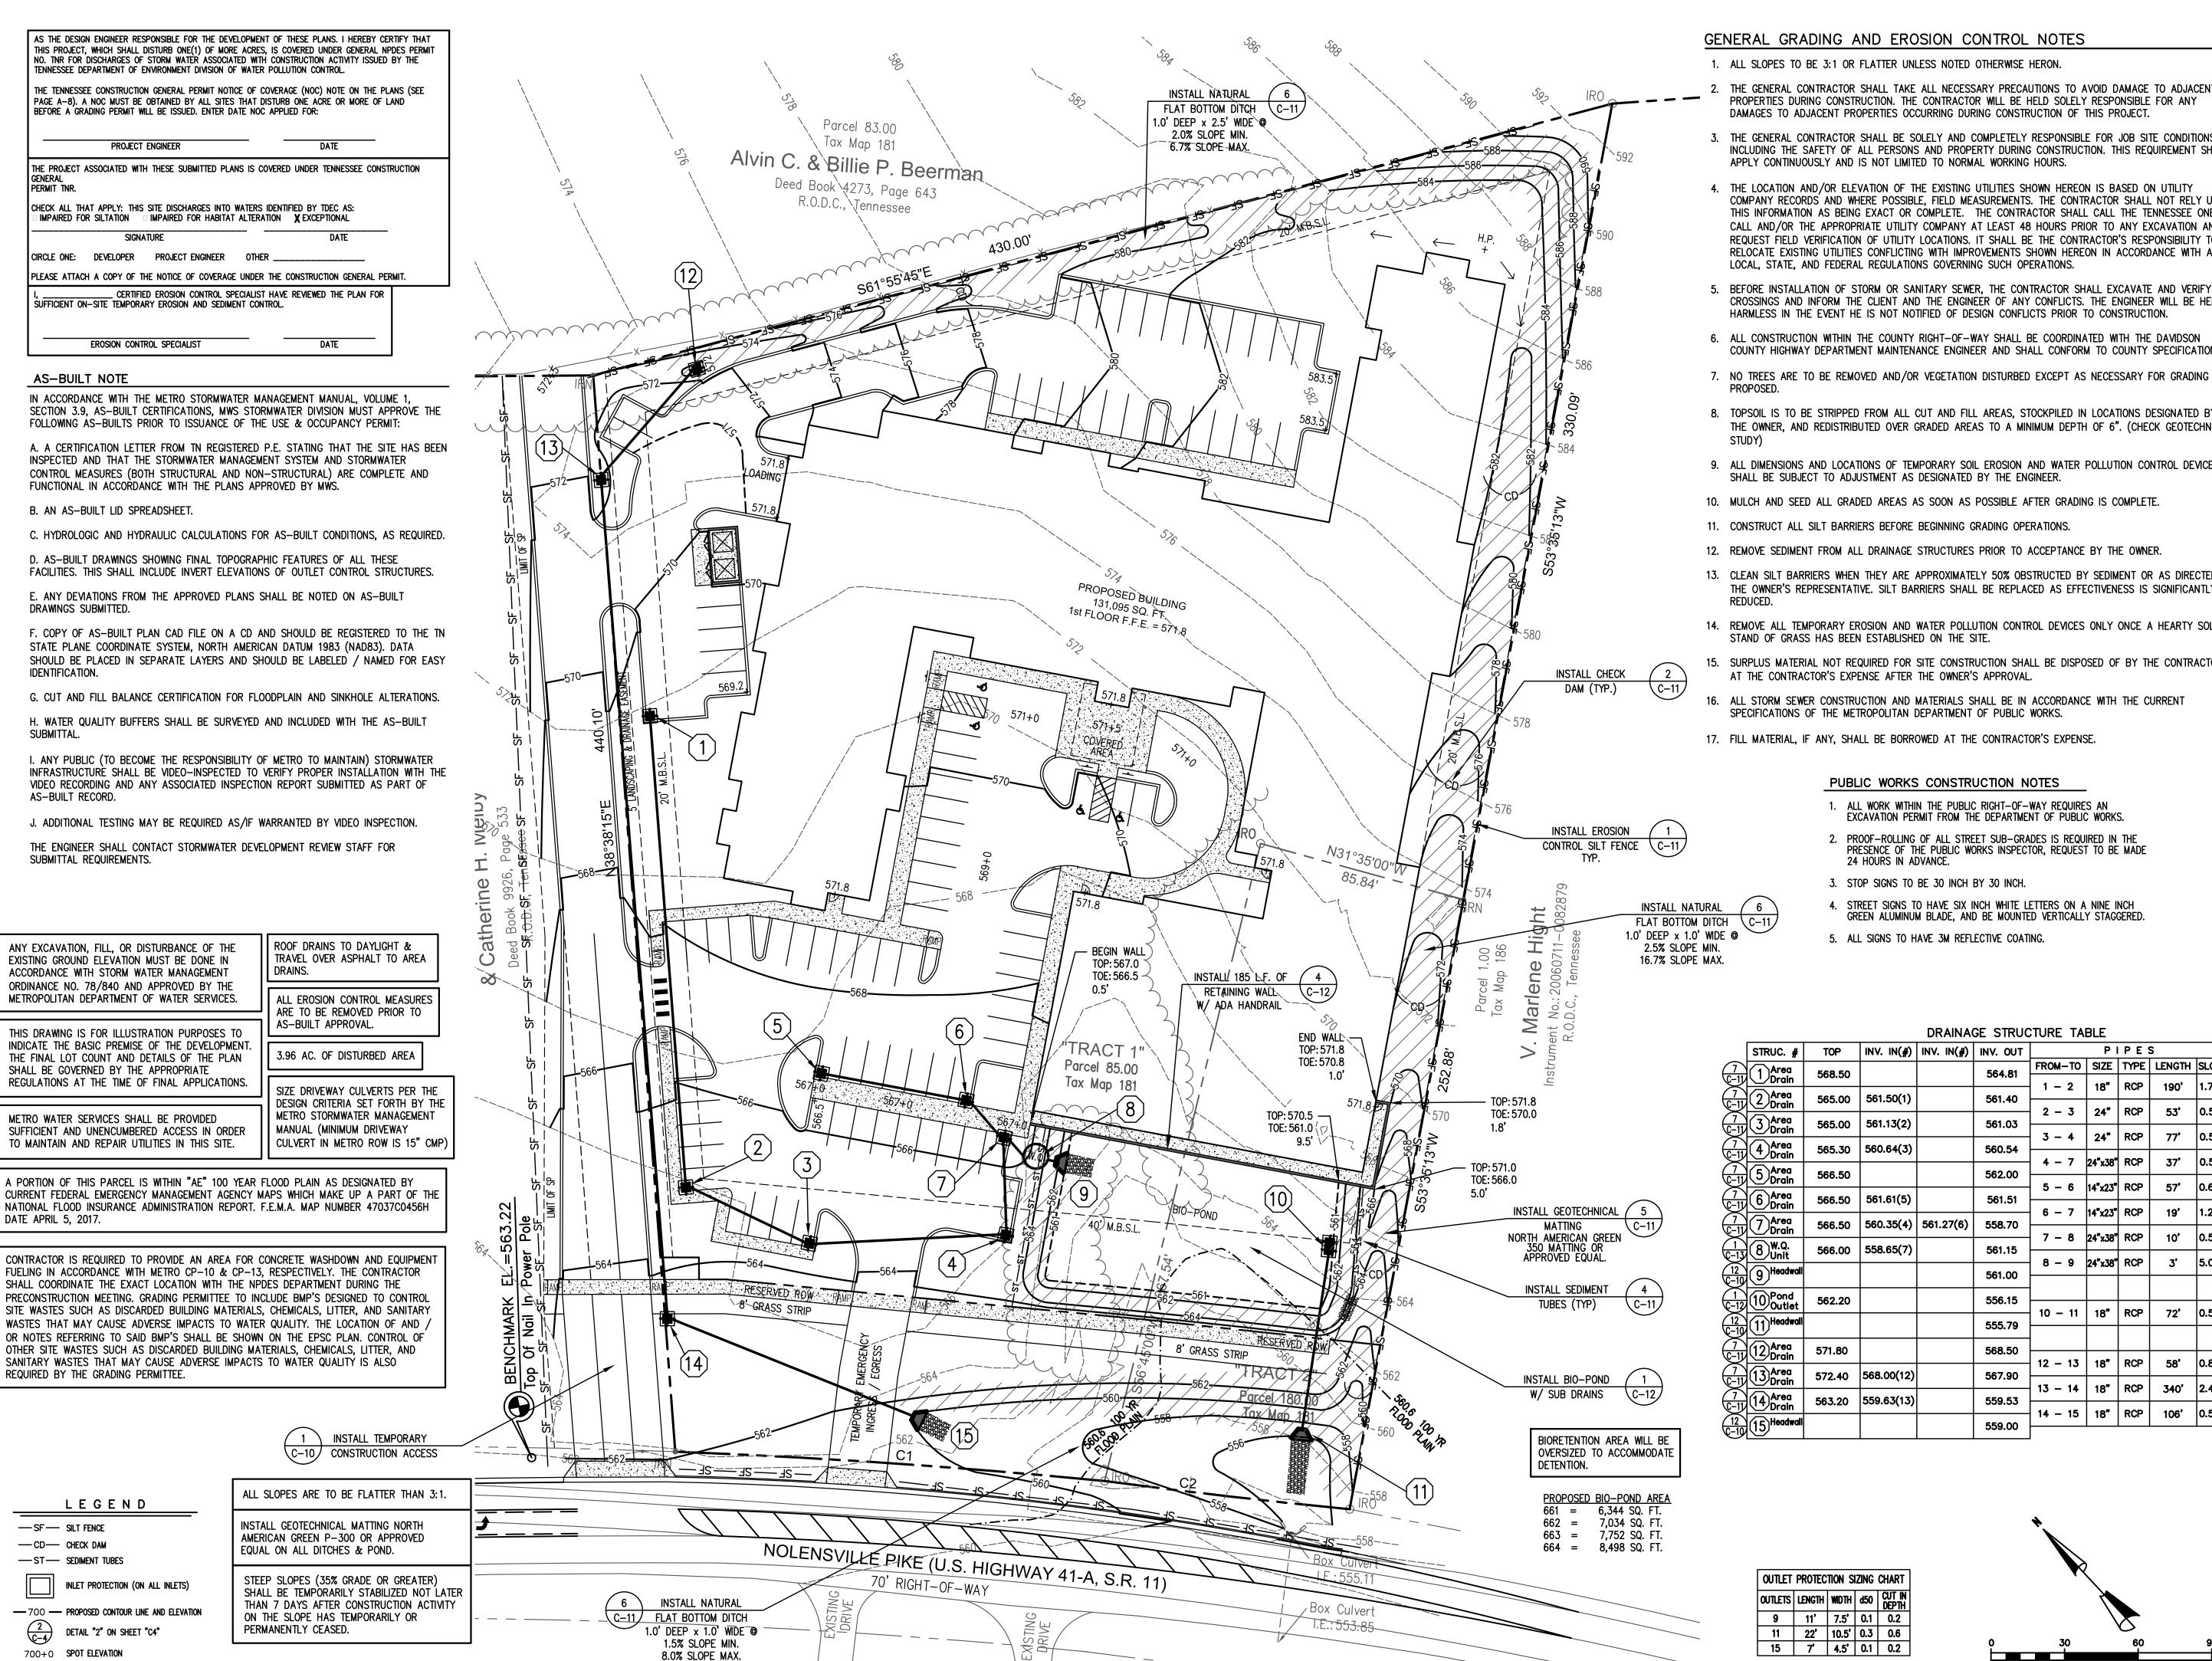

GEOTECHNICAL MATTING NORTH AMERICAN GREEN P-300 OR APPROVED EQUAL.

GENERAL GRADING AND EROSION CONTROL NOTES

- 1. ALL SLOPES TO BE 3:1 OR FLATTER UNLESS NOTED OTHERWISE HERON.
- 2. THE GENERAL CONTRACTOR SHALL TAKE ALL NECESSARY PRECAUTIONS TO AVOID DAMAGE TO ADJACENT PROPERTIES DURING CONSTRUCTION. THE CONTRACTOR WILL BE HELD SOLELY RESPONSIBLE FOR ANY DAMAGES TO ADJACENT PROPERTIES OCCURRING DURING CONSTRUCTION OF THIS PROJECT.
- THE GENERAL CONTRACTOR SHALL BE SOLELY AND COMPLETELY RESPONSIBLE FOR JOB SITE CONDITIONS, INCLUDING THE SAFETY OF ALL PERSONS AND PROPERTY DURING CONSTRUCTION. THIS REQUIREMENT SHALL APPLY CONTINUOUSLY AND IS NOT LIMITED TO NORMAL WORKING HOURS.
- 4. THE LOCATION AND/OR ELEVATION OF THE EXISTING UTILITIES SHOWN HEREON IS BASED ON UTILITY COMPANY RECORDS AND WHERE POSSIBLE, FIELD MEASUREMENTS. THE CONTRACTOR SHALL NOT RELY UPON THIS INFORMATION AS BEING EXACT OR COMPLETE. THE CONTRACTOR SHALL CALL THE TENNESSEE ONE CALL AND/OR THE APPROPRIATE UTILITY COMPANY AT LEAST 48 HOURS PRIOR TO ANY EXCAVATION AND REQUEST FIELD VERIFICATION OF UTILITY LOCATIONS. IT SHALL BE THE CONTRACTOR'S RESPONSIBILITY TO RELOCATE EXISTING UTILITIES CONFLICTING WITH IMPROVEMENTS SHOWN HEREON IN ACCORDANCE WITH ALL LOCAL, STATE, AND FEDERAL REGULATIONS GOVERNING SUCH OPERATIONS.
- 5. BEFORE INSTALLATION OF STORM OR SANITARY SEWER, THE CONTRACTOR SHALL EXCAVATE AND VERIFY ALL CROSSINGS AND INFORM THE CLIENT AND THE ENGINEER OF ANY CONFLICTS. THE ENGINEER WILL BE HELD HARMLESS IN THE EVENT HE IS NOT NOTIFIED OF DESIGN CONFLICTS PRIOR TO CONSTRUCTION.
- 6. ALL CONSTRUCTION WITHIN THE COUNTY RIGHT-OF-WAY SHALL BE COORDINATED WITH THE DAVIDSON COUNTY HIGHWAY DEPARTMENT MAINTENANCE ENGINEER AND SHALL CONFORM TO COUNTY SPECIFICATIONS.
- 8. TOPSOIL IS TO BE STRIPPED FROM ALL CUT AND FILL AREAS, STOCKPILED IN LOCATIONS DESIGNATED BY THE OWNER, AND REDISTRIBUTED OVER GRADED AREAS TO A MINIMUM DEPTH OF 6". (CHECK GEOTECHNICAL
- 9. ALL DIMENSIONS AND LOCATIONS OF TEMPORARY SOIL EROSION AND WATER POLLUTION CONTROL DEVICES
- SHALL BE SUBJECT TO ADJUSTMENT AS DESIGNATED BY THE ENGINEER.
- 11. CONSTRUCT ALL SILT BARRIERS BEFORE BEGINNING GRADING OPERATIONS.
- 12. REMOVE SEDIMENT FROM ALL DRAINAGE STRUCTURES PRIOR TO ACCEPTANCE BY THE OWNER.
- 13. CLEAN SILT BARRIERS WHEN THEY ARE APPROXIMATELY 50% OBSTRUCTED BY SEDIMENT OR AS DIRECTED BY THE OWNER'S REPRESENTATIVE. SILT BARRIERS SHALL BE REPLACED AS EFFECTIVENESS IS SIGNIFICANTLY
- 14. REMOVE ALL TEMPORARY EROSION AND WATER POLLUTION CONTROL DEVICES ONLY ONCE A HEARTY SOLID STAND OF GRASS HAS BEEN ESTABLISHED ON THE SITE.
- 15. SURPLUS MATERIAL NOT REQUIRED FOR SITE CONSTRUCTION SHALL BE DISPOSED OF BY THE CONTRACTOR AT THE CONTRACTOR'S EXPENSE AFTER THE OWNER'S APPROVAL.
- 16. ALL STORM SEWER CONSTRUCTION AND MATERIALS SHALL BE IN ACCORDANCE WITH THE CURRENT SPECIFICATIONS OF THE METROPOLITAN DEPARTMENT OF PUBLIC WORKS.
- 17. FILL MATERIAL, IF ANY, SHALL BE BORROWED AT THE CONTRACTOR'S EXPENSE.

PUBLIC WORKS CONSTRUCTION NOTES

- 1. ALL WORK WITHIN THE PUBLIC RIGHT-OF-WAY REQUIRES AN EXCAVATION PERMIT FROM THE DEPARTMENT OF PUBLIC WORKS.
- 2. PROOF-ROLLING OF ALL STREET SUB-GRADES IS REQUIRED IN THE PRESENCE OF THE PUBLIC WORKS INSPECTOR, REQUEST TO BE MADE 24 HOURS IN ADVANCE.
- 3. STOP SIGNS TO BE 30 INCH BY 30 INCH.
- 4. STREET SIGNS TO HAVE SIX INCH WHITE LETTERS ON A NINE INCH GREEN ALUMINUM BLADE, AND BE MOUNTED VERTICALLY STAGGERED.
- 5. ALL SIGNS TO HAVE 3M REFLECTIVE COATING.

DOMINAGE CTOUCTURE TARKE

			DRAINA	GE STRUC	TURE TA	BLE			
STRUC. #	TOP	INV. IN(#)	INV. IN(#)	INV. OUT		PΙ	PE:	S	
7 C-11 Area Drain	568.50			564.81	FROM-TO	SIZE	TYPE		SLOPE
7 C-11 2 Area Drain	565.00	561.50(1)		561.40	1 - 2	18"	RCP	190'	1.74%
7 7 Area	565.00	561.13(2)		561.03	2 - 3	24"	RCP	53'	0.51%
7 A Area	565.30	560.64(3)		560.54	3 - 4	24"	RCP	77'	0.51%
					4 - 7	24"x38"	RCP	37 '	0.51%
C-11 O Drain	566.50			562.00	5 – 6	14"x23"	RCP	57'	0.68%
C-11 6 Area Drain	566.50	561.61(5)		561.51	6 – 7	14"x23"	RCP	19'	1.26%
7 Area C-11 7 Drain	566.50	560.35(4)	561.27(6)	558.70	7 – 8	24"x38"	RCP	10'	0.50%
1 8 W.Q. Unit	566.00	558.65(7)		561.15					
12 C-10 9 Headwall				561.00	8 - 9	24"x38"	RCP	3'	5.00%
1 C-12 10 Pond Outlet	562.20			556.15					
12 (11) Headwall				555.79	10 – 11	18"	RCP	72'	0.50%
7 (2-11) 12 Area Drain	571.80			568.50					
7 C-11 13 Area Drain	572.40	568.00(12)		567.90	12 – 13	18"	RCP	58'	0.86%
7 A Area	563.20	559.63(13)		559.53	13 – 14	18"	RCP	340'	2.43%
12 1 Headwall					14 – 15	18"	RCP	106'	0.50%
		003.00(10)		559.00	14 - 15	18"	RCP	106'	0.5

DRAINAGE PLAN


SHEET 6 OF 15

SITE GRADING &

SCALE : 1" = 30'

BATSON & ASSOCIATES Civil Engineering Consultants

5150 REMINGTON DRIVE BRENTWOOD, TENNESSEE 37027 (615) 424-4840 • FA□ (615) 370-9363

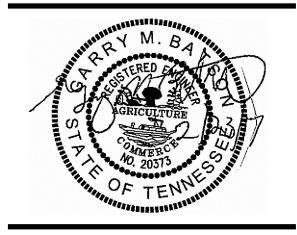

TRADITIONS

PRELIMINARY

SP PLAN

6922 NOLENSVILLE PIKE

NASHVILLE, TN

CASE NO. 2017SP-070-001

DESCRIPTION

PROŒCT NO.

DRAWN BY

CHECKED BY

COMMENT

COMMENT

DATE


MAP: 181 PARCEL: 85 & 180

DATE

19 JUL 2017

28 JUL 2017

28 JUN 2017

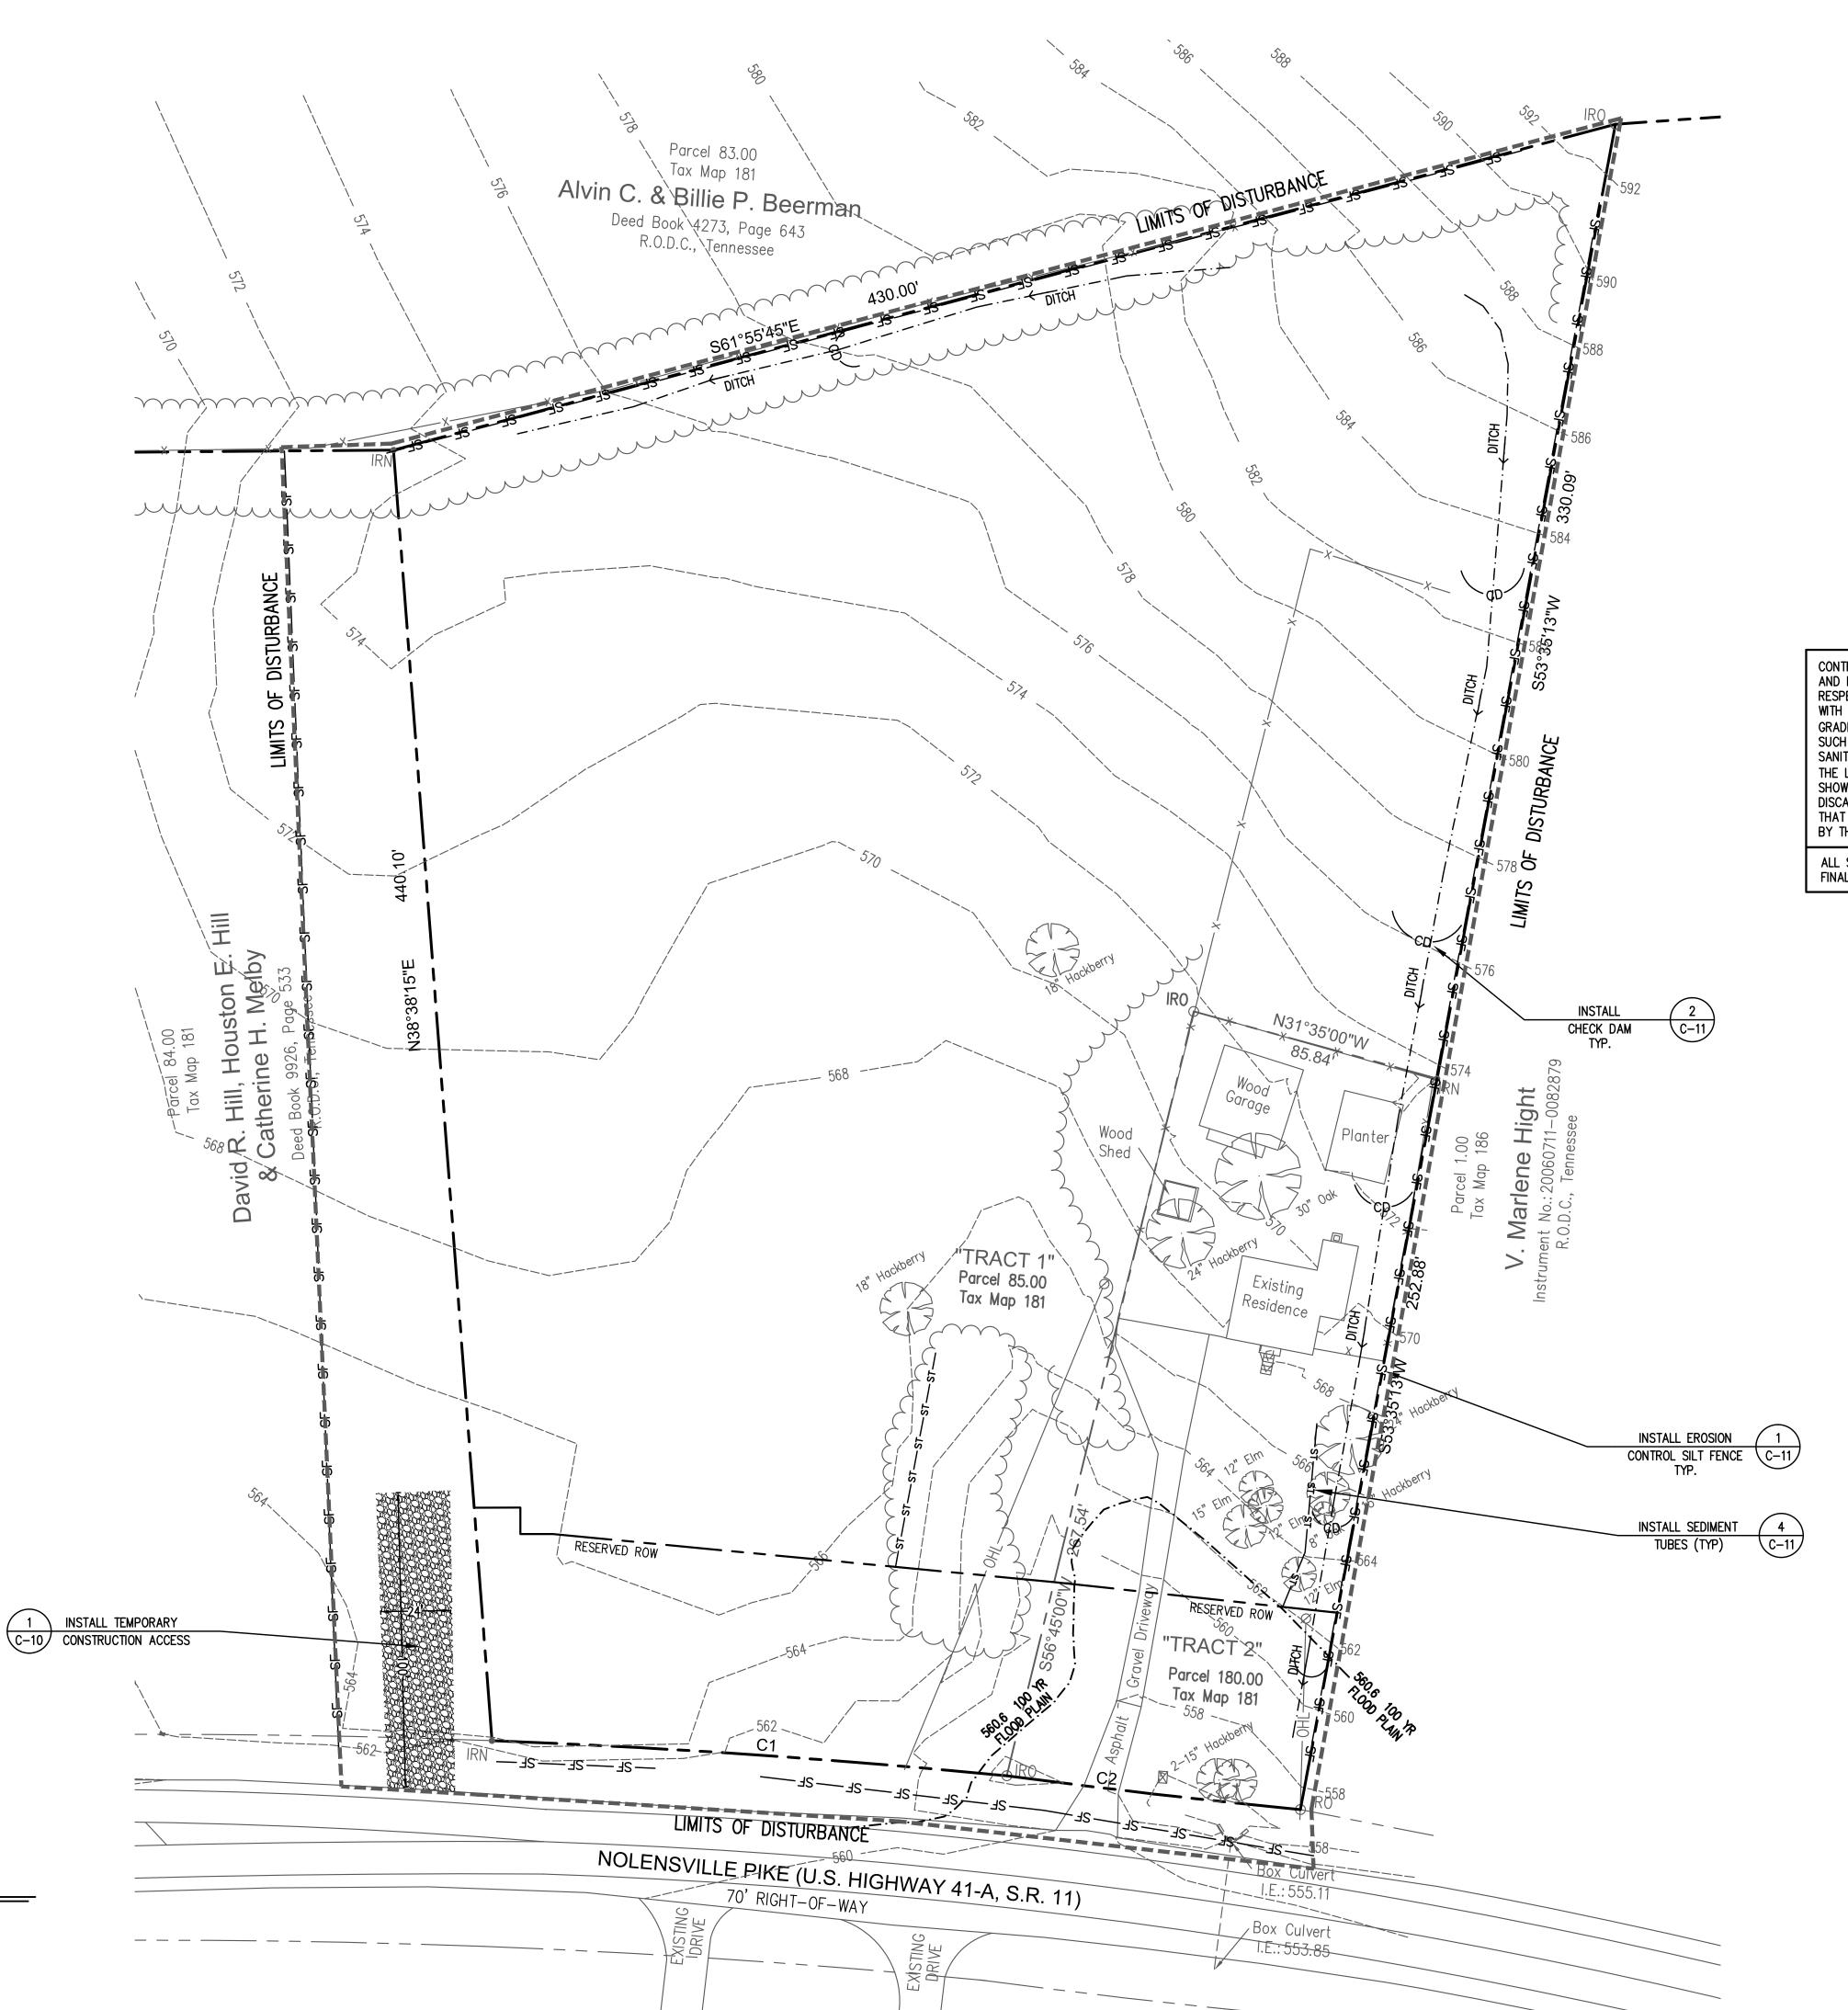

LEGEND


—SF— SILT FENCE

— CD— CHECK DAM

—ST— SEDIMENT TUBES



5150 REMINGTON DRIVE BRENTWOOD, TENNESSEE 37027 (615) 424-4840 ◆ FA□ (615) 370-9363

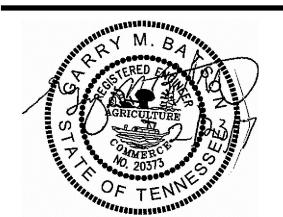

CONTRACTOR IS REQUIRED TO PROVIDE AN AREA FOR CONCRETE WASHDOWN AND EQUIPMENT FUELING IN ACCORDANCE WITH METRO CP-10 & CP-13, RESPECTIVELY. THE CONTRACTOR SHALL COORDINATE THE EXACT LOCATION WITH THE NPDES DEPARTMENT DURING THE PRECONSTRUCTION MEETING. GRADING PERMITTEE TO INCLUDE BMP'S DESIGNED TO CONTROL SITE WASTES SUCH AS DISCARDED BUILDING MATERIALS, CHEMICALS, LITTER, AND SANITARY WASTES THAT MAY CAUSE ADVERSE IMPACTS TO WATER QUALITY. THE LOCATION OF AND / OR NOTES REFERRING TO SAID BMP'S SHALL BE SHOWN ON THE EPSC PLAN. CONTROL OF OTHER SITE WASTES SUCH AS DISCARDED BUILDING MATERIALS, CHEMICALS, LITTER, AND SANITARY WASTES THAT MAY CAUSE ADVERSE IMPACTS TO WATER QUALITY IS ALSO REQUIRED BY THE GRADING PERMITTEE.

ALL SLOPES 3:1 OR STEEPER ARE TO BE STABILIZED WITHIN 7 DAYS OF FINAL GRADING.

ALL PERIMETER MEASURES MUST BE IN PLACE BEFORE GRADING

DISTURBED AREA: 3.96 AC.

TRADITIONS PRELIMINARY SP PLAN

6922 NOLENSVILLE PIKE NASHVILLE, TN

CASE NO. 2017SP-070-001 MAP: 181 PARCEL: 85 & 180


DESCRIPTIO COMMENT	1	19 JUL 2017
COMMENT	2	28 JUL 2017

PROŒCT NO. 28 JUN 2017 DATE DRAWN BY CHECKED BY

> **EPSC** PHASE 1

SCALE : 1" = 30'

SHEET 7 OF 15

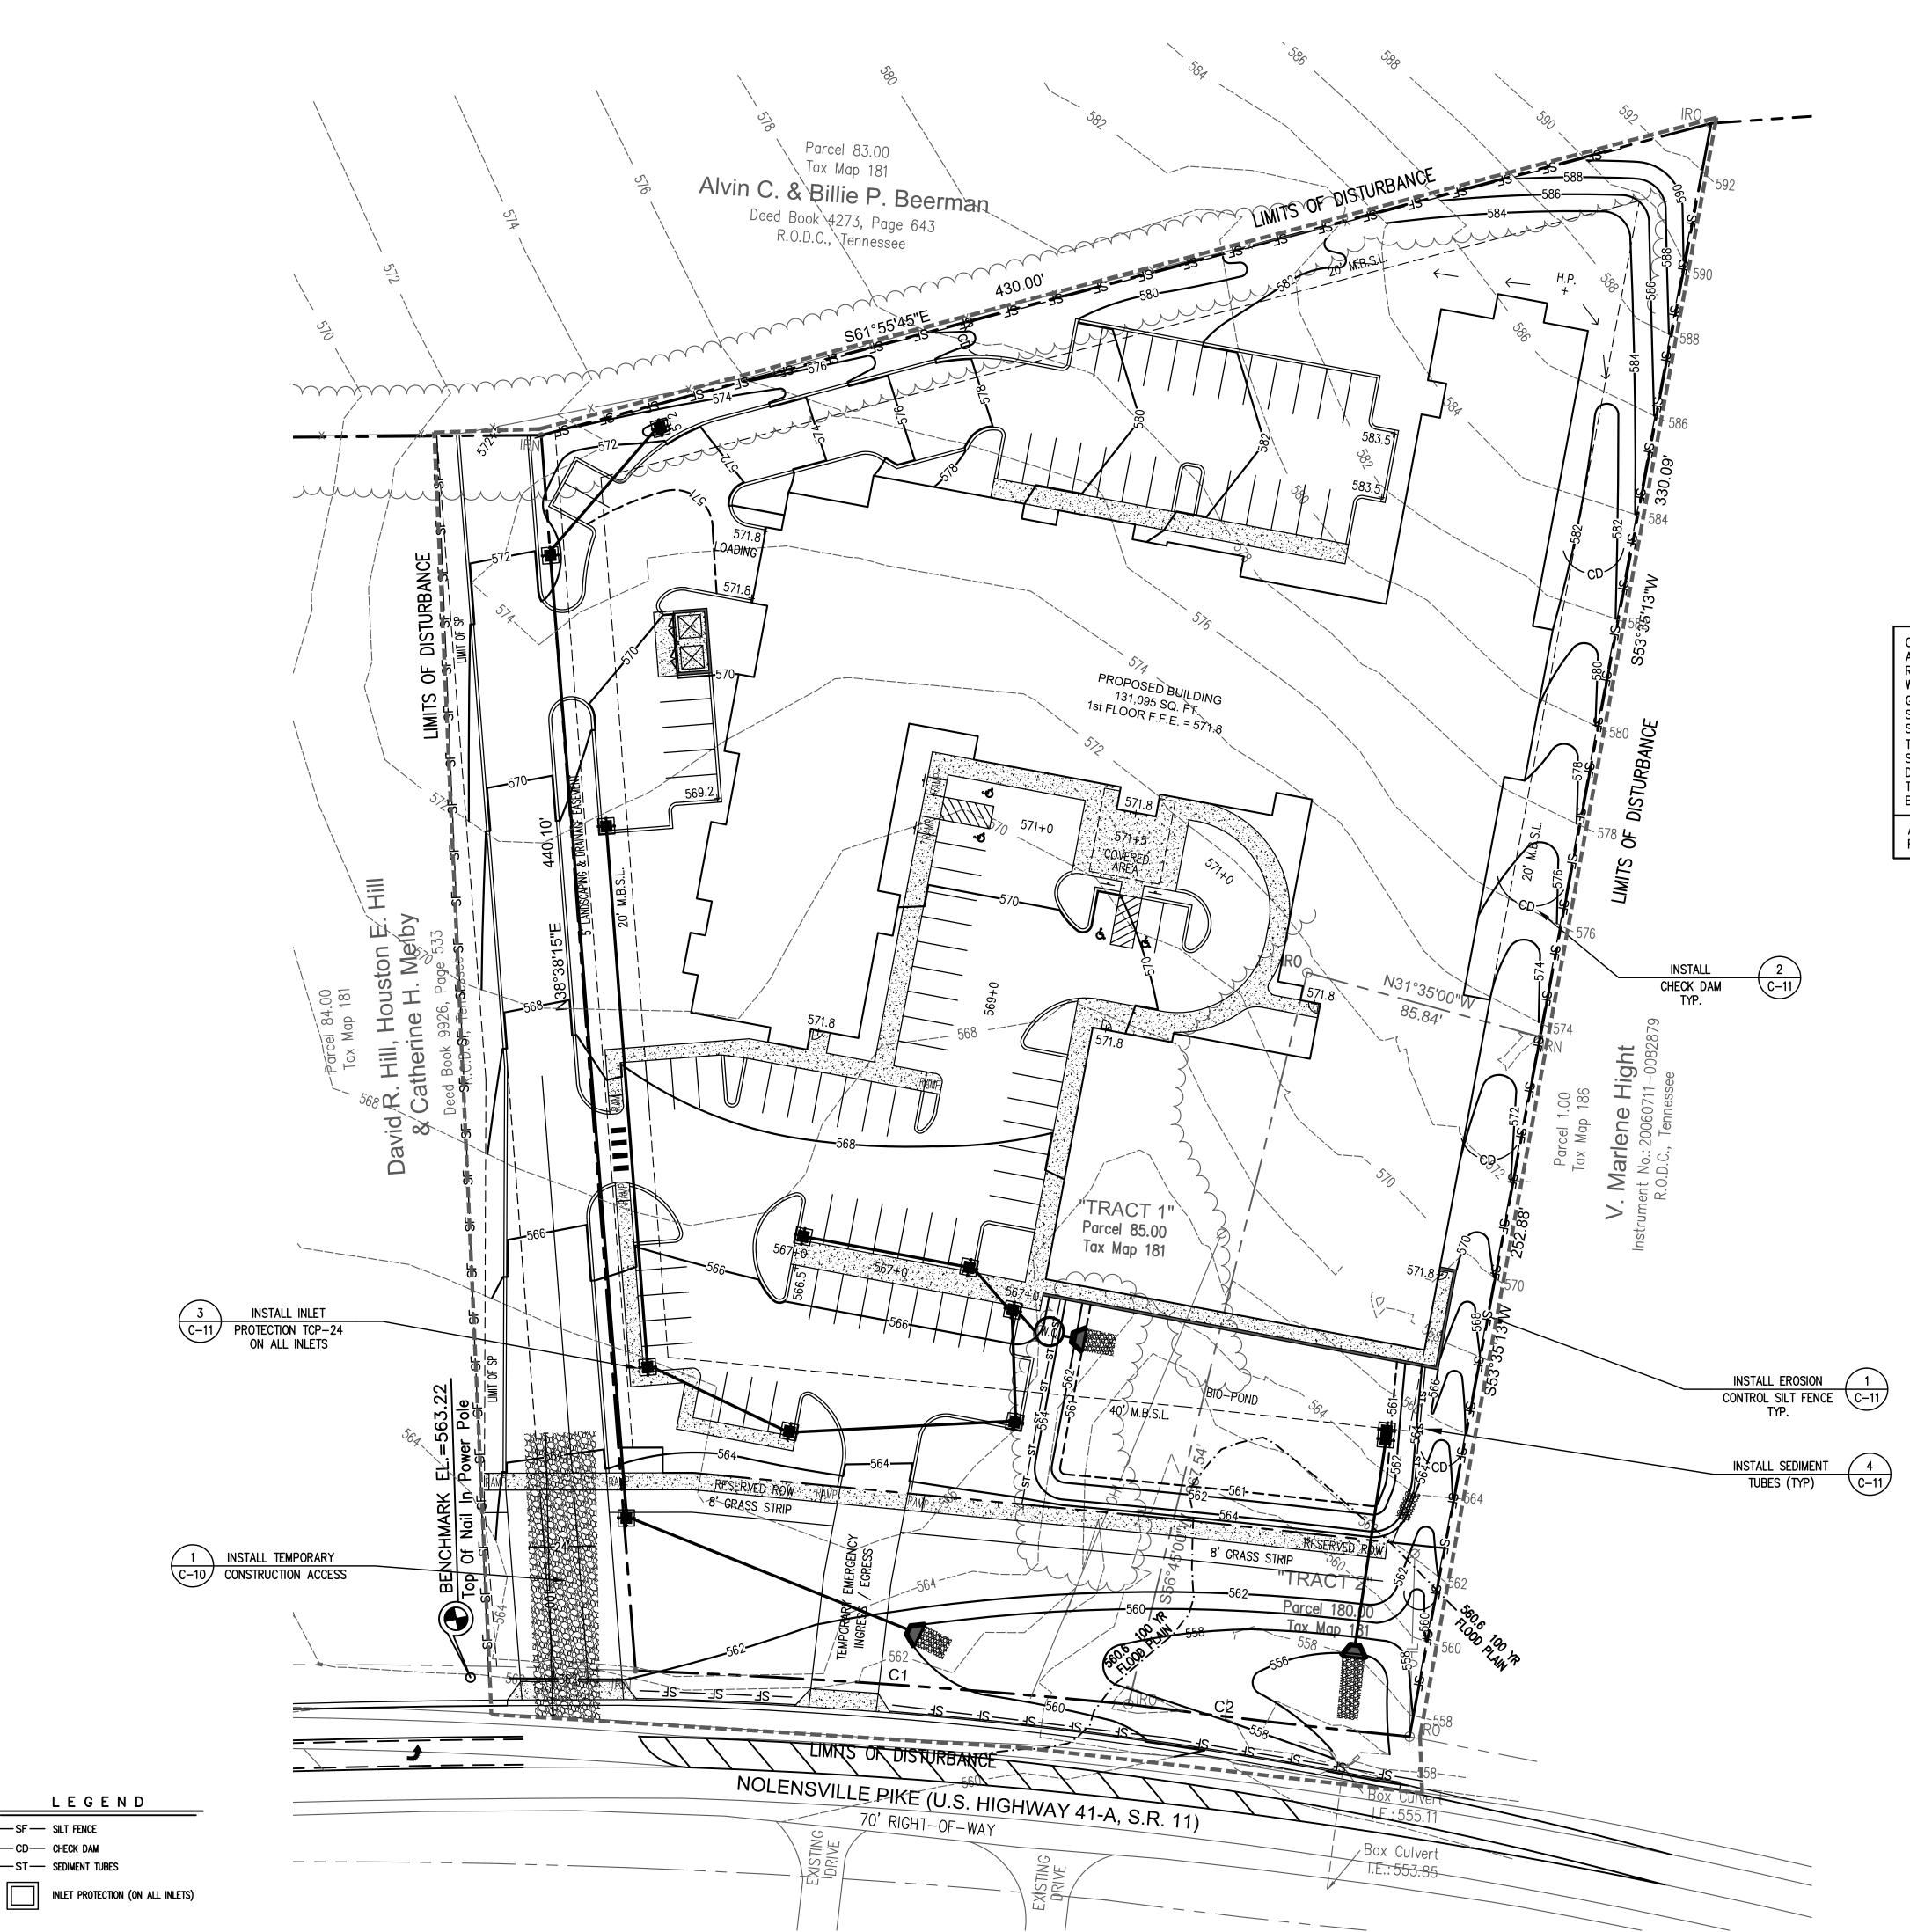


LEGEND

—SF— SILT FENCE — CD— CHECK DAM

—ST— SEDIMENT TUBES



5150 REMINGTON DRIVE BRENTWOOD, TENNESSEE 37027 (615) 424-4840 ◆ FA□ (615) 370-9363

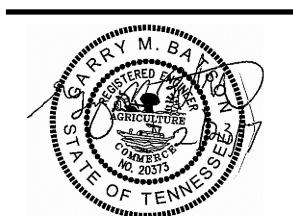

CONTRACTOR IS REQUIRED TO PROVIDE AN AREA FOR CONCRETE WASHDOWN AND EQUIPMENT FUELING IN ACCORDANCE WITH METRO CP-10 & CP-13, RESPECTIVELY. THE CONTRACTOR SHALL COORDINATE THE EXACT LOCATION WITH THE NPDES DEPARTMENT DURING THE PRECONSTRUCTION MEETING. GRADING PERMITTEE TO INCLUDE BMP'S DESIGNED TO CONTROL SITE WASTES SUCH AS DISCARDED BUILDING MATERIALS, CHEMICALS, LITTER, AND SANITARY WASTES THAT MAY CAUSE ADVERSE IMPACTS TO WATER QUALITY. THE LOCATION OF AND / OR NOTES REFERRING TO SAID BMP'S SHALL BE SHOWN ON THE EPSC PLAN. CONTROL OF OTHER SITE WASTES SUCH AS DISCARDED BUILDING MATERIALS, CHEMICALS, LITTER, AND SANITARY WASTES THAT MAY CAUSE ADVERSE IMPACTS TO WATER QUALITY IS ALSO REQUIRED BY THE GRADING PERMITTEE.

ALL SLOPES 3:1 OR STEEPER ARE TO BE STABILIZED WITHIN 7 DAYS OF FINAL GRADING.

ALL PERIMETER MEASURES MUST BE IN PLACE BEFORE GRADING

DISTURBED AREA: 3.96 AC.

TRADITIONS PRELIMINARY SP PLAN

6922 NOLENSVILLE PIKE NASHVILLE, TN

CASE NO. 2017SP-070-001 MAP: 181 PARCEL: 85 & 180


COMMENT	1	19 JUL 2017
COMMENT	2	28 JUL 2017

PROŒCT NO. DATE 28 JUN 2017 DRAWN BY CHECKED BY


> **EPSC** PHASE 2

SHEET 8 OF 15

SCALE : 1" = 30'

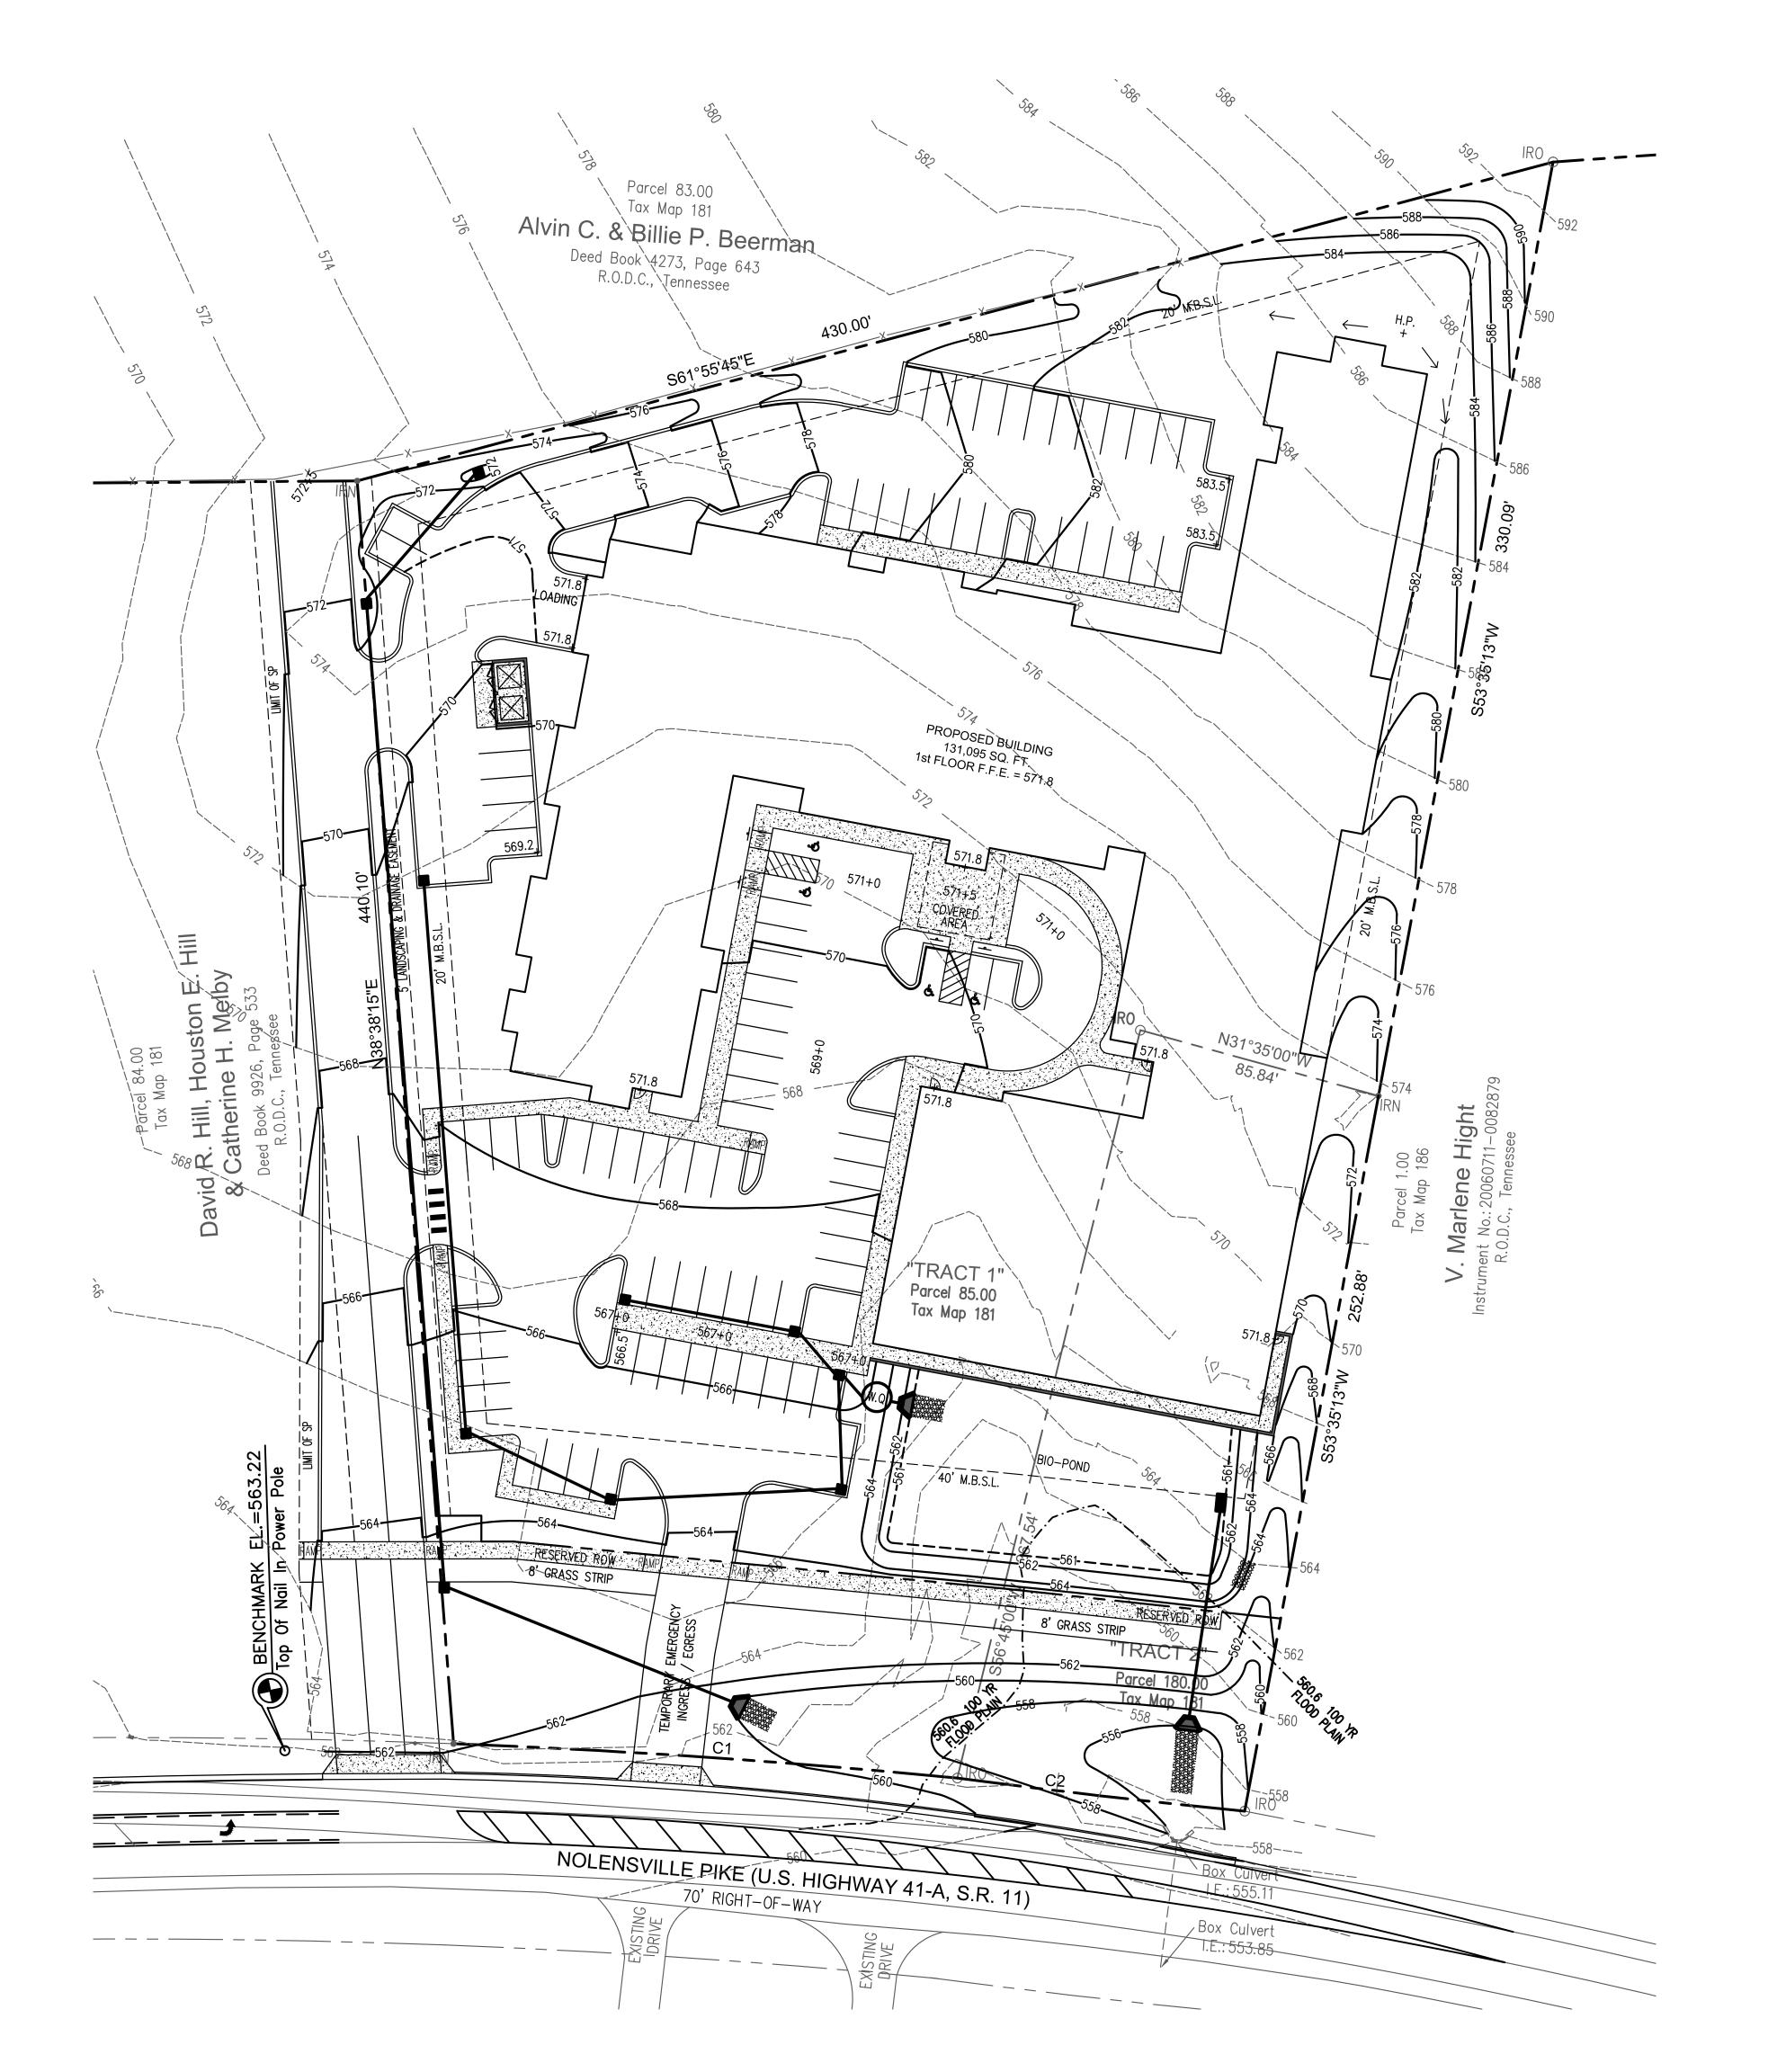



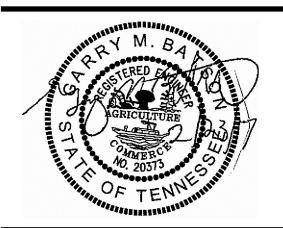

FINAL STABILIZATION OF NON—PAVED AREAS MULCH AND SEED AND STRAW ALL DISTURBED AREAS. (SEE LANDSCAPE PLAN FOR TYPE)

TEMPORARY SEEDING IN ACCORDANCE WITH TCP-05

TEMPORARY STABILIZATION OF SOIL WITH RAPIDLY GROWING ANNUAL PLANTS USED TO PREVENT EROSION ON DISTURBED AREAS BEFORE FINAL GRADING OR IN A SEASON NOT SUITABLE FOR PERMANENT SEEDING. THIS MANAGEMENT PRACTICE IS LIKELY TO CREATE A SIGNIFICANT REDUCTION IN SEDIMENT AND A PARTIAL REDUCTION IN NUTRIENTS AND TOXIC MATERIALS.

PERMANENT GRASS, VINES AND OTHER VEGETATION IN ACCORDANCE WITH PESC-01

SEEDING OF GRASSES AND PLANTINGS OF TREES, SHRUBS, VINES AND GROUND COVERS PROVIDE LONG—TERM STABILIZATION OF SOIL. THE PRIMARY FUNCTION OF PERMANENT SEEDING AND PLANTING IS TO: IMPROVE LONG—TERM AESTHETICS, REDUCE EROSION BY SLOWING RUNOFF VELOCITIES, ENHANCE INFILTRATION AND TRANSPIRATION, TRAP SEDIMENT AND OTHER PARTICULATES PARTICULATES,

PARTICULATES,
PROTECT SOIL FROM RAINDROP IMPACT, AND
PROVIDE HABITAT FOR WILDLIFE. THIS MANAGEMENT
PRACTICE IS LIKELY TO CREATE A SIGNIFICANT
REDUCTION IN SEDIMENT AS WELL AS PARTIAL
REDUCTIONS IN THE IMPACTS CAUSED BY NUTRIENTS
AND TOXIC MATERIALS.

SCALE: 1" = 30

TRADITIONS PRELIMINARY

6922 NOLENSVILLE PIKE NASHVILLE, TN

SP PLAN

CASE NO. 2017SP-070-001 MAP: 181 PARCEL: 85 & 180


DESCRIPTION

CHECKED BY


COMMENT	1	19 JUL 201
COMMENT	2	28 JUL 201
PROŒCT NO.		
DATE		28 JUN 201
DRAWN BY		N

EPSC PHASE 3

SHEET 9 OF 15

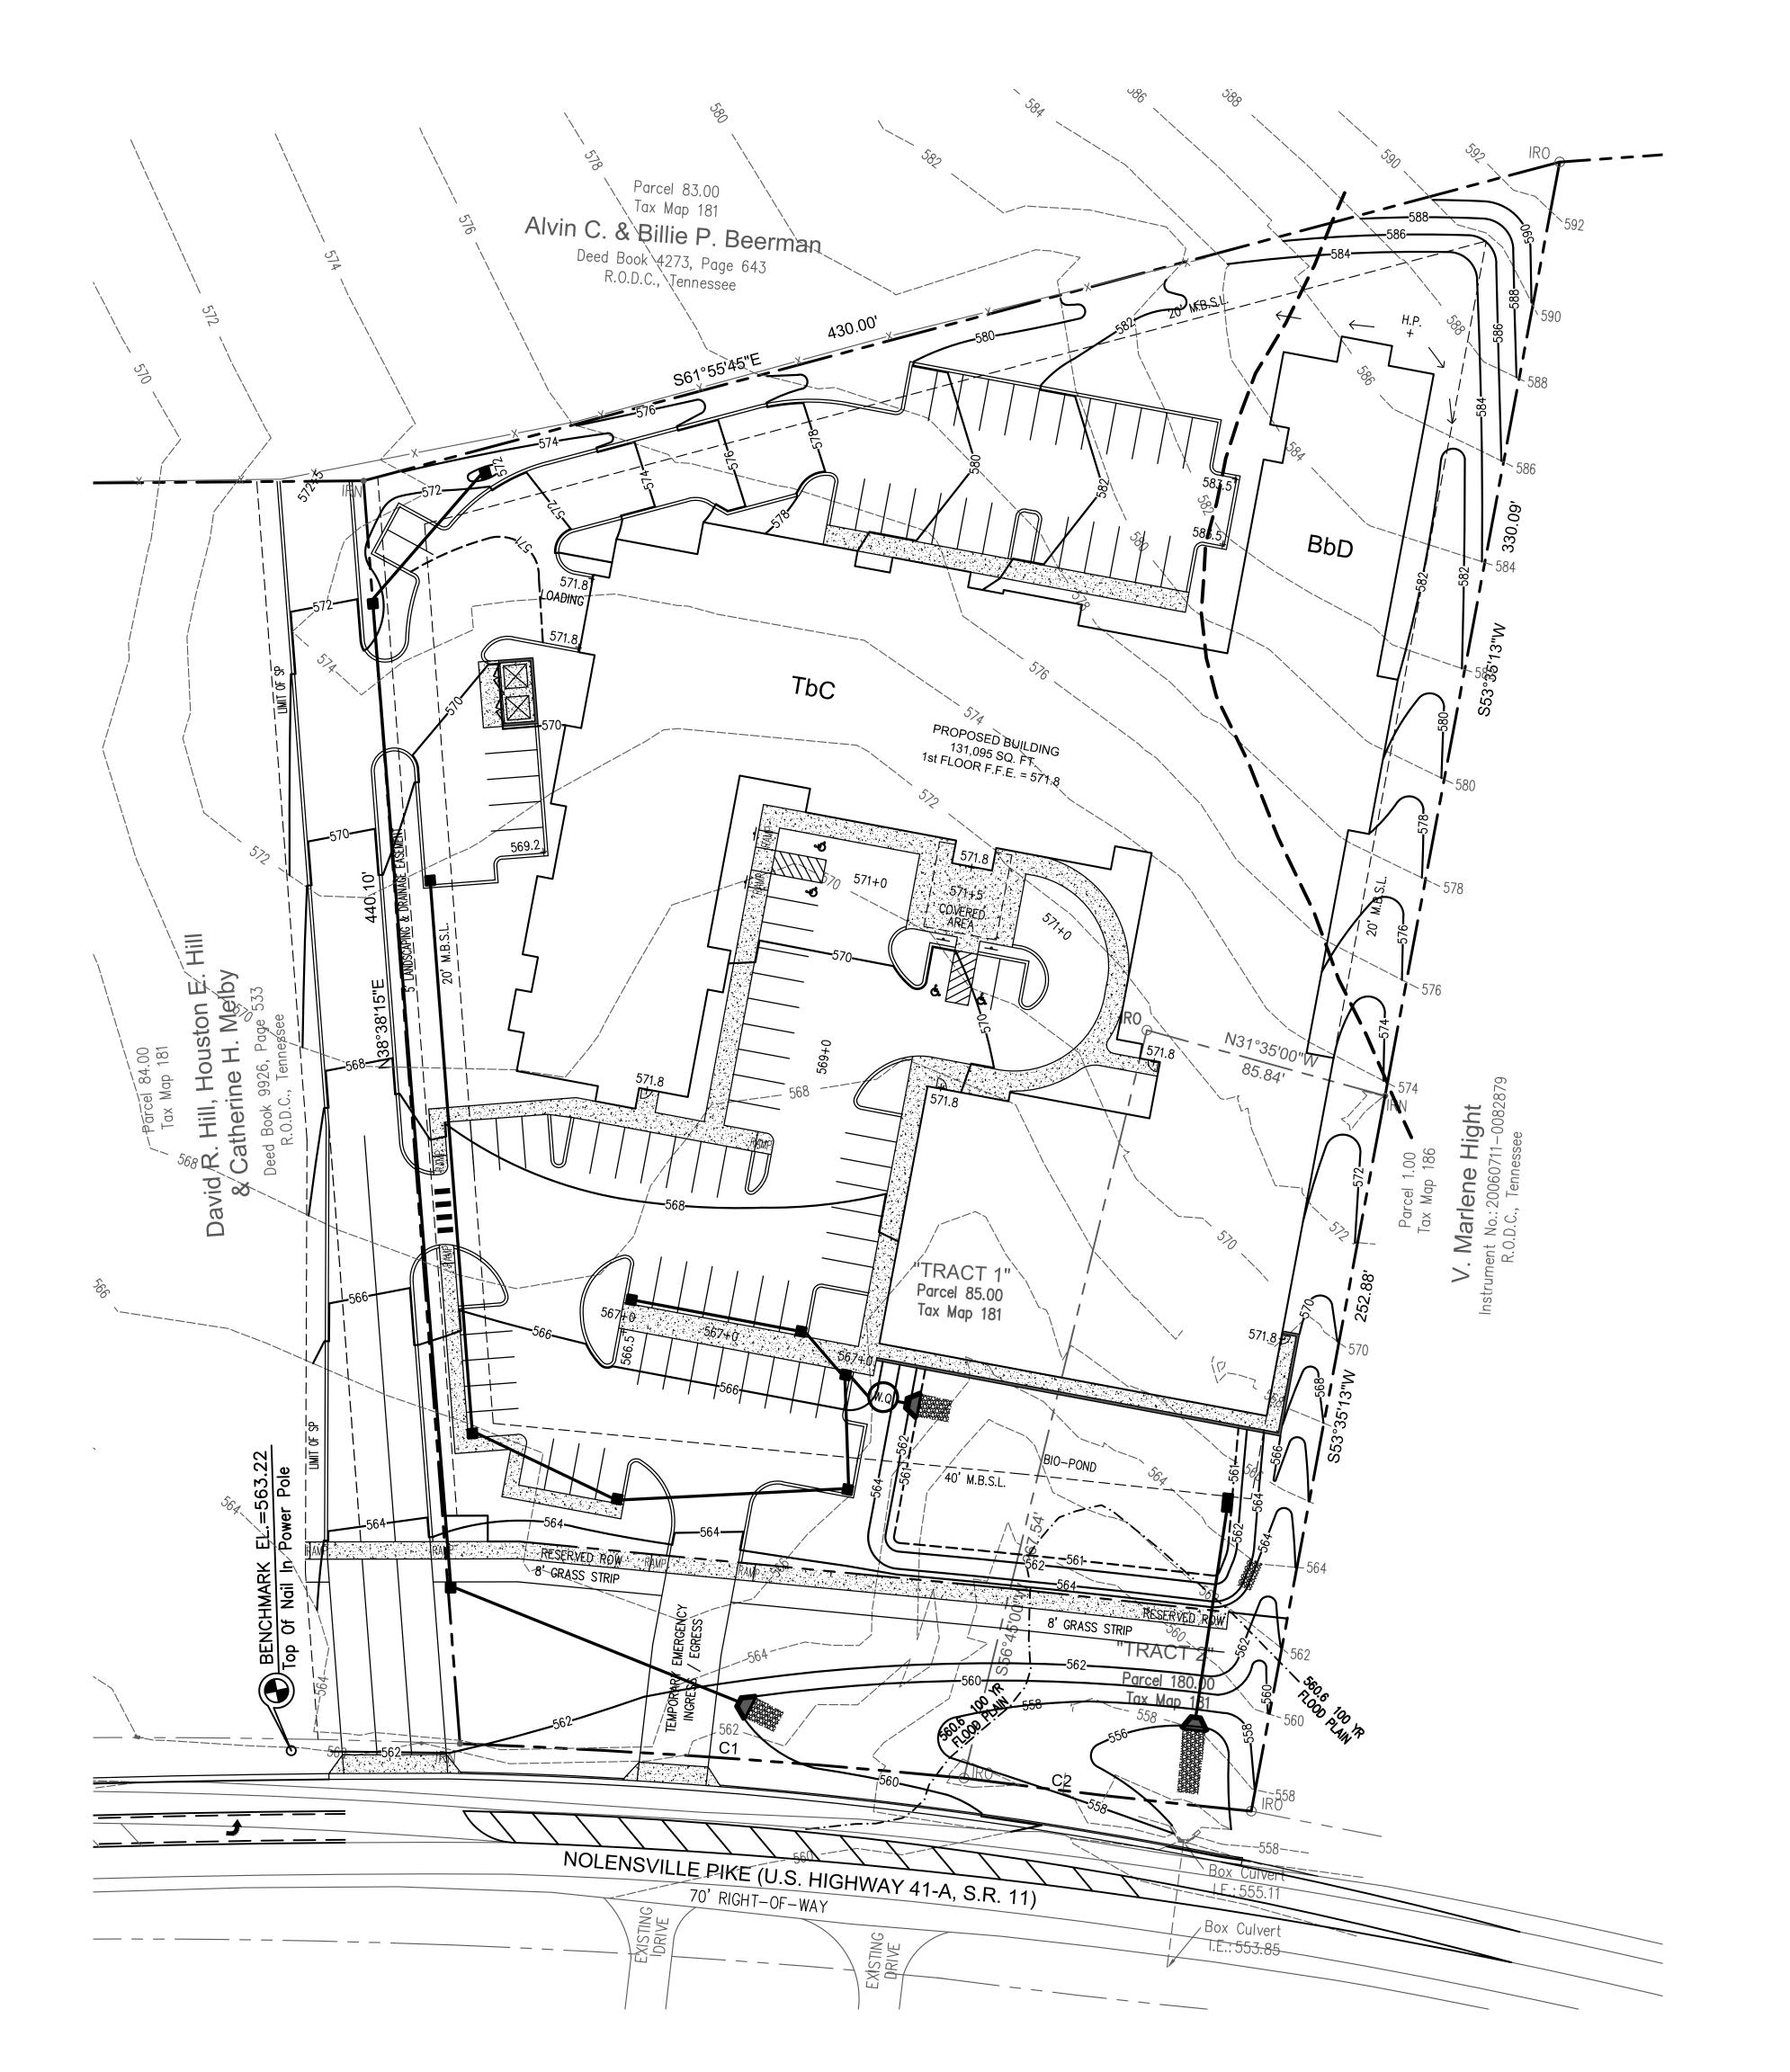



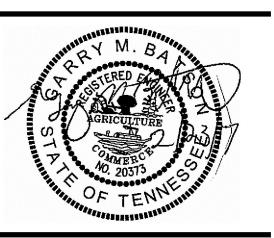

TRADITIONS PRELIMINARY

SP PLAN

6922 NOLENSVILLE PIKE NASHVILLE, TN

CASE NO. 2017SP-070-001 MAP: 181 PARCEL: 85 & 180


DESCRIPTION		DAT
COMMENT	1	19 JUL 20°
COMMENT	2	28 JUL 20 ⁻
PROŒCT NO.		
DATE		28 JUN 20°
DRAWN BY		N
CHECKED BY		GN

SITE SOILS MAP




SCALE : 1" = 30'

SHEET 10 OF 15

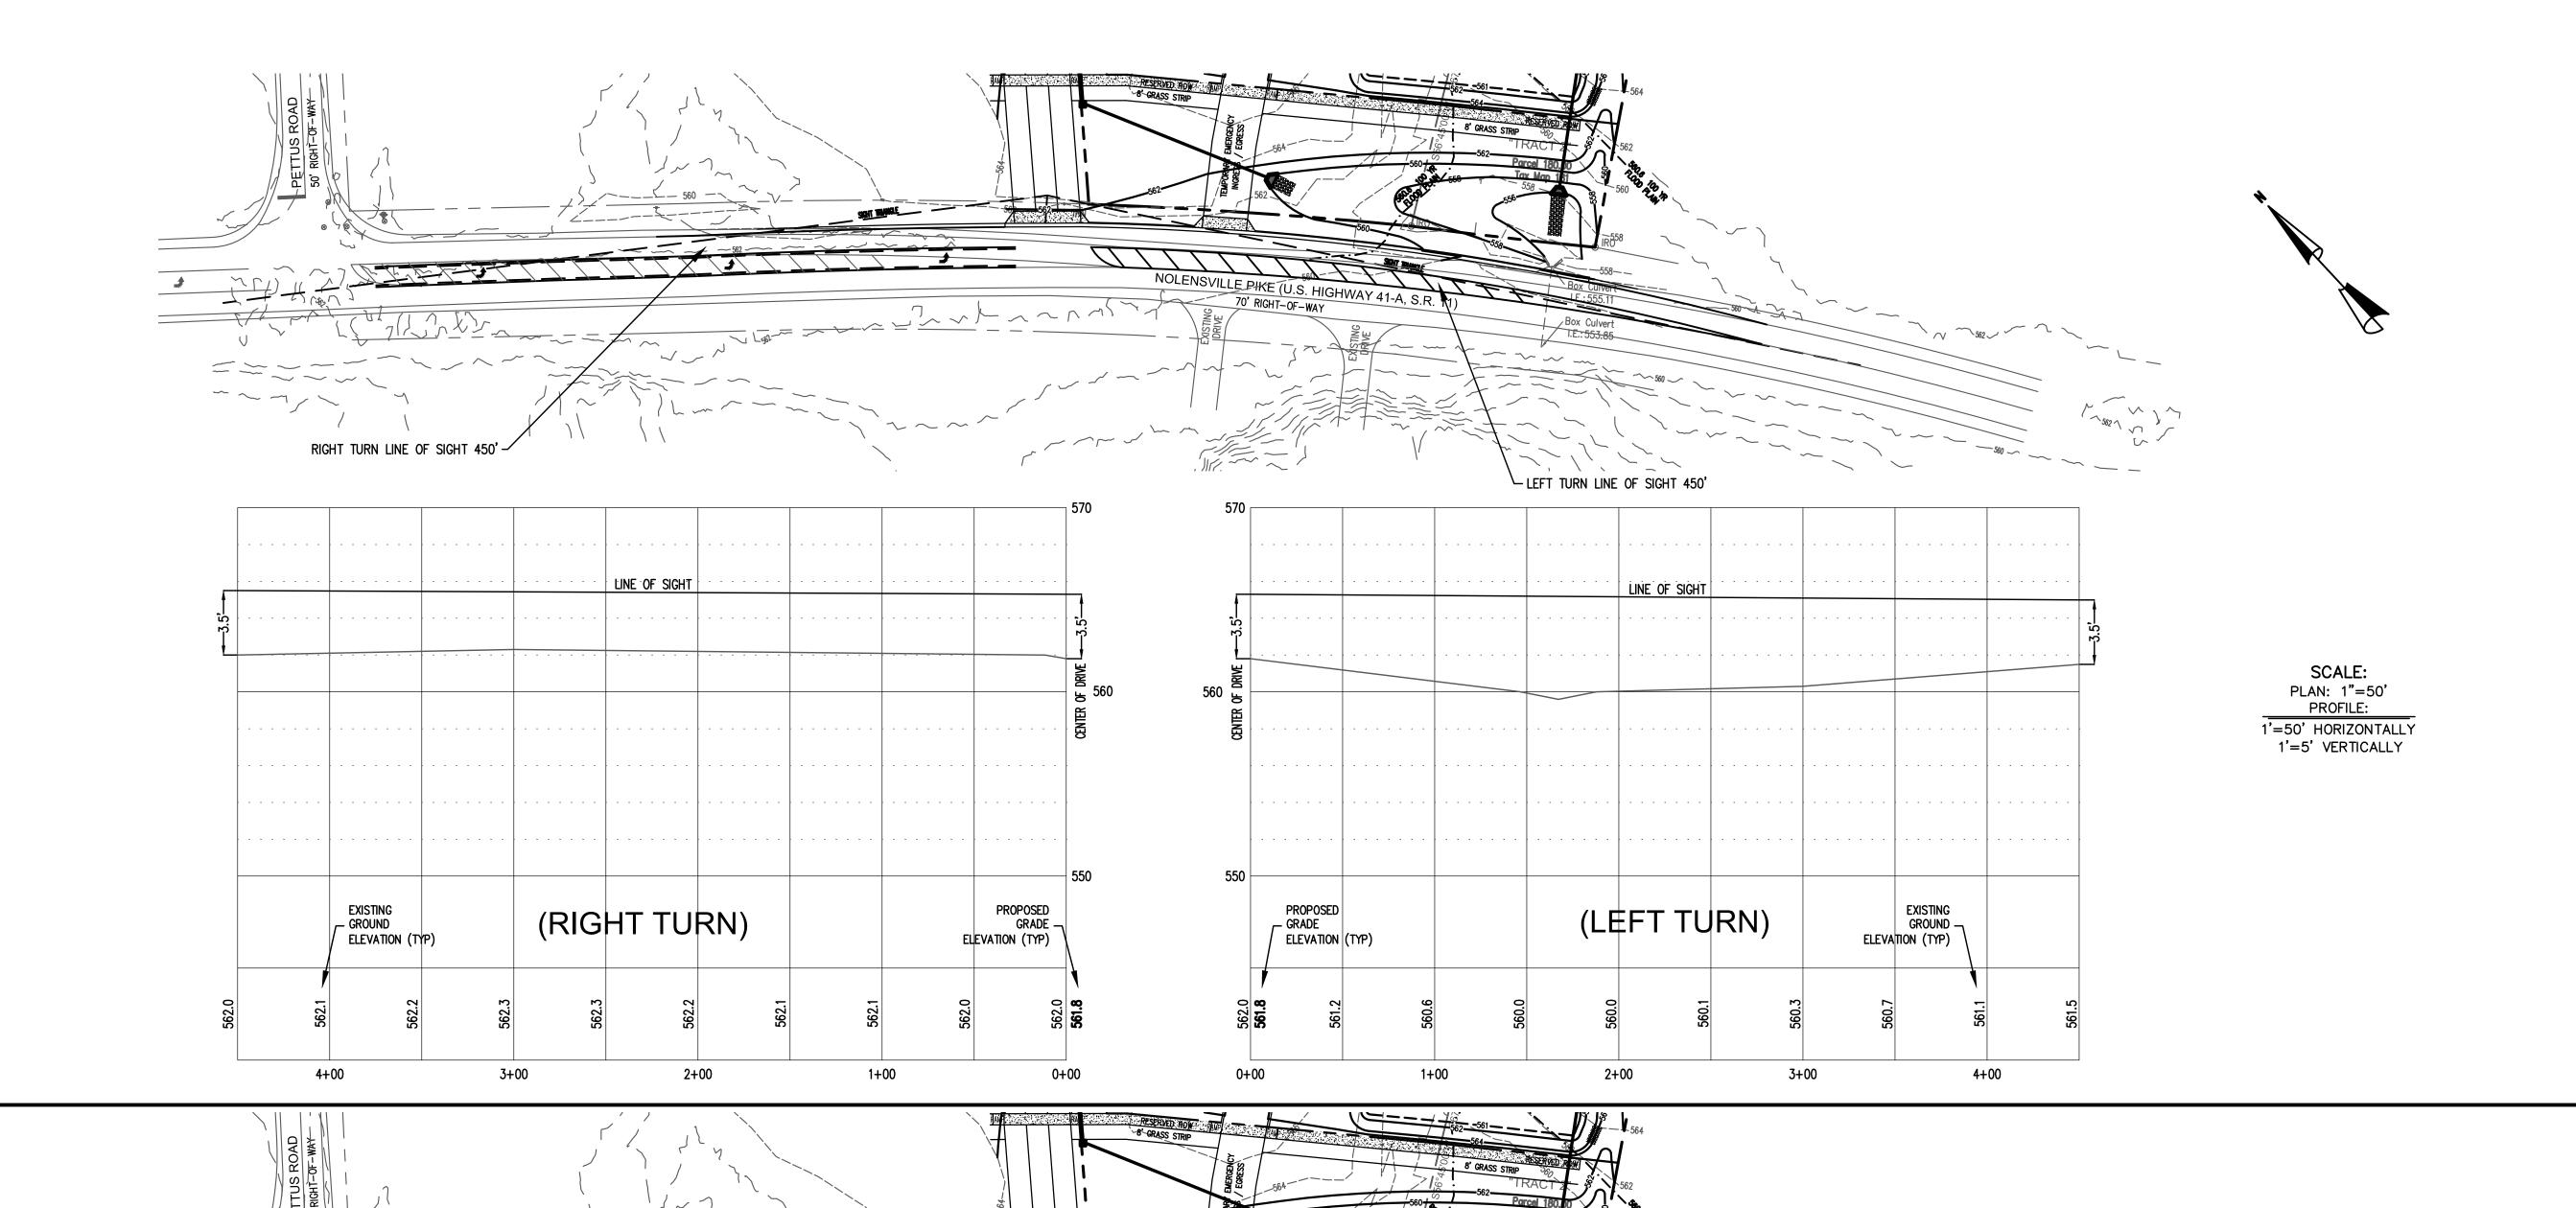



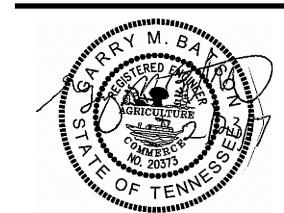

TRADITIONS PRELIMINARY SP PLAN

6922 NOLENSVILLE PIKE NASHVILLE, TN

CASE NO. 2017SP-070-001 MAP: 181 PARCEL: 85 & 180


DESCRIPTION


COMMENT	1	19 JUL 2017
COMMENT	2	28 JUL 2017
PROŒCT NO.		-
DATE		28 JUN 2017
DRAWN BY		NI
CHECKED BY		GME


SIGHT TRIANGLE PROFILE PLAN


C-9


SHEET 11 OF 1

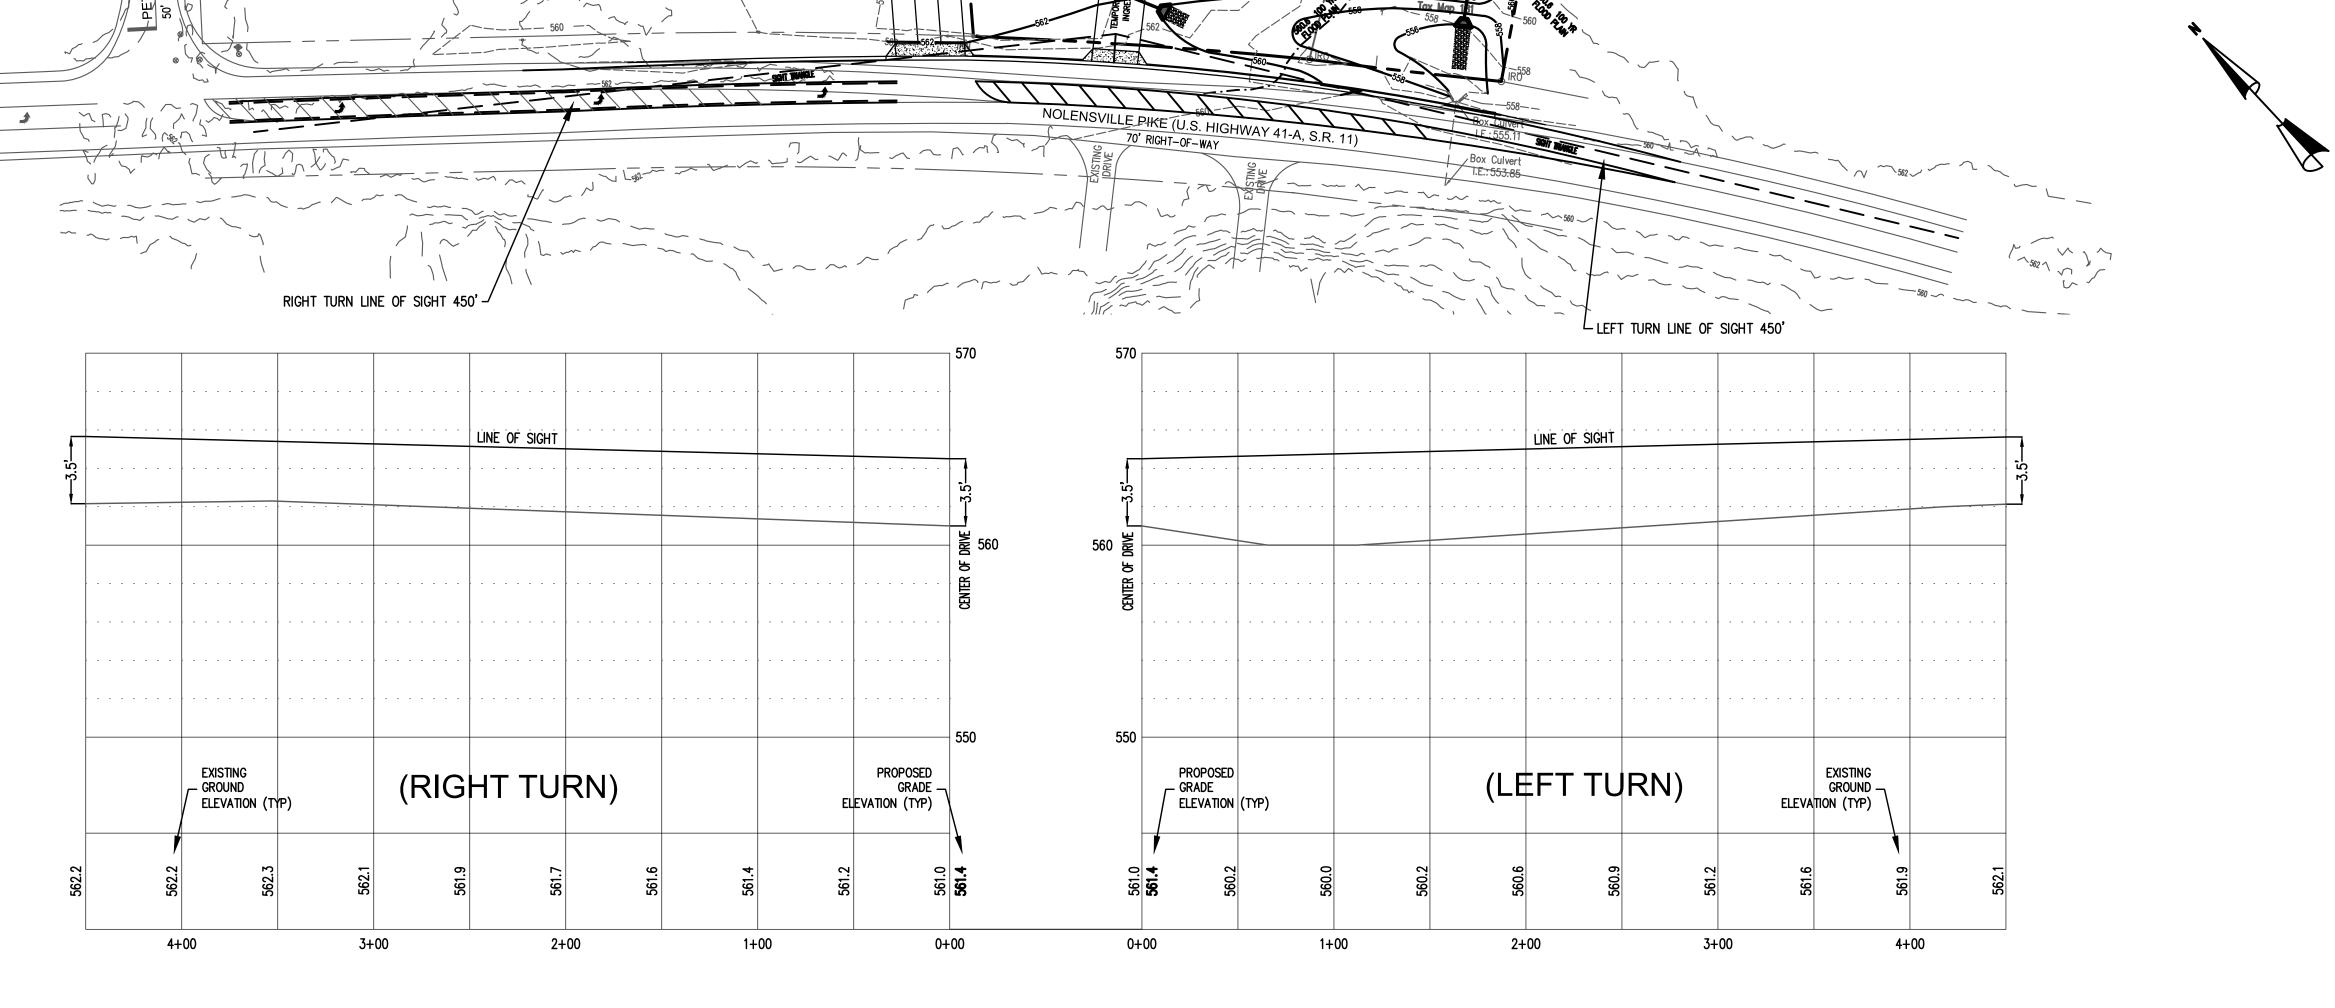

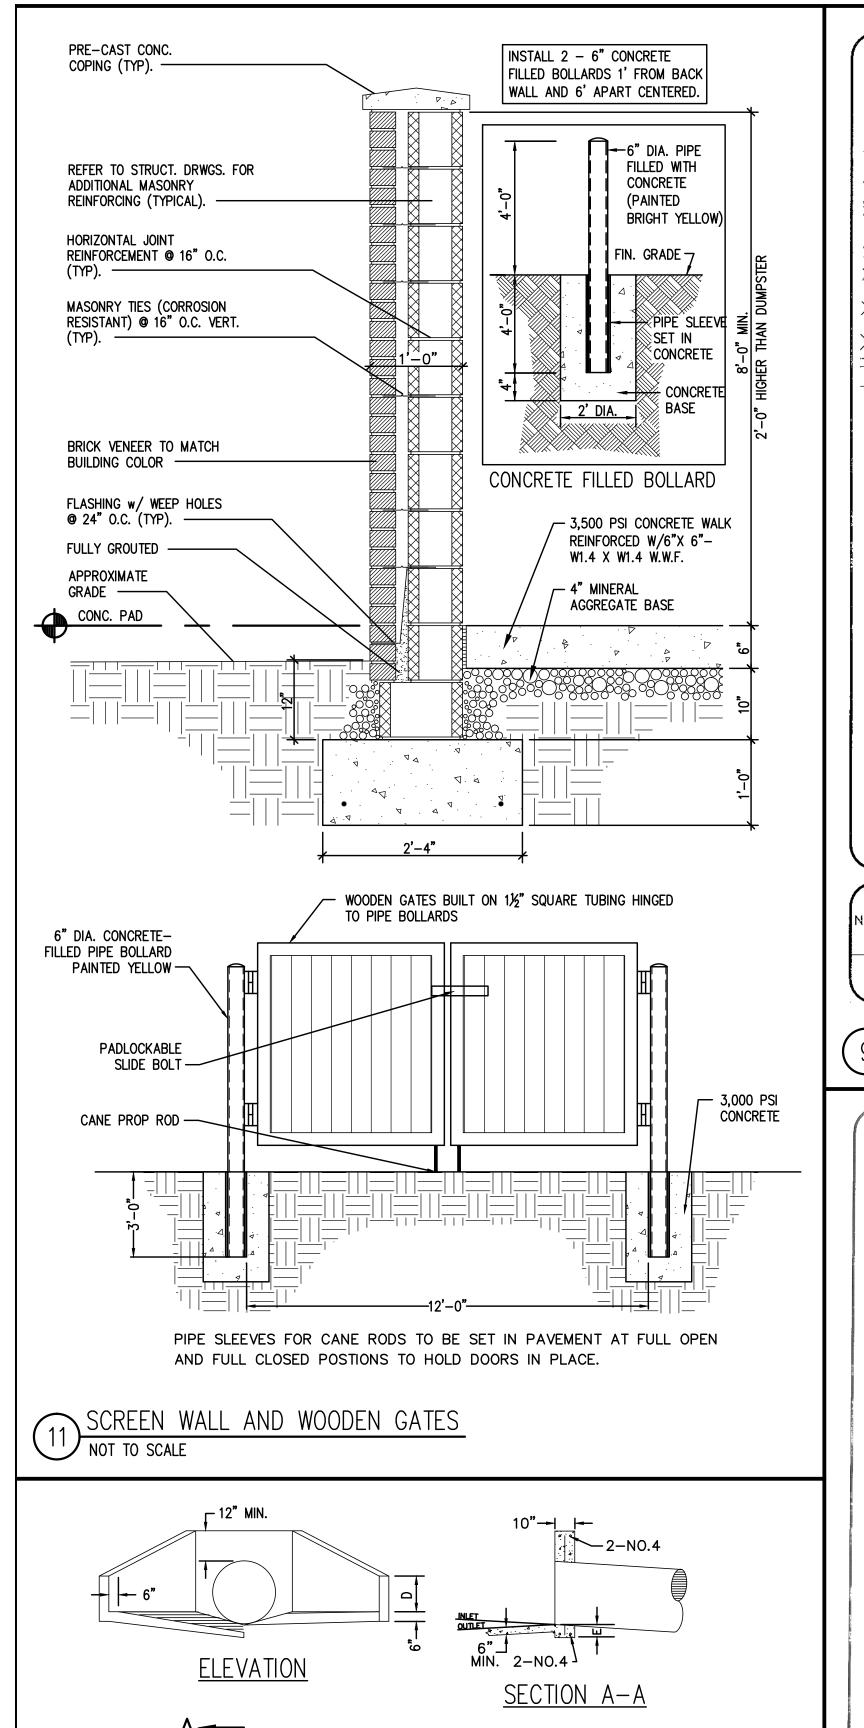

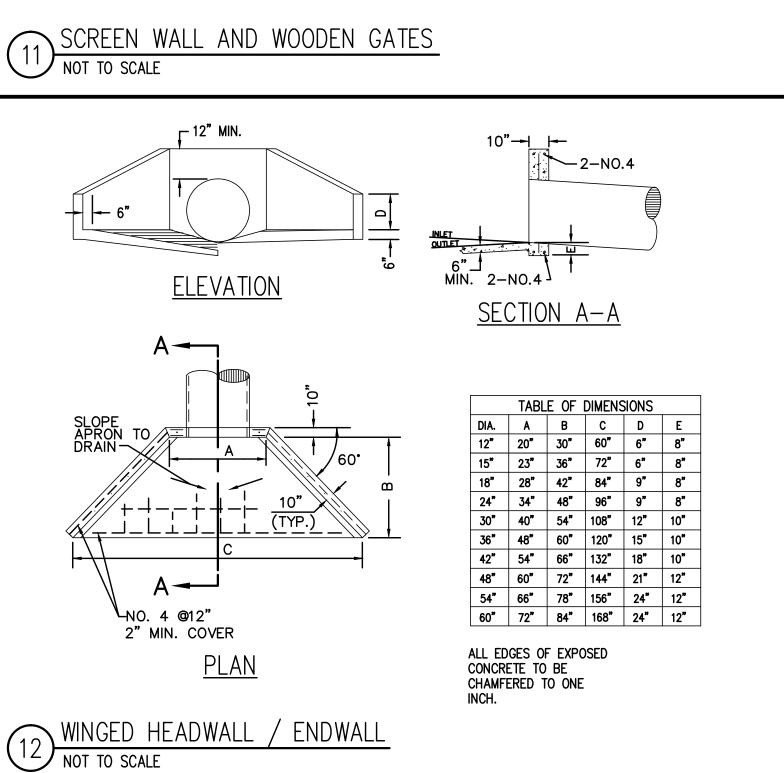

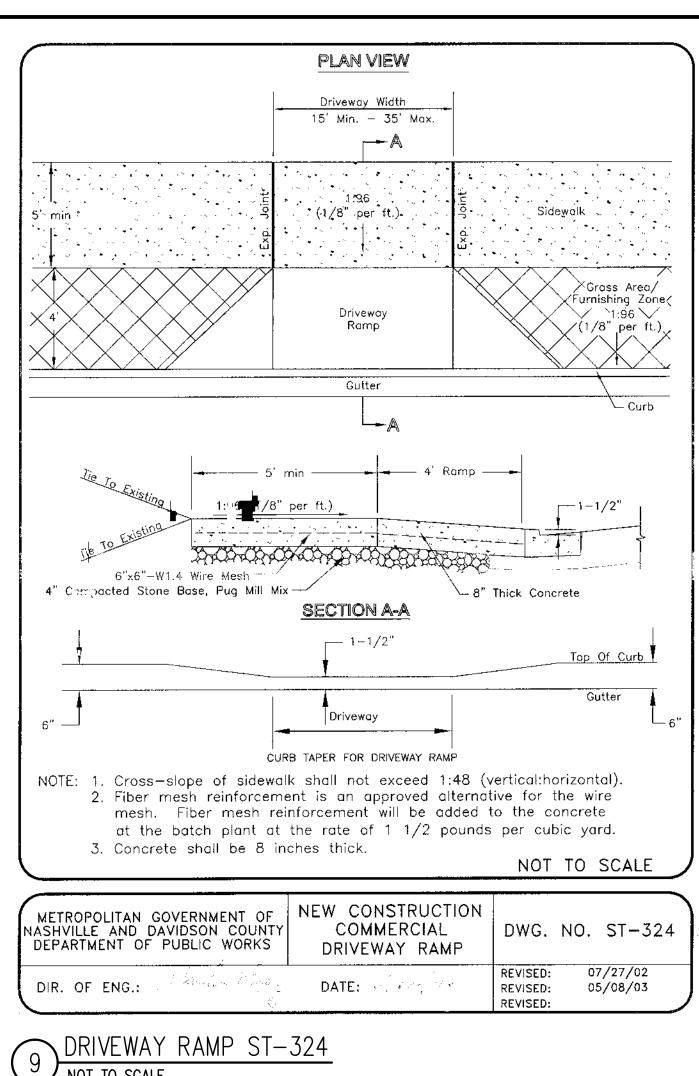


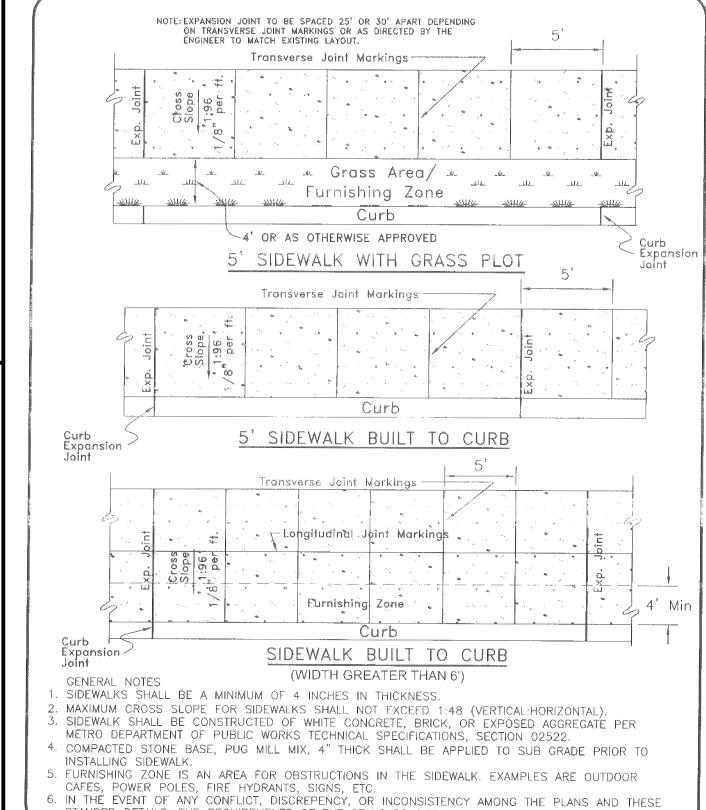


CONSTRUCTION

DATE:

DIR. OF ENG .:

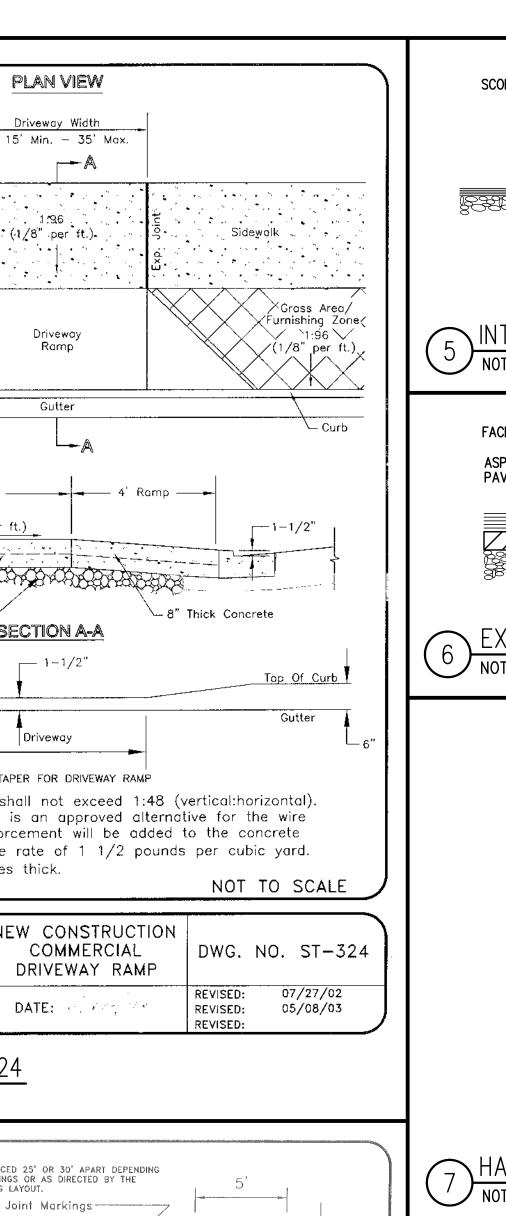

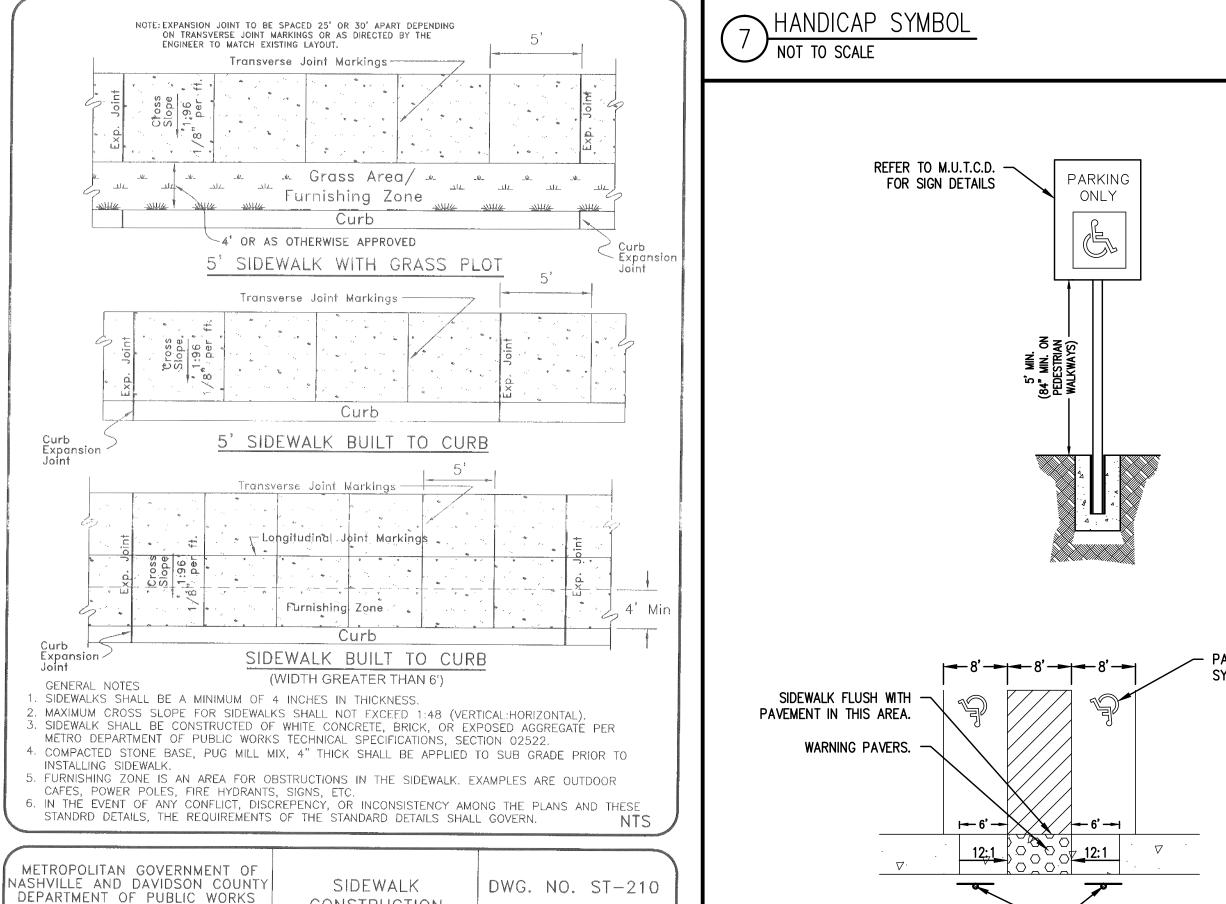

05/02/03


11/24/03


06/23/04


REVISED:


REVISED:


REVISED:

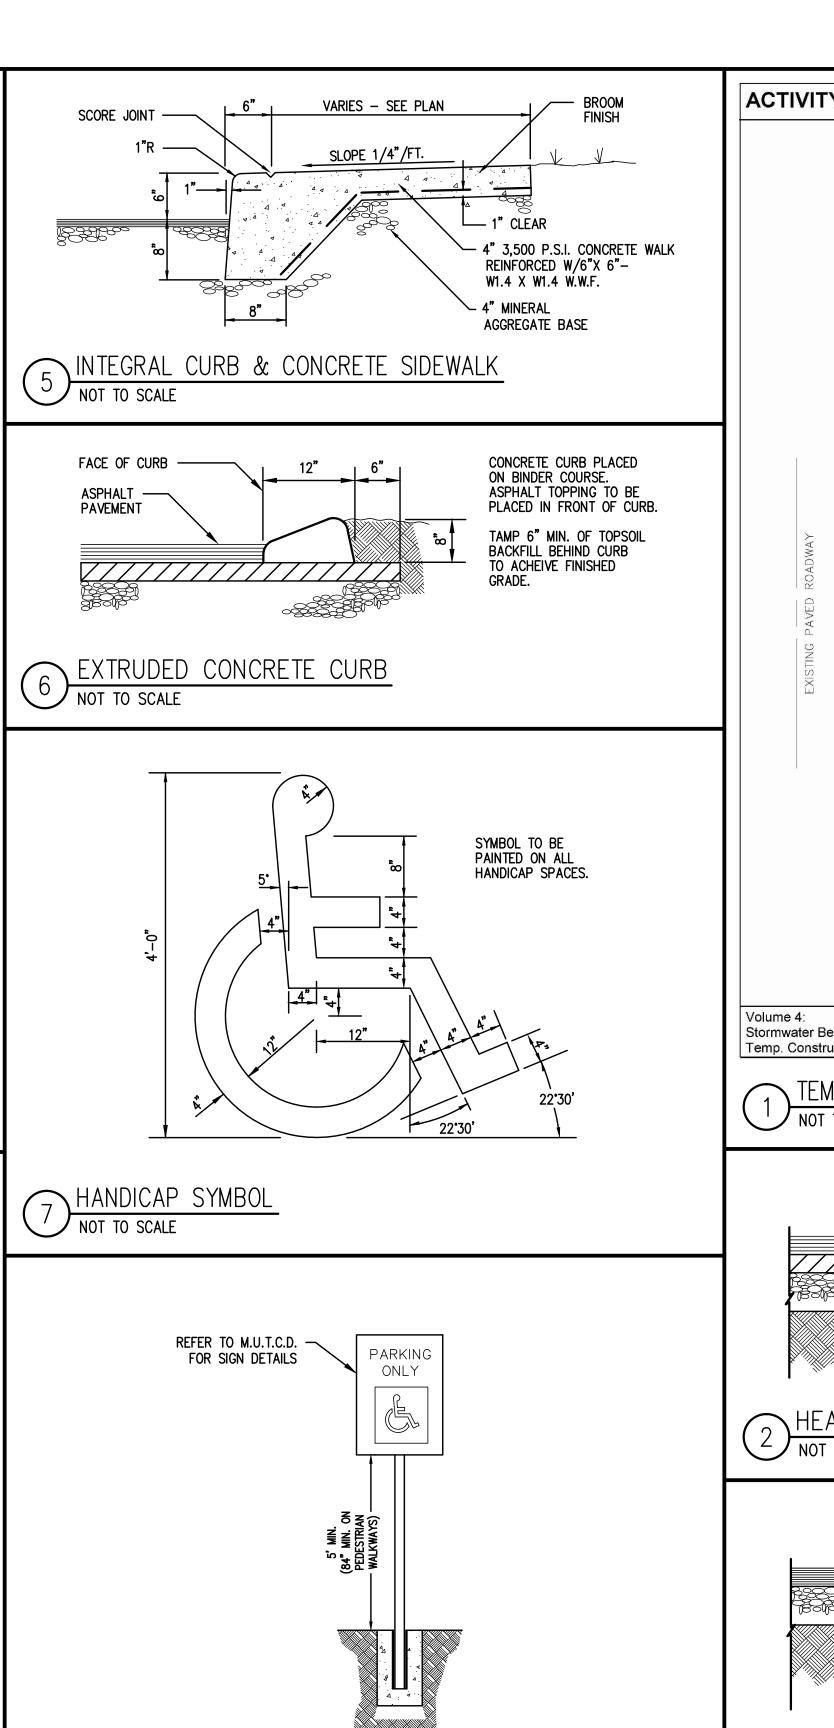

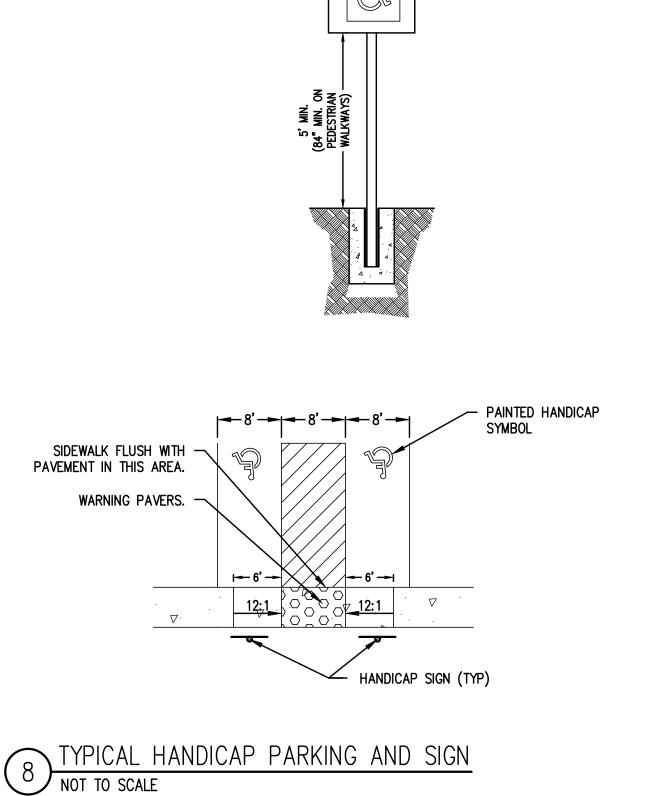


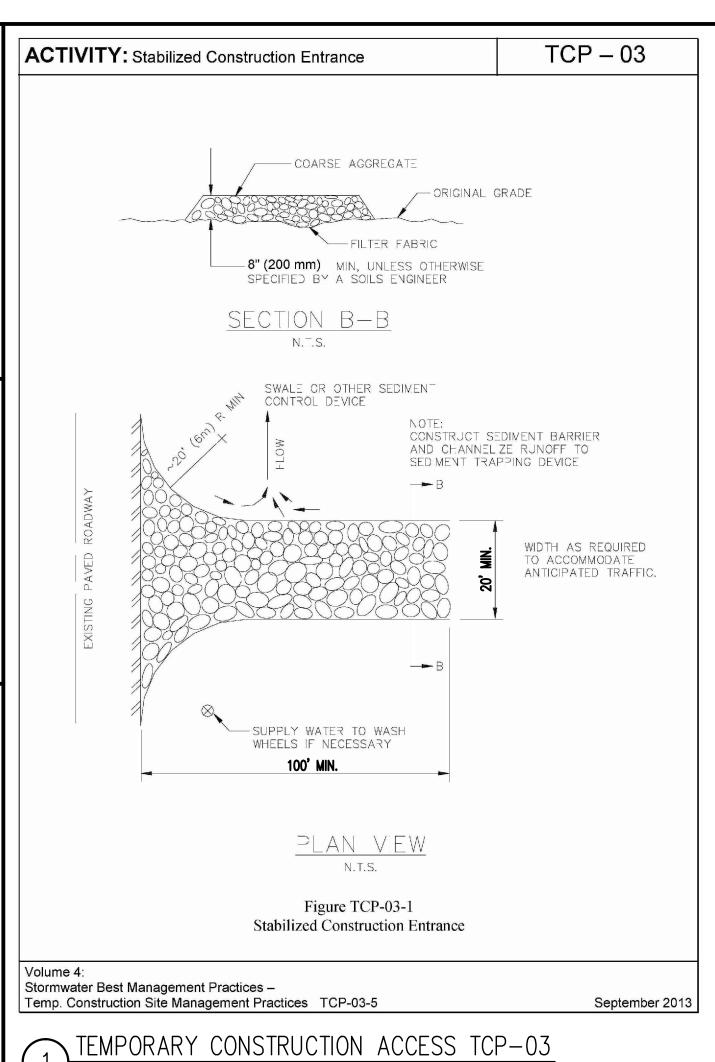

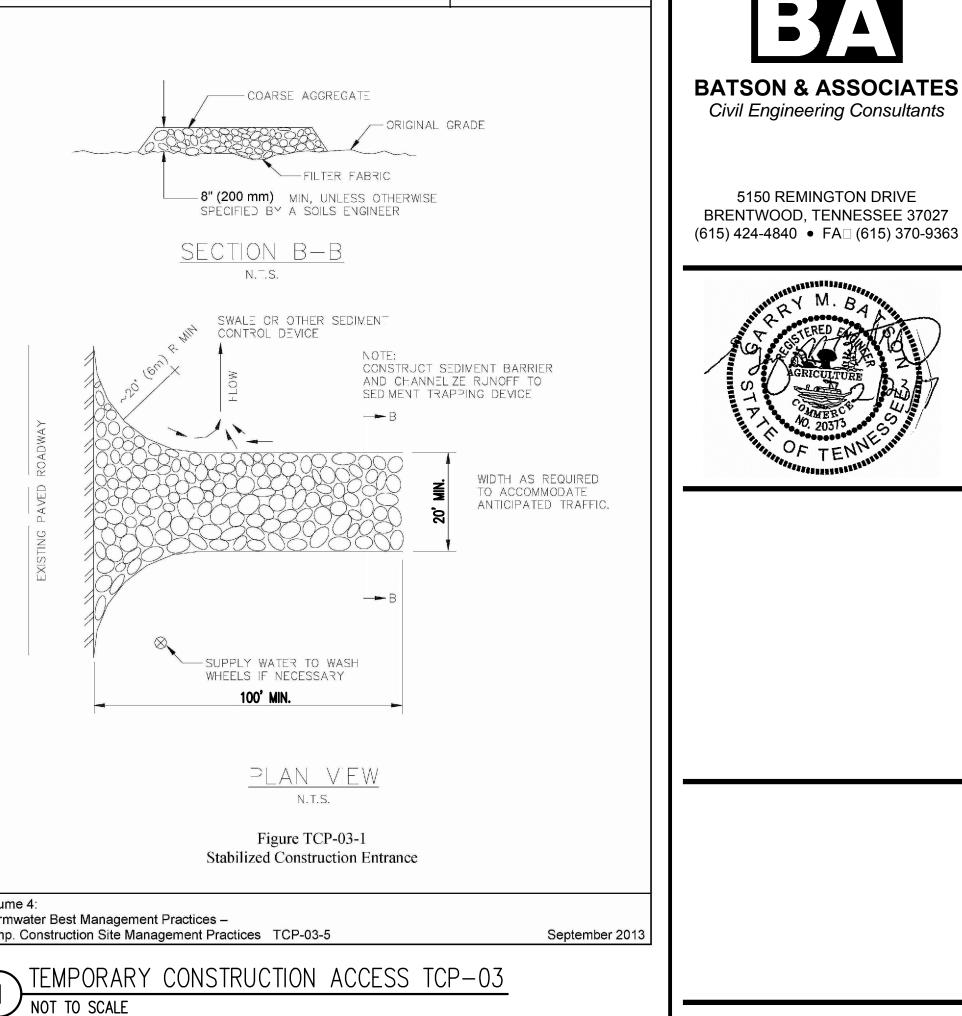

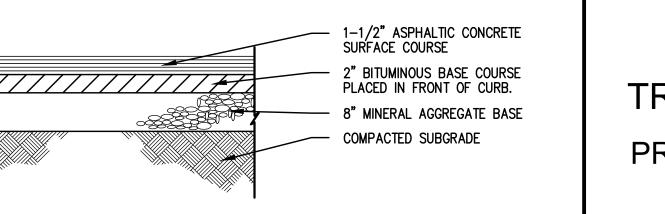


2 HEAVY DUTY PAVEMENT SECTION NOT TO SCALE

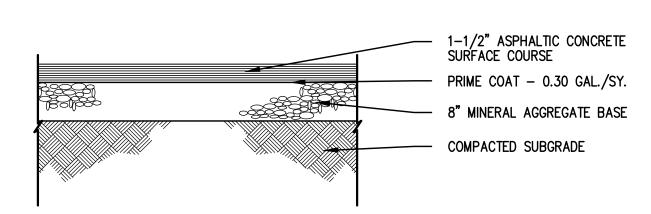

REGULAR DUTY PAVEMENT SECTION NOT TO SCALE

CONCRETE PAVEMENT

NOT TO SCALE

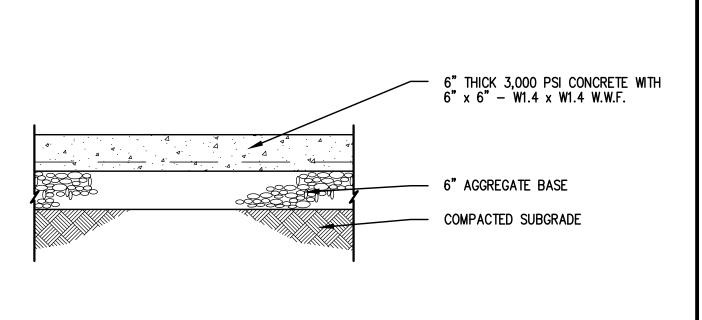



6922 NOLENSVILLE PIKE NASHVILLE, TN


CASE NO	O. 2017SP-	070-001
MAP: 181	PARCEL:	85 & 180

COMMENT	1	19 JUL 2017
COMMENT	2	28 JUL 2017

PROŒCT NO. 28 JUN 2017 DATE **DRAWN BY CHECKED BY**

> STANDARD **DETAILS**


SHEET 12 OF 15

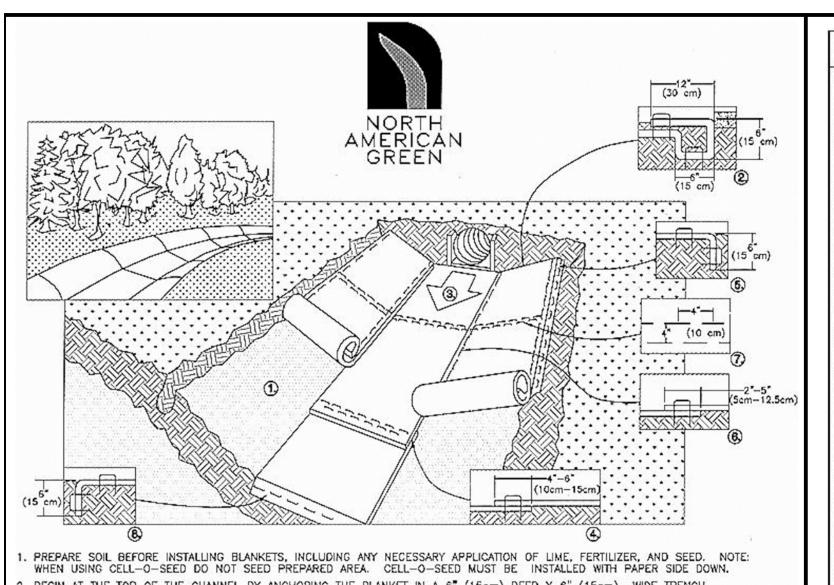

2. BEGIN AT THE TOP OF THE CHANNEL BY ANCHORING THE BLANKET IN A 6" (15cm) DEEP X 6" (15cm) WIDE TRENCH WITH APPROXIMATELY 12" (30cm) OF BLANKET EXTENDED BEYOND THE UP-SLOPE PORTION OF THE TRENCH. ANCHOR THE BLANKET WITH A ROW OF STAPLES/STAKES APPROXIMATELY 12" (30cm) APART IN THE BOTTOM OF THE TRENCH. BACKFILL AND COMPACT THE TRENCH AFTER STAPLING. APPLY SEED TO COMPACTED SOIL AND FOLD REMAINING 12" (30cm) PORTION OF BLANKET BACK OVER SEED AND COMPACTED SOIL. SECURE BLANKET OVER COMPACTED SOIL WITH A ROW OF STAPLES/STAKES SPACED APPROXIMATELY 12" (30cm) APART ACROSS THE WIDTH OF THE BLANKET. 3. ROLL CENTER BLANKET IN DIRECTION OF WATER FLOW IN BOTTOM OF CHANNEL. BLANKETS WILL UNROLL WITH APPROPRIATE SIDE AGAINST THE SOIL SURFACE. ALL BLANKETS MUST BE SECURELY FASTENED TO SOIL SURFACE BY PLACING STAPLES/STAKES IN APPROPRIATE LOCATIONS AS SHOWN IN THE STAPLE PATTERN GUIDE. WHEN USING OPTIONAL DOT SYSTEM™, STAPLES/STAKES SHOULD BE PLACED THROUGH EACH OF THE COLORED DOTS CORRESPONDING TO THE APPROPRIATE STAPLE PATTERN.

4. PLACE CONSECUTIVE BLANKETS END OVER END (SHINGLE STYLE) WITH A 4"-6" (10cm-15cm) OVERLAP. USE A DOUBLE ROW OF STAPLES STAGGERED 4" (10cm) APART AND 4" (10cm) ON CENTER TO SECURE BLANKETS. 5. FULL LENGTH EDGE OF BLANKETS AT TOP OF SIDE SLOPES MUST BE ANCHORED WITH A ROW OF STAPLES/STAKES APPROXIMATELY 12" (30cm) APART IN A 6" (15cm) DEEP X 6" (15cm) WIDE TRENCH. BACKFILL AND COMPACT THE TRENCH AFTER STAPLING. 6. ADJACENT BLANKETS MUST BE OVERLAPPED APPROXIMATELY 2"-5" (5cm-12.5cm) (DEPENDING ON BLANKET TYPE) AND STAPLED. TO ENSURE PROPER SEAM ALIGNMENT, PLACE THE EDGE OF THE OVERLAPPING BLANKET (BLANKET BEING INSTALLED ON TOP) EVEN WITH THE COLORED SEAM STITCH™ON THE BLANKET BEING OVERLAPPED.

7. IN HIGH FLOW CHANNEL APPLICATIONS, A STAPLE CHECK SLOT IS RECOMMENDED AT 30 TO 40 FOOT (9m-12m) INTERVALS. USE A DOUBLE ROW OF STAPLES STAGGERED 4" (10cm) APART AND 4" (10cm) ON CENTER OVER ENTIRE WIDTH OF THE CHANNEL. 3. THE TERMINAL END OF THE BLANKETS MUST BE ANCHORED WITH A ROW OF STAPLES/STAKES APPROXIMATELY 12" (30cm) APART IN A 6" (15cm) DEEP X 6" (15cm) WIDE TRENCH. BACKFILL AND COMPACT THE TRENCH AFTER STAPLING.

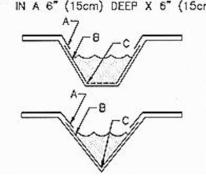


CRITICAL POINTS A OVERLAPS AND SEAMS . PROJECTED WATER LINE . CHANNEL BOTTOM/SIDE SLOPE VERTICES


 HORIZONTAL STAPLE SPACING SHOULD BE ALTERED IF NECESSARY TO ALLOW STAPLES TO SECURE THE CRITICAL POINTS ALONG THE CHANNEL SURFACE. ** IN LOOSE SOIL CONDITIONS, THE USE OF STAPLE OR STAKE LENGTHS GREATER THAN 6" (15 cm) MAY BE NECESSARY TO PROPERLY ANCHOR THE BLANKETS.


14649 HIGHWAY 41 NORTH, EVANSVILLE, INDIANA 47725 USA 1-800-772-2040 CANADA 1-800-448-2040

NORTH AMERICAN GREEN 350 MATTING

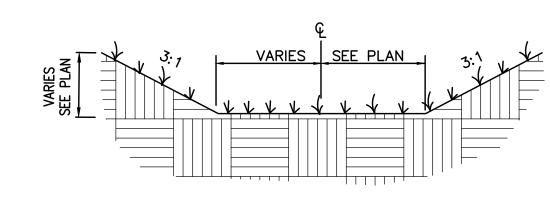

NATURAL FLAT BOTTOM DITCH

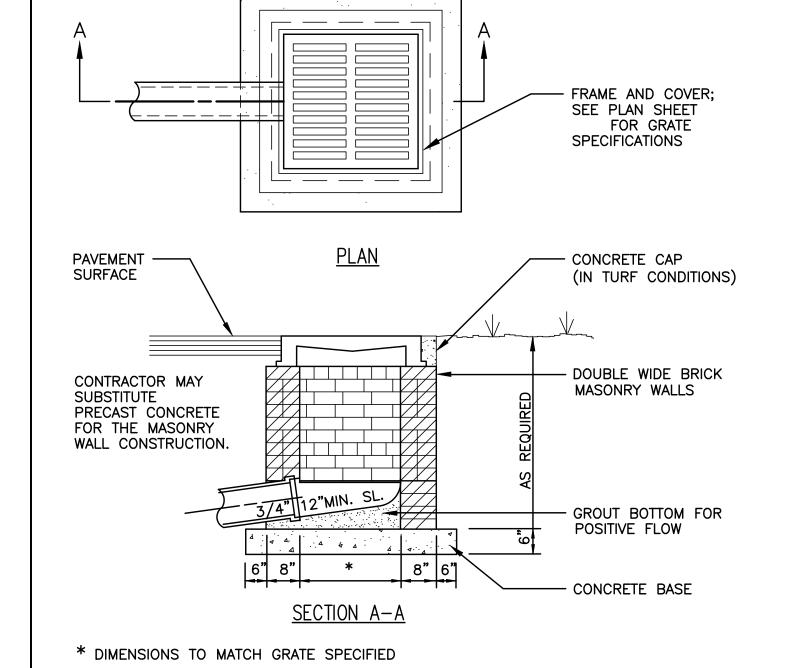

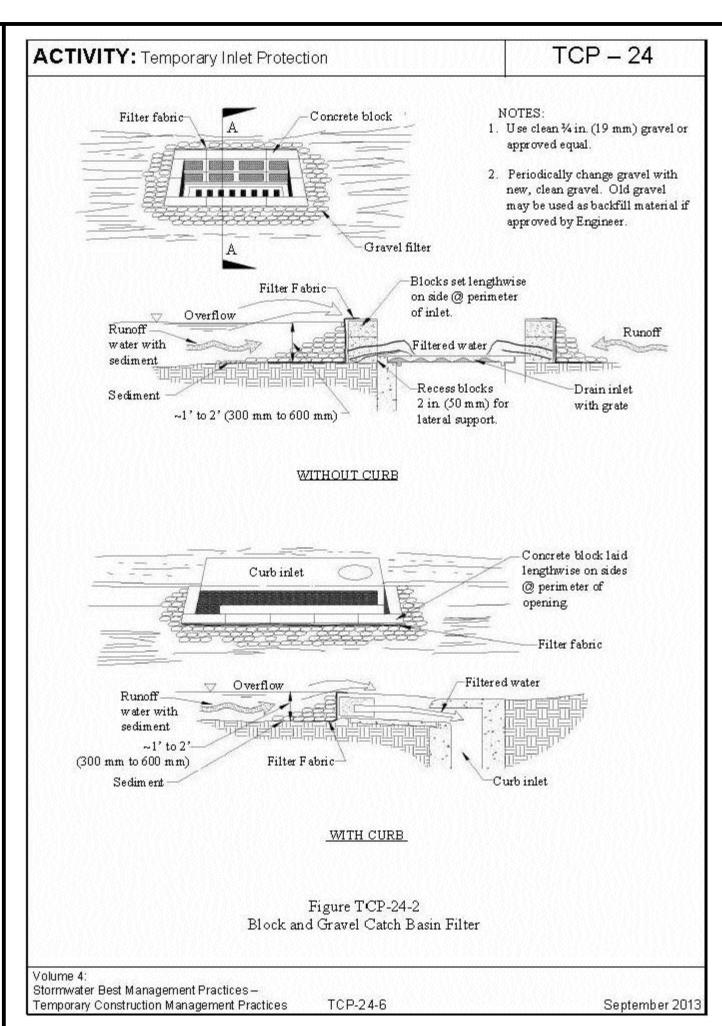


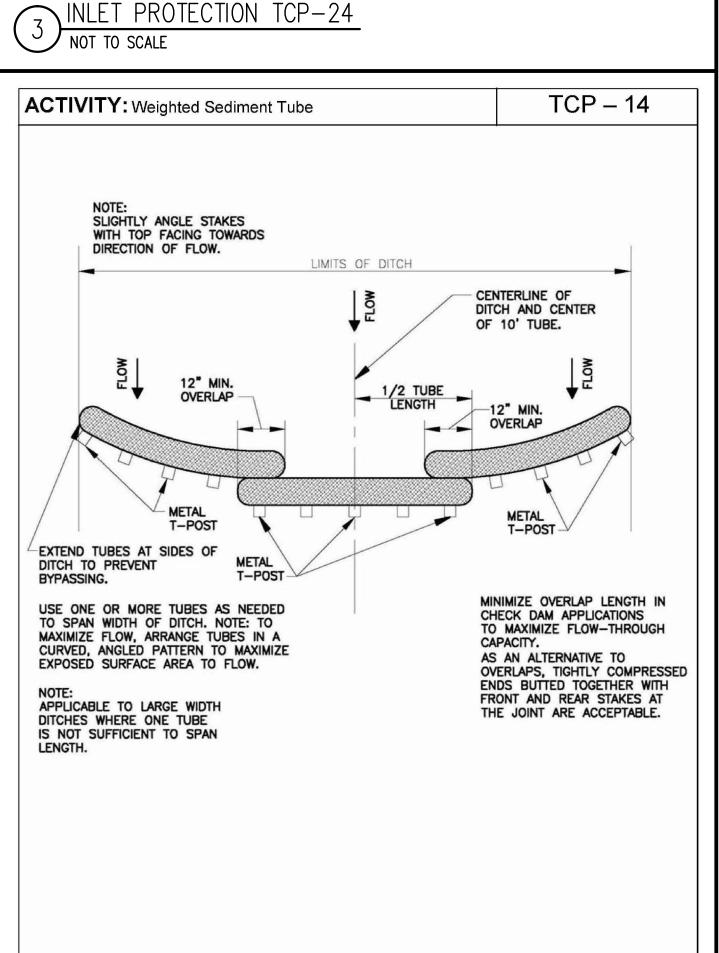



Figure TCP-14-2


Check Dam Arrangement for Larger Width Ditches for Sediment Tubes


August 2009


Stormwater Best Management Practices –
Temp. Construction Management Practices TCP-14-7

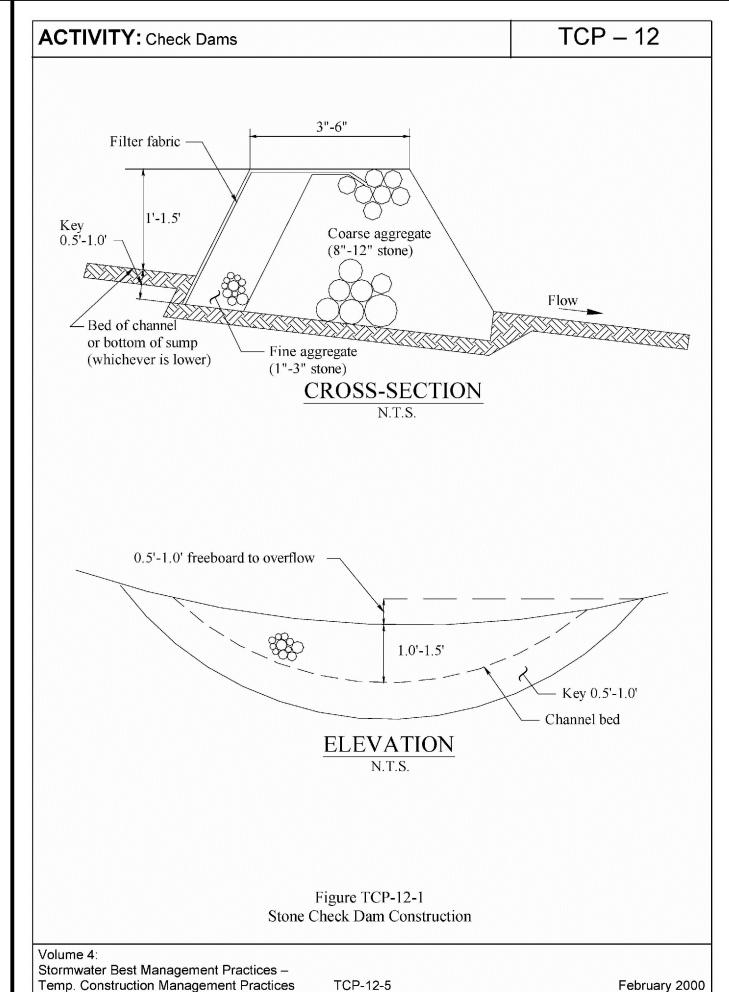


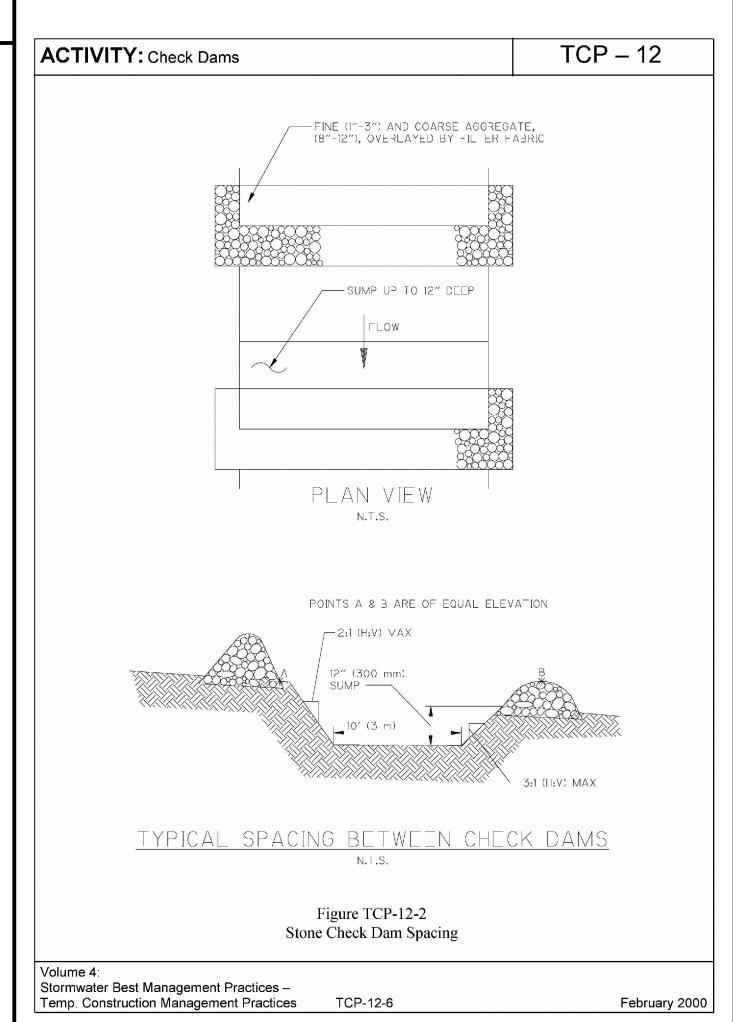

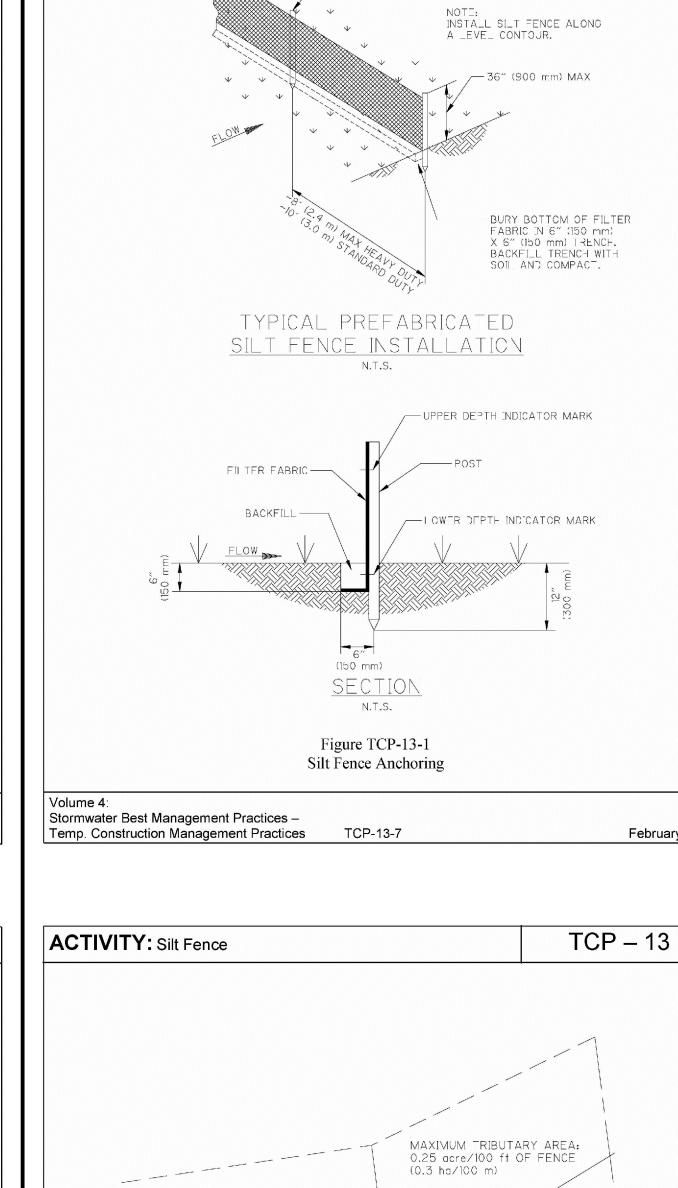

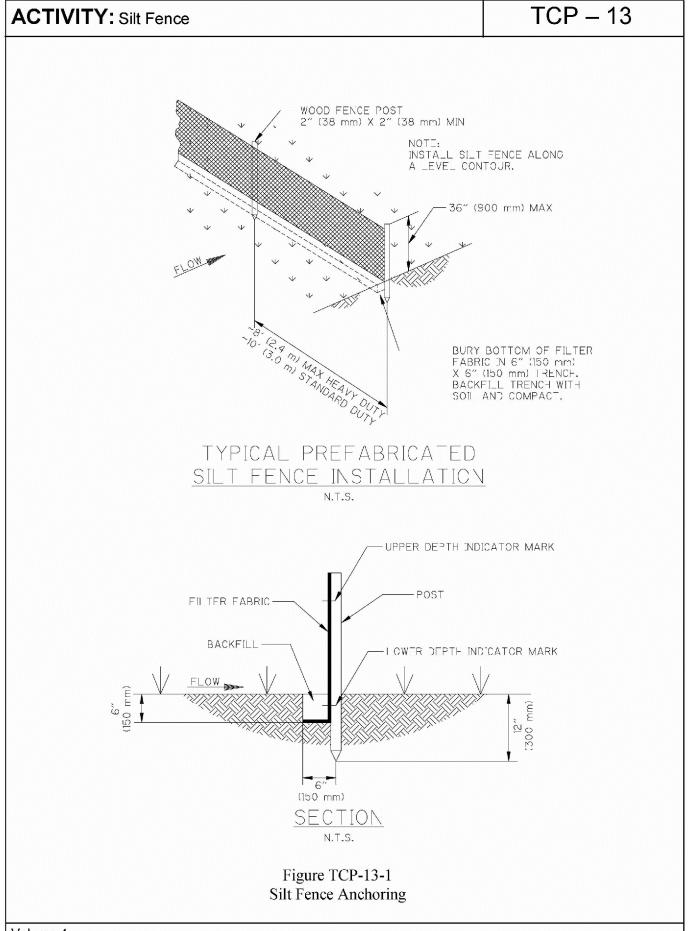

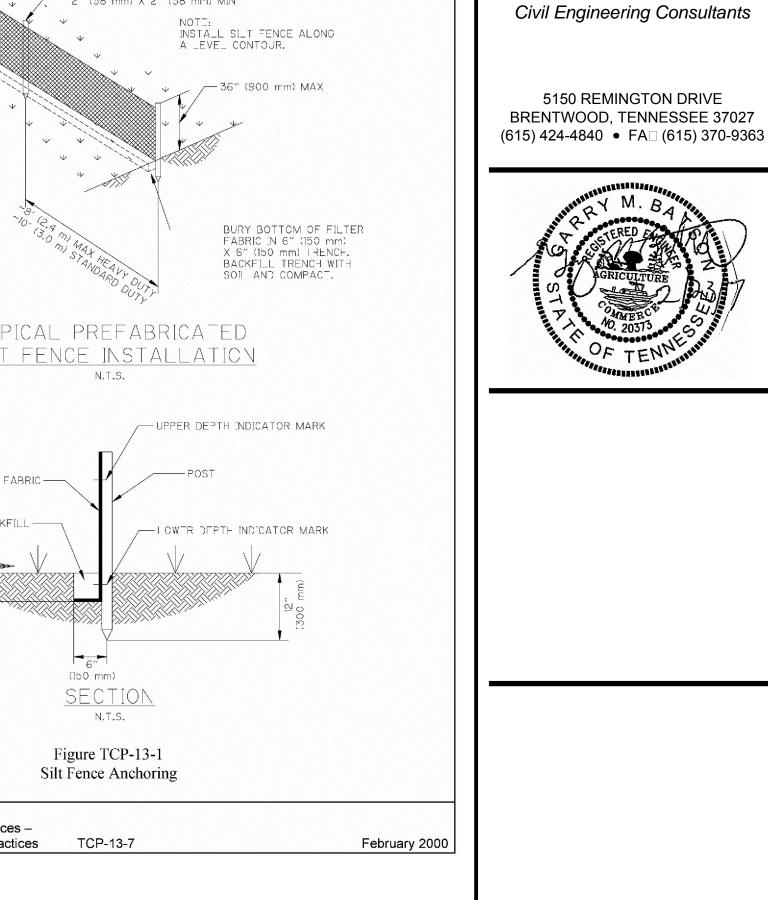

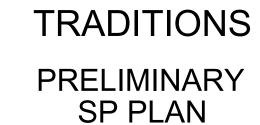

BATSON & ASSOCIATES

6922 NOLENSVILLE PIKE NASHVILLE, TN

CASE NO. 2017SP-070-001 MAP: 181 PARCEL: 85 & 180

DESCRIPTION

DATE

COMMENT	1	19 JUL 2017
COMMENT	2	28 JUL 2017
PROŒCT NO	D .	_


28 JUN 2017 DATE DRAWN BY **CHECKED BY**

STANDARD


DETAILS

SHEET 13 OF 15


February 2000

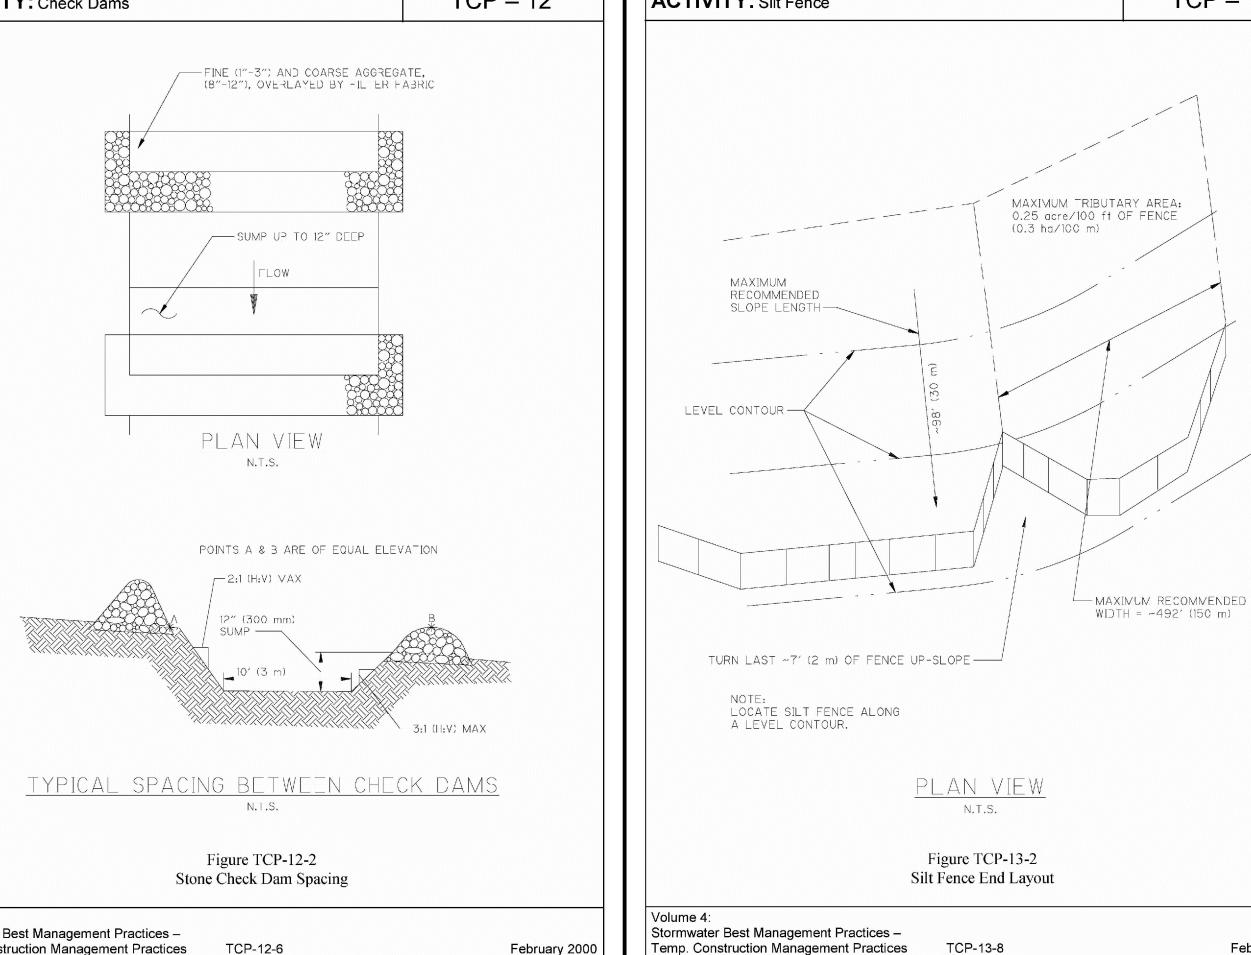


EROSION CONTROL TCP-13 NOT TO SCALE

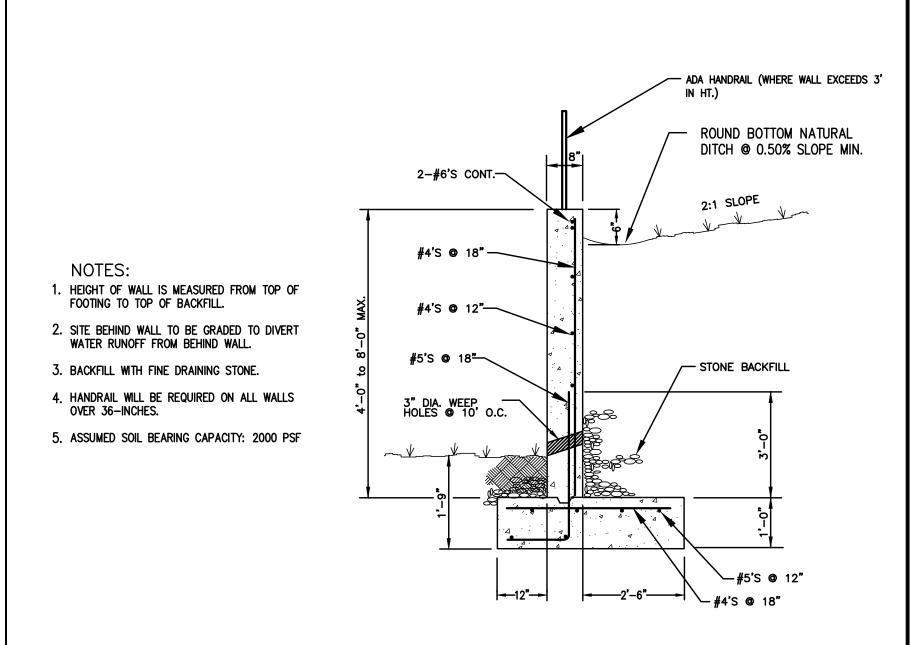

CONCRETE RETAINING WALL SECTION 4 NOT TO SCALE

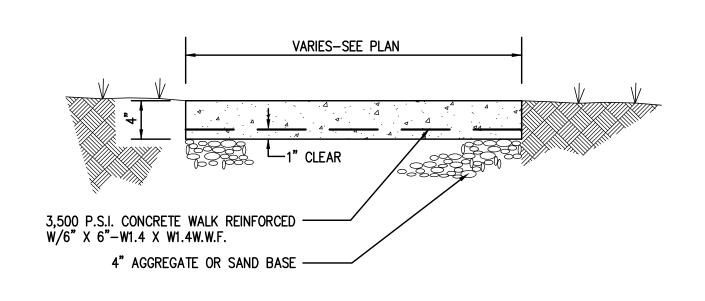

CONCRETE SIDEWALK

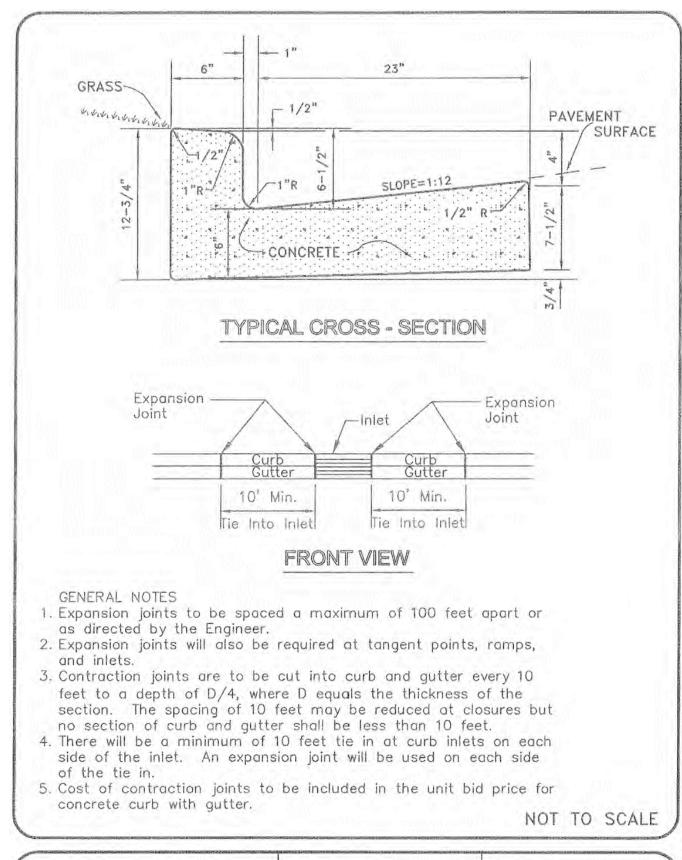


METROPOLITAN GOVERNMENT OF NASHVILLE AND DAVIDSON COUNTY DEPARTMENT OF PUBLIC WORKS	STANDARD CURB WITH GUTTER	DWG. NO	ST-200
DIR. OF ENG .: Mark Many	DATE: 5/12/03	30.30 (M 5.40 - 45 - 10.40) - 1.40 (M 5.40) - 1.40 (M 5.40)	07/21/00 05/02/03


CURB & GUTTER ST-200

SINGLE INLET DR-105

NOT TO SCALE

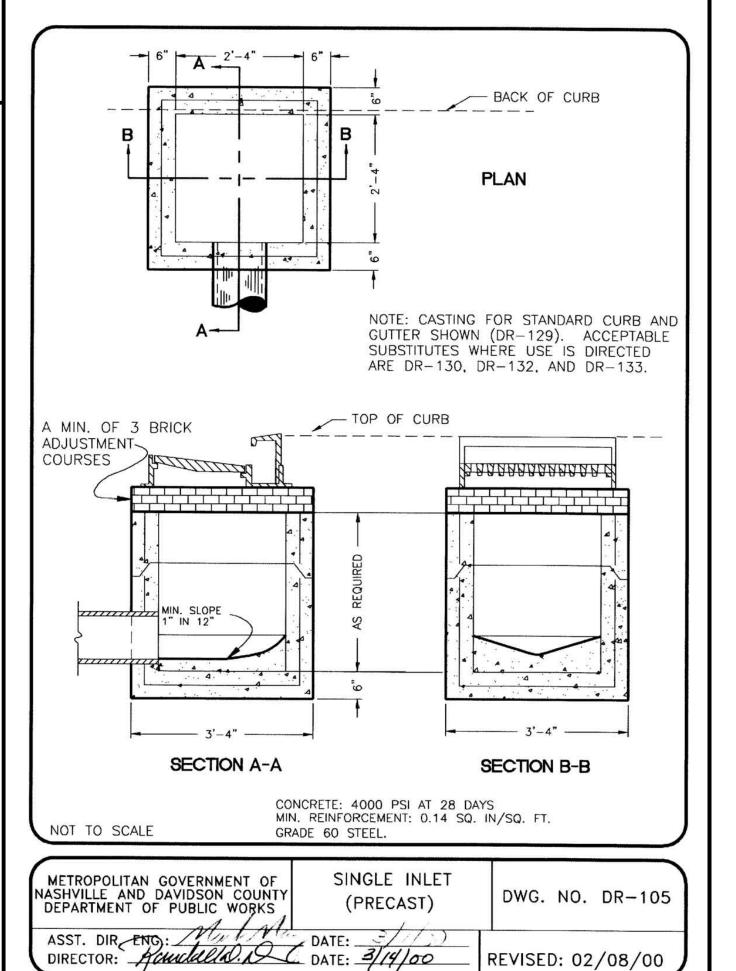


REVISED: 02/08/00

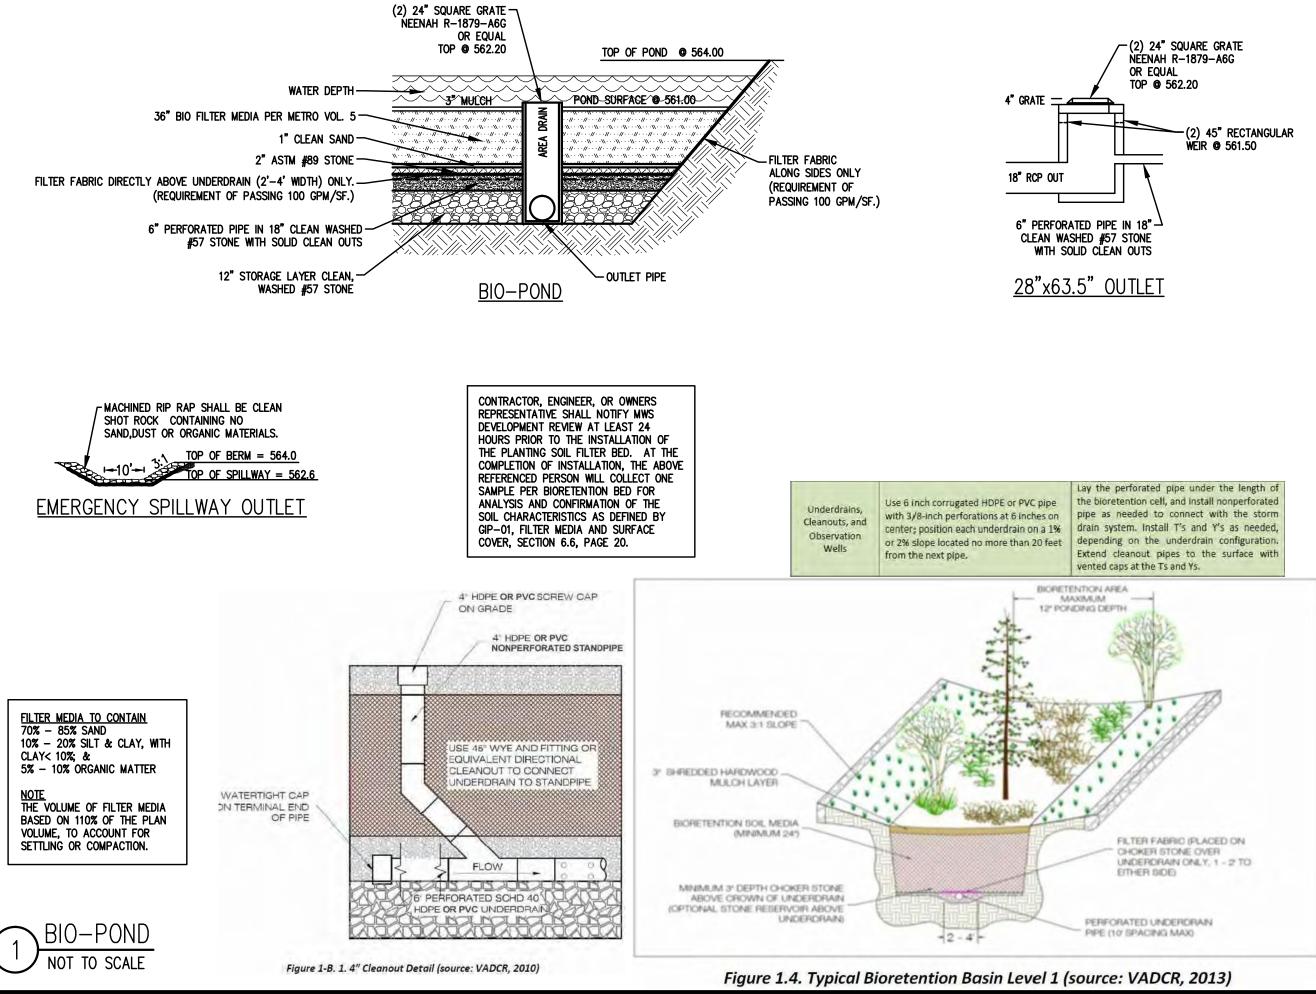



5150 REMINGTON DRIVE BRENTWOOD, TENNESSEE 37027 (615) 424-4840 • FA□ (615) 370-9363

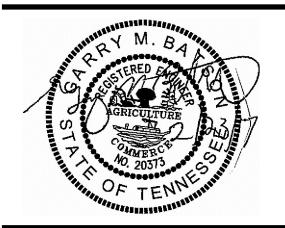

TRADITIONS PRELIMINARY SP PLAN

6922 NOLENSVILLE PIKE NASHVILLE, TN

CASE NO. 2017SP-070-001 MAP: 181 PARCEL: 85 & 180


	DESCRIPTIO	N	DATE
	COMMENT	1	19 JUL 2017
	COMMENT	2	28 JUL 2017
ı			


PROŒCT NO. 28 JUN 2017 DATE DRAWN BY


CHECKED BY


STANDARD **DETAILS**

SHEET 14 OF 15

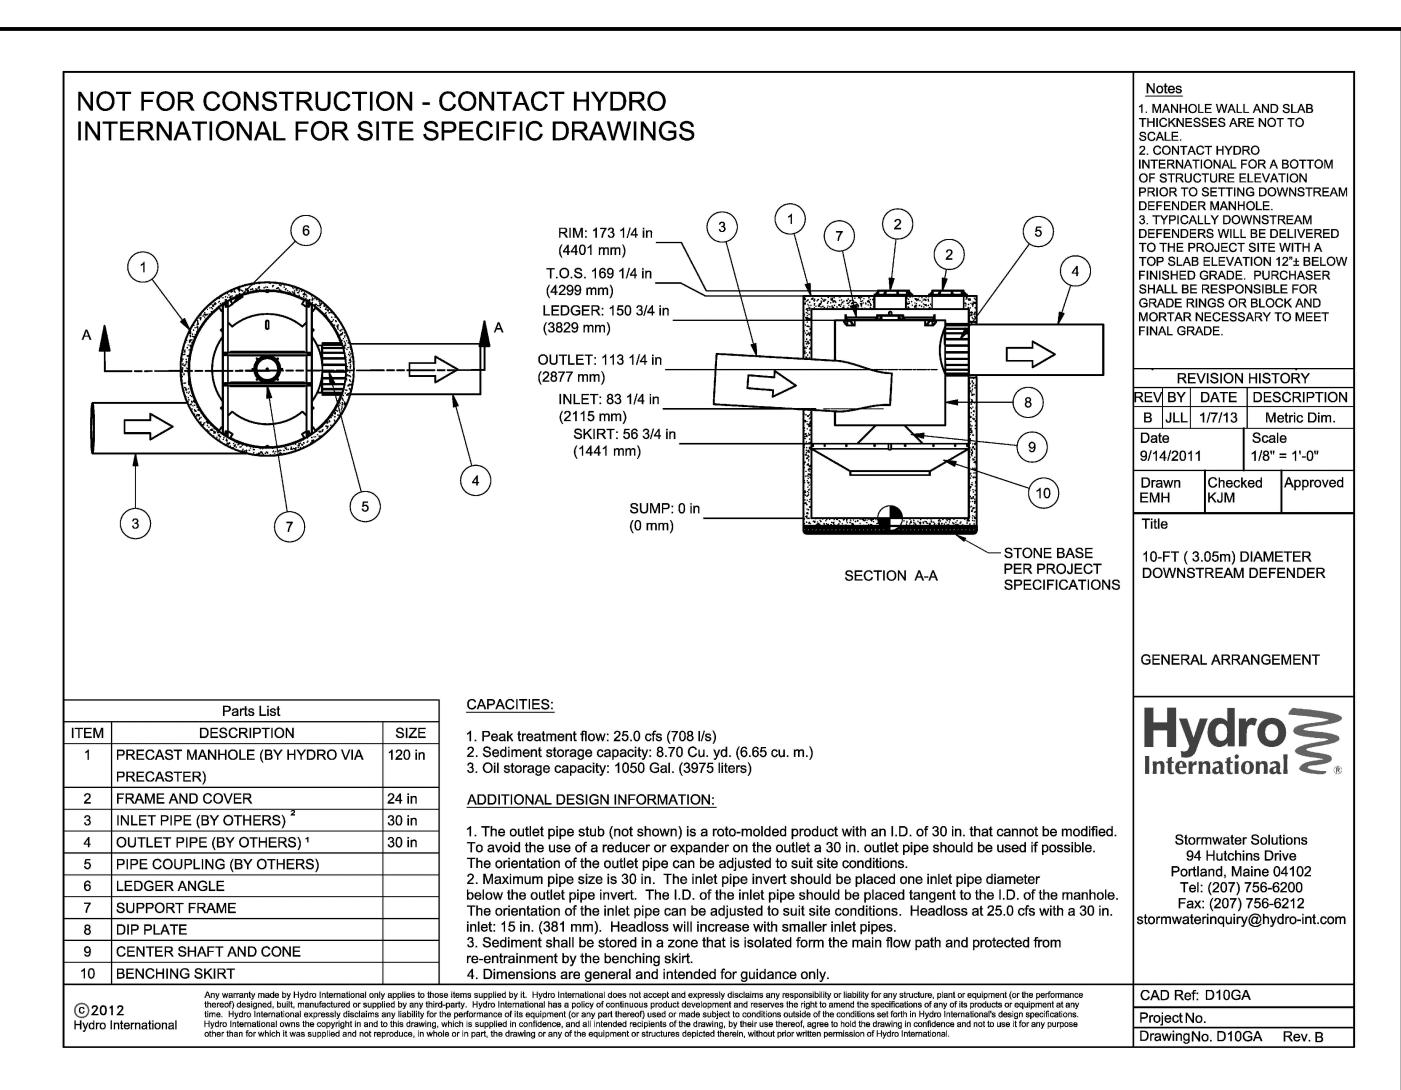


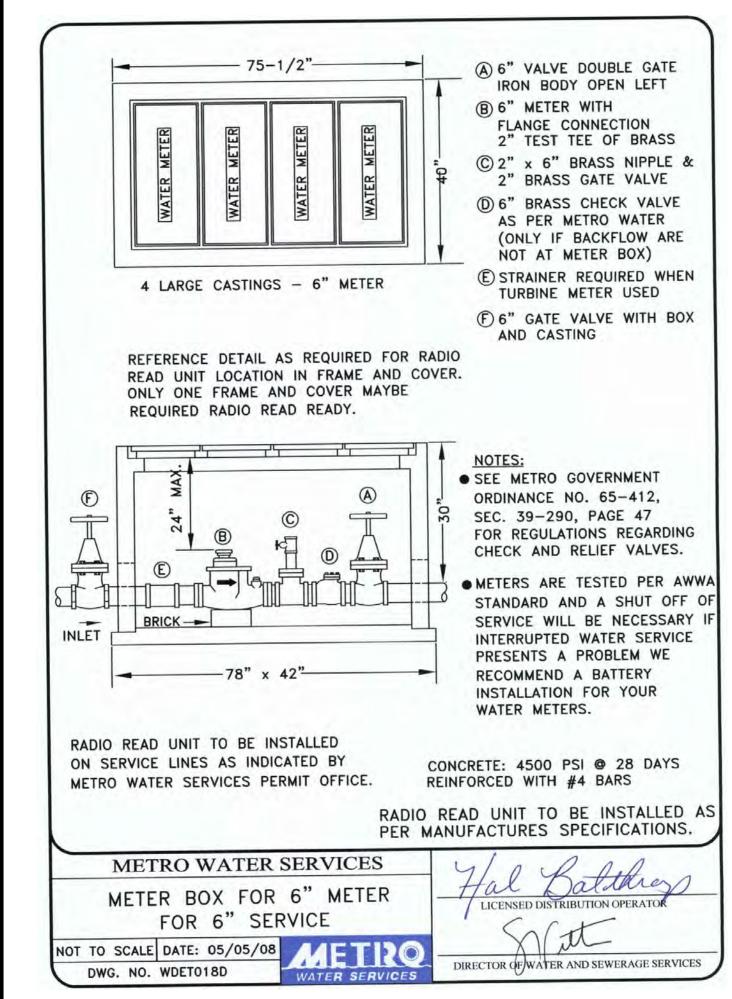

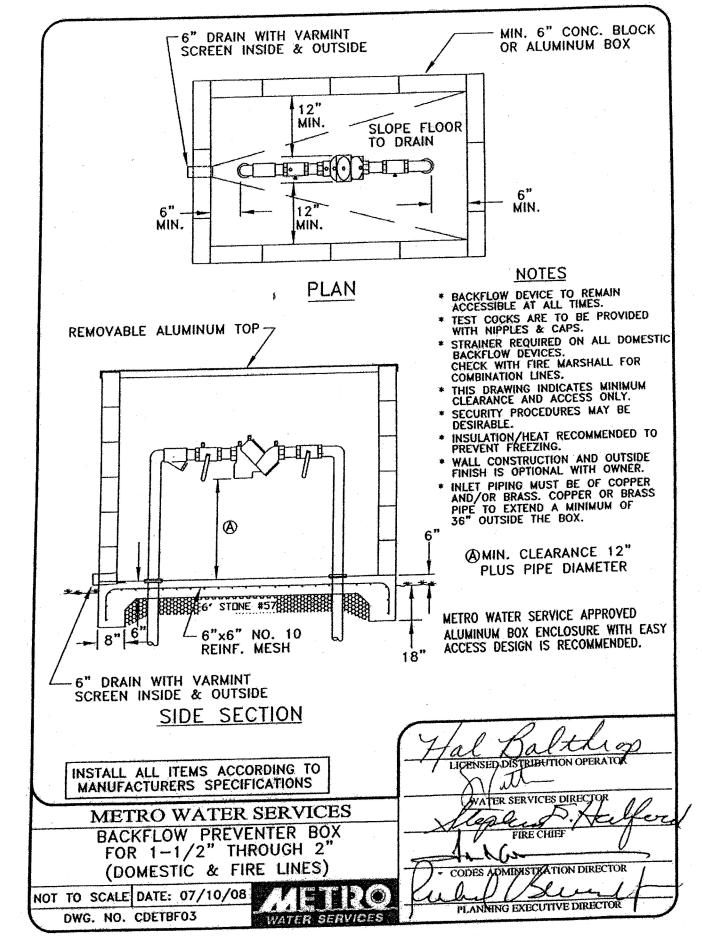

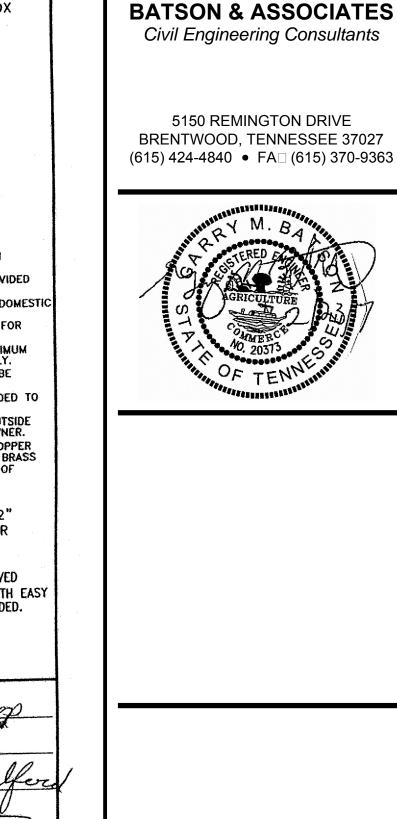



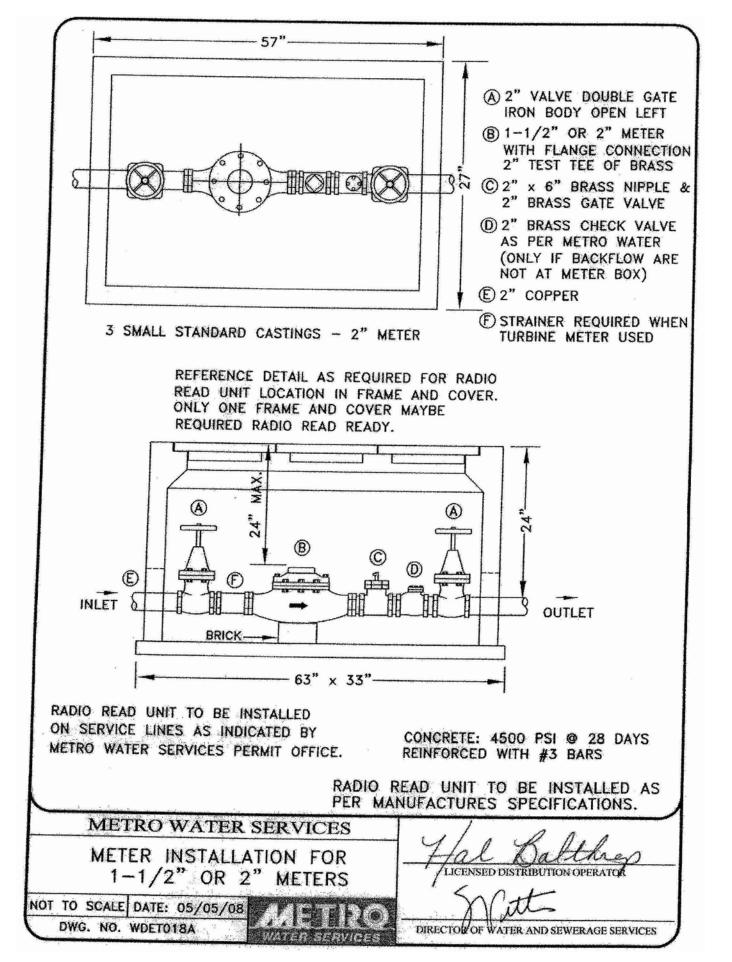

TRADITIONS PRELIMINARY SP PLAN

6922 NOLENSVILLE PIKE NASHVILLE, TN

CASE NO. 2017SP-070-001 MAP: 181 PARCEL: 85 & 180

DATE

19 JUL 2017

DESCRIPTION

COMMENT

COMMENT	2	28 JUL 20
PROŒCT NO.		
DATE		28 JUN 20°
DRAWN BY		N
CHECKED BY		GN

STANDARD DETAILS

C-13

SHEET 15 OF 15

Earl Swensson Associates, Inc.
richard I. miller, architect
1033 Demonbreun Street
Suite 800
Nashville Tennessee 37203
615-329-9445

This drawing and the design shown is the property of the architect. The reproduction, copying or use of this drawing without their written consent is prohibited and any infringement will be subject to legal action.

eais

© Earl Swensson Associates. Inc. 2017

New Independent Living, Assisted Living, and Memory Care for TRADITIONS SENIOR LIVING - NOLENSVILLE

Nolensville

6922

DOCUMENT CHANGES

Description

Issue Description SP SUBMITTAL
Original Issue Date 07/19/17

Original Issue Date 07/19/17
Project No 16145.00
Drawn By MDS Checked By MDS
Drawing Title

EXTERIOR ELEVATIONS

Sheet Number
A2.01

LANDSCAPE NOTES

- 1. The landscape contractor shall verify all material quantities on the drawing during bidding and pricing. In the event of a discrepancy, the quantities drawn on the plan will take precedence over the material schedule.
- 2. The landscape contractor shall verify the exact location of all utilities and take necessary precautions to prevent damage to these utilities.
- 3. The landscape contractor shall coordinate all construction with the appropriate utility company and shall be responsible for any damage to utilities. 4. Topsoil shall be removed from stockpiles and spread in the areas shown on the plans. The depth of topsoil shall be a minimum of 4 inches in lawn
- 5. After the topsoil is in place it shall be fine graded removing all roots, sticks, stones and debris greater than 2 inches in any dimension. The topsoil shall
- be fine graded to the lines and grades shown on the plans. The landscape contractor shall be responsible for the fine grading of all planting areas. 6. The topsoil soil shall have a pH of 5.5 to 7.6 and an organic content of 3 to 20%. The gradation of the topsoil shall be 100% passing 2 inch sieve, 85 to
- 100% passing the 1 inch sieve, 65 to 100% passing the ½ inch sieve and 20 to 80% passing the No. 200 sieve.

areas and a minimum of 12 inches in landscape planting areas.

- 7. Lime of type recommended for soil conditioning shall be used to treat acidic soils. 8. Lawn fertilizer shall be 55% nitrogen, 10% phosphorus and 10% potash where 50% of the nitrogen is derived from ureaform source. A) When placing
- by hydroseeding application fertilizer shall be placed at 80 pounds per acre, hydromulch at 1,200 pounds per acre, water at 500 gallons per acre and seed at a minimum of 220 pounds per acre. All over spray areas shall be properly cleaned and restored at no expense to the contract. B) If placing by mechanical means, fertilizer shall be placed at 25 pounds per 1,000 square feet, seed at 5 pounds per 1,000 square feet, and straw mulch at 2 tons per acre. Place fertilizer and seed, then lightly rake and the roll with 200 pound roller. Mulch the area and then water. Straw may need to be secured
- 9. Water lawn areas as needed to promote growth. The contractor will be responsible to water, reseed or work when necessary to insure the growth of the lawn until a complete and uniform stand of grass has grown and been cut at least twice.
- 10. Unless otherwise noted on the drawings, all areas not receiving structures, pavement, rip rap, landscaping or other improvements or future improvements shall be considered lawn areas and receive topsoil and seeding per drawings and above stated requirements.
- 11. The standards set forth in "American Standard for Nursery Stock" represent general guideline specifications only and will constitute minimum quality requirements for plant material. All plants must meet minimum size noted at the materials schedule. Trees shall be No. 1 grade specimen and shrub
- 12. Planting beds shall be prepared by loosening the top 1 foot of topsoil. Plants shall be located per the plans. The holes shall be excavated (per the details on the drawings) with the center slightly higher to promote drainage. Use a topsoil backfill mix of 4 parts topsoil, 1 part peat moss, 1/2 part we rotted manure, and 10 pounds 5-10-5 planting fertilizer and properly mixed per cubic yard. Berm around plants to form a bowl shape.
- 13. All landscaping shall be guaranteed for one year after final acceptance. Any plantings in need of replacement will be guaranteed from the time of replacement if after final acceptance.

BIO-RETENTION NOTES:

shall be heavy well shaped specimens as well.

- 1. Verify that the bio retention areas have been constructed in compliance of the requirements of the Construction Documents prior to beginning work 2. Care shall be taken to minimize compaction to soils within the limits of the bio retention area(s).
- 3. No machinery (other than walk behind roto-tillers) shall be used within the limits of the bio retention area(s).
- 4. Dig a test percolation pit 1'x1'x1'deep and fill with water. Monitor to verify that all water has drained from the pit within a 24 hour period. If water remains
- after 24 hours, cease all work on the bio retention area and contact Civil Engineer for further instructions. 5. The work required for construction of the bio-retention area(s) consists of removal of weeds, preparation of planting areas, mulching and clean up.
- 6. Contractor is responsible for keeping Bio-Retention area free from sediment resulting from storm-water runoff.
- 7. The Contractor shall conduct all site preparation activities to not allow "sediment loss" to the Bio-Retention Areas.
- 8. Provide or verify installation of a silt fence prior to commencement of construction around the circumference of the Bio-Retention areas.
- 9. Begin construction of Bio-Retention basins after adjacent areas have been stabilized with stone or vegetation.
- 10. Comply with the Water Quality Control Act of 1971, including revisions, and other applicable laws, ordinances, and regulations.
- 11. The Contractor shall correct, at his own expense, any work that does not comply with the requirements of the Contract
- 12. The Contractor shall assume responsibility for protection of public streets, curbs, and utilities from damages from the Contractor's operations. Plan work to avoid ponding, flooding, and sediment loss on site and upon adjacent property.
- 13. Meet the requirements of all rules and regulations governing the respective utilities. Protect active utilities from damage during construction.
- 14. If active utilities are encountered in the course of excavation other than those Indicated on the Survey, protect them from damage and relocate them accordance with the Engineer's written instruction. Remove inactive utilities if such are encountered.
- 15. The finish surface shall be free from any lumps of earth, rocks, stones, debris, or other improper materials, no trees, trunks, shrubs, stumps, undergrowth, or building rubbish will be permitted in the grading.
- 16. Remove weeds with three applications (at 2 week intervals) of a systemic herbicide such as Roundup during the period that weeds are actively growing and prior to preparing the bio retention area for planting.
- 17. Scarify top 6" of soil by hand or with a walk behind roto-tiller prior to the planting of bio retention area. Tractors or other heavy machinery are not to be utilized at anytime within the limits of the bio retention area.

SUBSTITUTION NOTE:

- I. Requirements shown are as per City Zoning Ordinance.
- Substitutions are not allowed unless approved by Heibert+Ball Land Design.
- 2. After installation, the landscape will be maintained by the owner. 3. Additional screening may be required if the inspection for the release of the
- performance bond reveals that the screening is not effective.
- TO AVOID OVERHEAD UTILITY CONFLICTS:
- In the event proposed canopy trees are in conflict (within 25') with proposed or existing overhead utility locations, the landscape contractor shall stop work and contact Heibert+Ball Land Design immediately for coordination and field adjustment.

TO AVOID OVERHEAD LIGHT POLE CONFLICTS: In the event proposed canopy trees are in conflict (within 10') with proposed or existing light pole

- locations, the landscape contractor shall stop work and contact Heiber+Ball Land Design immediately for coordination and field adjustment **UTILITY SCREEN**
- All utility structures, transformers, meters, and/or units shall be screened with plant material tall enough to provide an effective screen. Structures not shown on landscape plans will be required to be screened. If utilities are added to the site, contact Heibert+Ball Land Design for screening
- recommendations PLANT STANDARDS The standards set forth in "American Standard for Nursery Stock" represent general guideline
- specifications only and will constitute minimum quality requirements for plant material. All plants must meet minimum size noted at the materials schedule. And meet the characteristics stated on tl drawing. All material installed on the site MUST meet or exceed these specifications. Any trees or shrubs not meeting these standards can be rejected at time of inspection.
- TREE SPECIFICATIONS: ALL TREES SHALL HAVE THE FOLLOWING CHARACTERISTICS: 1. Deciduous trees shall have one dominant single straight trunk with the tip of the leader
- on the main trunk left intact and the terminal bud on the central leader is at the highest point on the tree.
- 2. Trees with forked trunks are acceptable if all the following conditions are met:
- a. The fork occurs in the upper 1/3 of the tree.
- b. One fork is less than 2/3 the diameter of the dominant fork. c. The top 1/3 of the smaller fork is removed at the time of planting.
- 3. No branch is greater than 2/3 the diameter of the trunk directly above the branch. 4. The trunk and/or major branches shall not touch
- 5. Several branches are larger in diameter and obviously more dominant.
- 6. Branching habit is more horizontal than vertical, and no branches are oriented nearly vertical to the trunk.
- 7. Branches are evenly distributed around the trunk with no more than one major branch located directly above another and the crown is full of foliage evenly distributed around the tree
- 8. Crown spread shall look proportional to the tree. 9. NO flush cuts or open trunk wounds or other bark injury
- 10. Root ball meets all ANSI standards and is appropriately sized DEFICIENCIES NOT ACCEPTED: LANDSCAPE SHALL NOT OBSTRUCT
- . Tip dieback on 5% of branches Crown thin/spasely foliated
- VISIBILITY OR ACCESS TO FIRE PROTECTION EQUIPMENT INCLUDING, 3. Included bark BUT NOT LIMITED TO, FIRE HYDRANTS 4. Major Branches touching AND FIRE DEPARTMENT CONNECTIONS 5. Asymmetrical branching

CALCULATIONS WORKSHEET FOR TREE DENSITY REQUIREMENTS METRO ORD # 094-1104

AREA OF LOT: 3.96 ACRES - 1.24 ACRES BUILDING COVERAGE: AREA OF REQUIRED COMPLIANCE: 2.72 ACRES

REQUIRED TREE DENSITY UNITS: 38.08

PROPOSED NEW TREES:

- $77 \times 0.5 = 38.5$ 2" CAL @ 0.5 CREDIT FOR NEW TREES: 38.5
- PROVIDED TREE DENSITY UNITS: 38.5 **IRRIGATION TO BE PROVIDED BY HOSE BIBS** TREE CUT PERMIT REQUIRED CASE # TBD
- MAP: 181 / PARCEL: 85 & 180
- 1. TREE DENSITY REQUIREMENTS WILL BE MET ONSITE
- 2. TREE CUT PERMIT WILL BE REQUIRED 3. NO LANDSCAPE BUFFERS YARDS WILL BE REQUIRED

REES	COMMON NAME / BOTANICAL NAME	CONT	CAL	SIZE
AS	CANOPY TREE	B & B	2"Cal	12`-14` H
CD	UNDERSTORY TREE	B & B	2"Cal	10`-12` H
CV2	UNDERSTORY TREE	B & B	2"Cal	8`-10` H1
	EVERGREEN TREE	B & B	2"Cal	8`-10` H
LR	COLUMNAR TREE	B & B	2"Cal	10`-12` H
	EVERGREEN TREE	B & B	2"Cal	10` HT
NS NS	CANOPY TREE	B & B	3"Cal	12`-14` H
PR	UNDERSTORY TREE	B & B	3"Cal	12`-14` H
	SCREENING SHRUB	B & B		18" HT

PLAN NOTES:

ZS

- ALL LANDSCAPE BEDS SHALL BE NEATLY TRENCHED WITH A BED EDGE AND HAVE 4" MINIMUM DEPTH OF SHREDDED HARDWOOD MULCH

CANOPY TREE

SHRUB AREAS | COMMON NAME / BOTANICAL NAME

Bio-Retention Plantings

Foundation Plantings

- ALL TREES AND SHRUBS SHALL BE COORDINATED WITH LIGHTING PLAN PRIOR TO INSTALLATION.
- ALL TREES AND SHRUBS SHALL BE PLANTED 3' BEHIND BACK OF CURB. 4. ALL AREAS OF DISTURBANCE OUTSIDE OF LANDSCAPE BEDS NOT SPECIFIED AS SOD SHALL BE

Evergreen and decidious shrubs, grasses,

and groundcover suitable for Bio-Retention areas

SEEDED WITH REBEL III TALL FESCUE

Mix of evergreen and flowering shrubs of various heights


PLANTING SCHEDULE NOTES

- SHRUBS AND TREES TO BE OF THE HIGHEST QUALITY.
- NO SUBSTITUTIONS ALLOWED WITHOUT PRIOR WRITTEN APPROVAL OF THE OWNER AND LANDSCAPE ARCHITECT OF RECORD. SUBSTITUTIONS AND DEVIATIONS MAY OR MAY NOT BE APPROVED.

B & B | 2"Cal | 12`-14` HT

Varies

- REVISED LANDSCAPE PLANS MUST BE SUBMITTED AND APPROVED BY THE URBAN FORESTER
- 5. ALL IRRIGATION, LAWN AND PLANT MATERIALS WITHIN THE ROW MUST BE MAINTAINED BY THE PROPERTY OWNER.

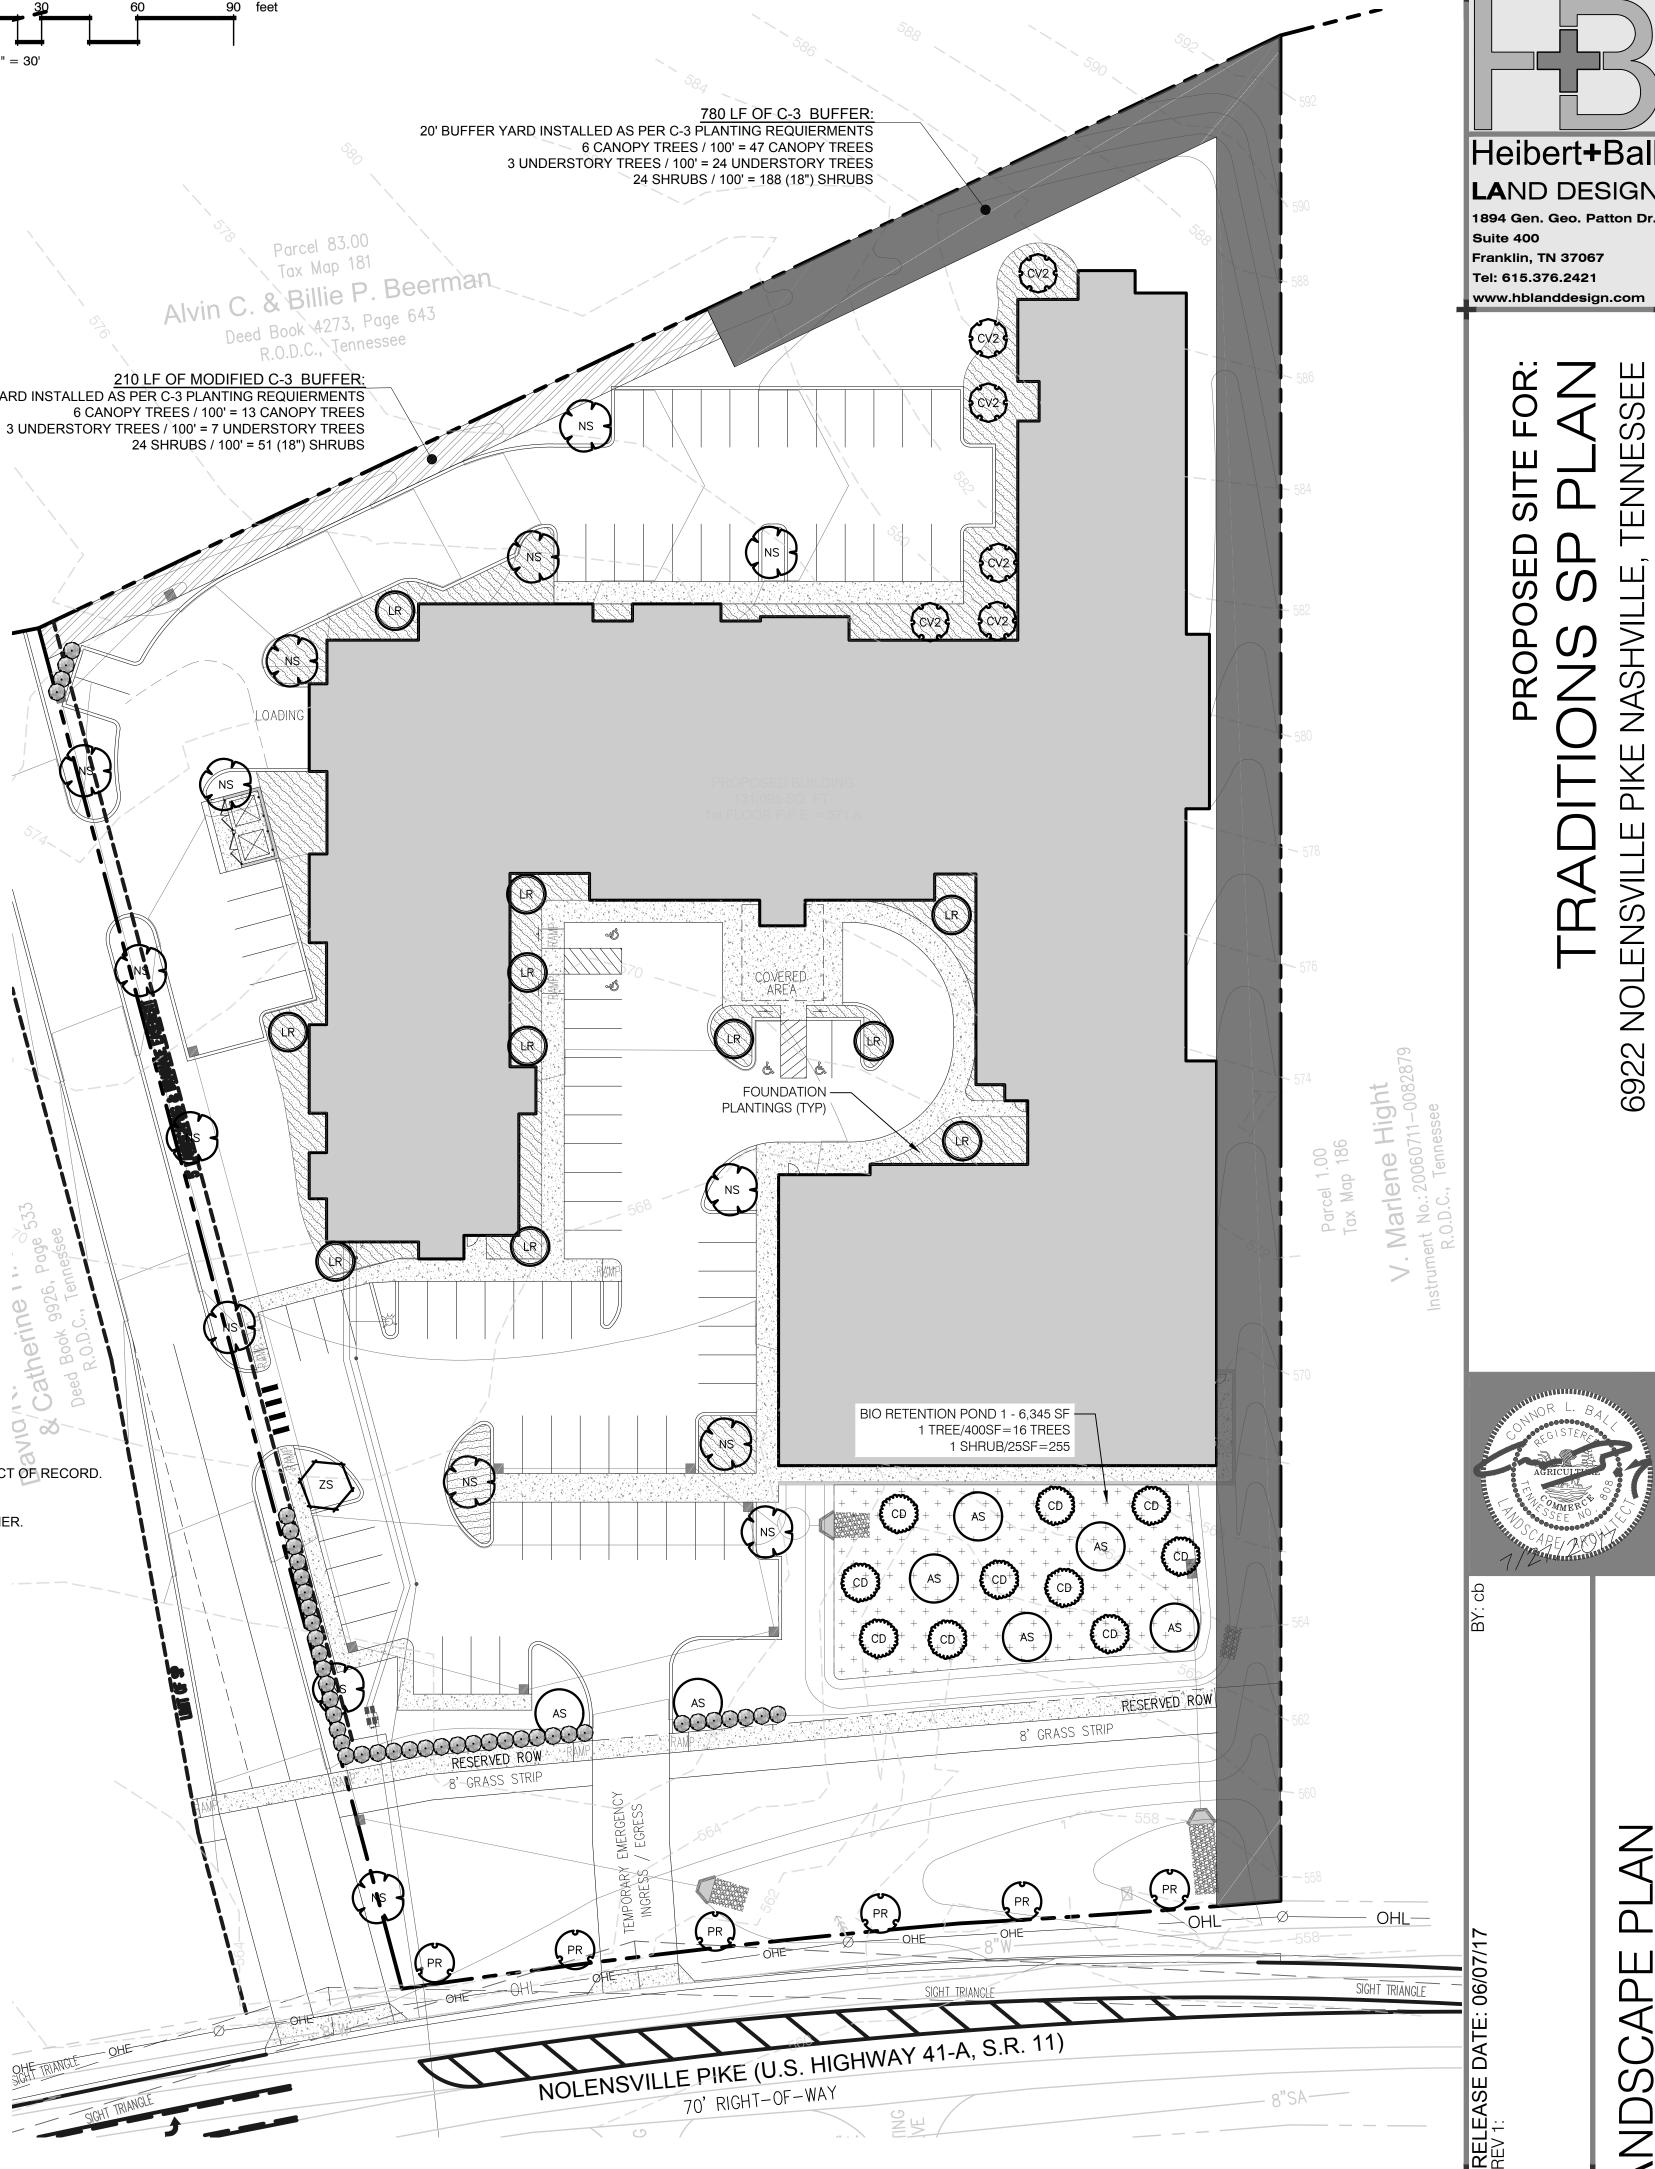

0

 \Box

Д

ZONING REVIEW CHECKLIST NONDECIDENTIAL AND MILL TIEAMS Y CONCEDITION

NONRESIDENTIAL AND MULTIFAMILY CONSTRUCTION		
APPLICATION # PROJECT NAME:		
MAP# / PARCEL # EXAMINER:		
USE — CHAPTER 17.08 AND 17.16 **A — APPROVED, D — DENIED, I — INCOMPLETE, P — PENDING, C — CI	ONDITIONAL**	
DETERMINE THE USE: ASSISTED LIVING FACILITY		
PROPERTY ZONING: AR2A OVERLAY(S): N/A SURROUNDING ZONING: AR2A		
USE CHARTS (P, PC, SE, A): NONE REQUIRED	8	
SITE CRITERIA **SUPPLEMENTAL CHECKUST ALSO REQUIRED FOR UDO**	70.1	
SUBDIVISION PLAT (NOTE ANY SPECIAL REQUIREMENTS SUCH AS EASEMENTS, SETBACK RESTRICTIONS AND E	(C.)	
MINIMUM LOT SIZE: N/A BUILDING FOOTPRINT: 131,095 SQ. FT.		
FAR 0.80% MAXIMUM 0.80% REQUESTING		
ISR - ADJUSTMENTS / SLOPES OVER 11% 0.80% MAXIMUM 0.80% REQUESTING STREET SETBACK / STREET TYPE(S): 40 FT.		
SIDE YARD: 20 FT.		
REAR YARD: 20 FT.		
HEIGHT STANDARDS: 2:1 NUMBER OF FLOORS: 4		
PARKING AND ACCESS - CHAPTER 17.20 *SUPPLEMENTAL CHECKLIST ALSO REQUIRED FOR UDO**		
RAMP LOCATION AND NUMBER: ONE SOUTHWEST	fi.	
DISTANCE TO NEAREST EXISTING RAMP (MINIMUM 30'): 30+ FT.	- 5	
DISTANCE TO INTERSECTIONS 50' MINOR STREET: 400 FT. 185' ARTERIAL STREET: NONE		
100' COLLECTOR: NONE 250' CONTROLLED ACCESS RAMP: NONE		
REQUIRED PARKING BASED ON USE: 74 REQUIRED 90 PROVIDED		
REQUIRED LOADING BASED ON USE: NONE REQUIRED NONE PROVIDED		
SURFACING OVER 5 SPACES 1,750 SQ. FT.: PROVIDED	Q.	
SPACE SIZES, AISLE WIDTHS, ANGLE DATA: 9 FTx18 FT, 24 FT, 90"	Ĵ	
QUEUING LANES: PROVIDED	j j	
OVER 10 SPACES 20' QUEUING AT EXIT: PROVIDED	j.	
NUMBER OF COMPACT SPACES / %: NONE / 0%	Ü	
NUMBER OF HANDICAPPED SPACES: 4	j	
SIDEWALKS REQUIRED: INTERNAL PROVIDED PUBLIC PROVIDED	-	
LANDSCAPING STANDARD - CHAPTER 17.24 **SUPPLEMENTAL CHECKLIST ALSO REQUIRED FOR UDO**		
REQUIRED BUFFER YARDS: NONE REQUIRED	3	
BUFFER YARD ADJUSTMENT: NONE REQUIRED	S S	
PERIMETER LANDSCAPING (CAN NOT BE OVER FUTURE R.O.W.) : NONE REQUIRED		
STANDARD FOR 4 OR MORE LANES: NONE REQUIRED		
STANDARD FOR LESS THAN FOUR LANES: PROVIDED	ALUCES.	
SIDE LINES ADJACENT TO PARKING AREAS 5' MINIMUM WIDTH W/ TREES — 2.5' W/ TREE ISLANDS: NONE RE	QUIKED	
INTERIOR LANDSCAPING MINIMUM 8% AREA: PROVIDED	J.	
OPAQUE FENCE ADJACENT TO RESIDENTIAL IN PARKING AREA: NONE REQUIRED	-	
SCREENING AROUND DUMPSTERS (NO CHAIN LINK FENCE PERMITTED) : PROVIDED		
TREE DENSITY:		
CHAPTER 17.16 ADDRESSES THOSE SPECIAL FEATURES REQUIRED FOR PC, SE AND A USE. ALL SPECI	AL	

REQUIREMENTS ARE TO BE REVIEWED AS PART OF THE ZONING PLAN REVIEW AND SPECIAL FEATURES CHAPTER 17.28 IDENTIFIED ON PLANS. ENVIRONMENTAL AND OPERATIONAL STANDARDS, CHAPTER ADDRESSES DEVELOPMENT STANDARDS FOR ENVIRONMENTALLY SENSITIVE LOTS AND CAN REQUIRE ADDITIONAL CALCULATIONS. IT ALSO

CHAPTER 17.32 ADDRESSES THE NOISE LIGHT, AND OTHER POLLUTIONS CONTROLS ALONG WITH STORAGE OF FLAMMABLE GOODS. CHAPTER 17.36 SIGN REGULATIONS. SIGN PERMITS ARE APPLIED FOR ON SEPARATE APPLICATIONS AND ARE NOT CHAPTER 17.40 PART OF THE ZONING REVIEW FOR BUILDING PERMIT.

THIS SECTION OUTLINES SPECIAL RESTRICTIONS AND ENABLING LANGUAGE FOR OVERLAY DISTRICTS. ADDRESSES THE ADMINISTRATIVE PROVISIONS OF THE CODE ALONG WITH POWERS OF THE BOARD OF

FLOOR	S	1BR	SH	2BR	TOTAL
FIRST			ness		0.000000000000000000000000000000000000
L.	2	5	(88)	1	8 UNITS (9 BEDS)
AL	223		(<u> </u>	
MC	24	:: ::: :	1000	==	24 UNITS (24 BEDS)
SECOND		V			3220 07
IL.	5	11	(Fig. 6)	1	17 UNITS (18 BEDS)
AL	8	10	5	1	24 UNITS (25 BEDS)
THIRD					
JL,	5	11	200	1	17 UNITS (18 BEDS)
AL	6	11	5	1	23 UNITS (24 BEDS)
FOURTH					8 8 8
Lanca sanalla	5	11	3 <u>**</u> 0	1	17 UNITS (18 BEDS)
TOTAL				200	
IL.	17	38		4	59 UNITS (63 BEDS)
AL	14	21	10	2	47 UNITS (49 BEDS)
MC	24	-	-	<u> </u>	24 UNITS (24 BEDS)

GENERAL SITE NOTES:

- 1. THE PURPOSE OF THIS SP IS TO PERMIT AN ASSISTED CARE LIVING FACILITY AND A MAXIMUM OF 59 MULTI-FAMILY RESIDENTIAL UNITS. (SEE TABLE ABOVE)
- 2. FEDERAL COMPLIANCE: ALL DEVELOPMENT WITHIN THE BOUNDARIES OF THIS PLAN MEETS THE REQUIREMENTS OF THE AMERICANS WITH DISABILITIES ACT AND THE FAIR HOUSING ACT. ADA: HTTP://www.ada.gov U.S. JUSTICE DEPT.: HTTP://www.justice.gov/crt/housing/fairhousing/about_fairhousingact.htm
- 3. DIMENSIONS SHOWN ARE TO THE FACE-OF-CURB UNLESS OTHERWISE NOTED.
- 4. REFER TO ARCHITECTURAL PLANS FOR EXACT DIMENSIONS AND LOCATIONS OF UTILITY SERVICE ENTRY LOCATIONS, PORCHES, RAMPS, SIDEWALKS, AND PRECISE BUILDING DIMENSIONS.
- 5. ALL CURB RETURN RADII TO BE A MINIMUM OF 3 FEET UNLESS NOTED OTHERWISE HEREON.
- 6. CONTRACTOR SHALL BE RESPONSIBLE FOR REMOVAL AND DISPOSAL OF ALL DEBRIS, MATERIAL AND RUBBISH RESULTING FROM THE PREVIOUS AND CURRENT DEMOLITION OPERATIONS, DISPOSAL PROCEDURES SHALL BE IN ACCORDANCE WITH ALL LOCAL, STATE, AND FEDERAL REGULATIONS GOVERNING SUCH OPERATIONS.
- THE LOCATION OF ALL PROPERTY LINES AND EXISTING UTILITIES, THE LEGAL DESCRIPTION, TOPOGRAPHIC CONTOURS, AND SPOT ELEVATIONS, AND ALL PHYSICAL FEATURES INCLUDING STRUCTURE LOCATIONS WERE PROVIDED BY: JAMES TERRY & ASSOCIATES, LAND SURVEYORS 2601 ELM HILL PIKE, SUITE R NASHVILLE, TENNESSEE 37214 PHONE: (615) 490-6920
- 8. THE CONTRACTOR SHALL VERIFY LOCATIONS OF ALL EXISTING UTILITIES (INCLUDING STORM DRAINAGE PIPES OR STRUCTURES) BEFORE COMMENCEMENT OF CONSTRUCTION.
- 9. THE CONTRACTOR SHALL COMPLY WITH ALL PERTINENT PROVISIONS OF THE MANUAL OF ACCIDENT PREVENTION IN CONSTRUCTION ISSUED BY AGC OF AMERICA, INC., AND THE SAFETY AND HEALTH REGULATIONS FOR CONSTRUCTION ISSUED BY THE U.S. DEPARTMENT OF LABOR.
- CONTRACTOR SHALL GIVE ALL NECESSARY NOTICES AND OBTAIN ALL PERMITS.

GENERAL PLAN CONSISTENCY:

- 1, THE EXISTING PROPERTY HAS A SMALL RESIDENTIAL HOUSE ON ONE OF THE TWO LOTS. THE LARGER LOT IS VACANT. THE GENERAL PLAN CALLS FOR THIS PROPERTY BEING DEVELOPED RESIDENTIAL WHICH THE PROPOSED ASSISTED LIVING SITE IS ALLOWED.
- 2. THE NORTHERN PROPERTY LINE OF THE SP ALSO IS THE LINE IN THE GENERAL PLAN WHERE THE PROPERTY TO OUR NORTH IS PLANNED FOR COMMERCIAL USE.



BUILDING MATERIAL LIST

DOORS EXTERIOR SERVICE DOORS ARE TO BE FLUSH STEEL DOORS IN GALVANIZED HOLLOW METAL FRAMES. EXTERIOR ENTRY DOORS AND DOORS IN VESTIBULE AT MEMORY CARE TO BE FULL-GLASS STOREFRONT TYPE DOORS. ENTRY DOORS AT IL/AL ENTRY VESTIBULE ARE TO BE BI-PARTING AUTOMATIC GLASS ENTRY DOORS.

EXTERIOR DOORS AT PORCHES AND COURTYARDS ARE TO BE A

EXTERIOR WINDOWS TO BE FIBERGLASS SINGLE-HUNG IN STANDARD FACTORY COLOR. (MARVIN INTEGRITY OR APPROVED WINDOWS IN MEMORY CARE UNIT TO HAVE OPENING RESTRICTORS

FIBERGLASS FRENCH STYLE PATIO DOORS.

TO PREVENT OPENING BEYOND 4°.

WALL CLADDING EXTERIOR WALLS ARE TO BE A COMBINATION OF FIBER CEMENT PANELS (SMOOTH OR BRICK-LOOK) AND FIBER CEMENT LAP-SIDING BOARD AND/OR BOARD AND BATTEN, NICHIHA OR

APPROVED SIMILAR. TRIM AND SOFFIT MATERIALS ARE TO BE A PAINTED FIBER CEMENT BOARD (NICHIHA OR APPROVED SIMILAR). PER CURRENT ENERGY CODE REQUIREMENTS, EXTERIOR WALLS AT THE AL/IL ARE TO BE INSULATED WITH R-13 BATT INSULATION AND CONTINUOUS R-7.5 RIGID INSULATION AND WALLS AT THE MC ARE TO HAVE R-21(5.25'HIGH-DENSITY) BATT INSULATION.

ROOFING

ROOFING AT MEMORY CARE SLOPES AND GABLES IS TO BE A 20-YEAR FIBERGLASS SHINGLE: FLAT ROOF AREAS TO BE A SINGLE-PLY MEMBRANE, GABLED ROOFS WILL BE DRAINED TO GUTTERS AND DOWNSPOUTS, FLAT ROOF AREAS WILL NEED RAINWATER LEADERS RUN THROUGH THE BUILDING. SLOPED ROOFS WILL BE INSULATED WITH VENTED, INSULATED PANELS ABOVE TRUSSES AND FLAT ROOFS TO HAVE TAPERED RIGID INSULATION BOARDS ON DECKING, CONTINUOUS R-20 AT ALL LOCATIONS.

PORCH CONCRETE FLOOR SLABS ARE TO BE FINISHED WITH A CHEMICAL STAIN PROCESS.

THE FINAL SITE PLAN/ BUILDING PERMIT SITE PLAN SHALL DEPICT THE REQUIRED PUBLIC SIDEWALKS, ANY REQUIRED GRASS STRIP OR FRONTAGE ZONE AND THE LOCATION OF ALL EXISTING AND PROPOSED VERTICAL OBSTRUCTIONS WITHIN THE REQUIRED SIDEWALK AND GRASS STRIP OR FRONTAGE ZONE. PRIOR TO THE ISSUANCE OF USE AND OCCUPANCY PERMITS, EXISTING VERTICAL OBSTRUCTIONS SHALL BE RELOCATED OUTSIDE OF THE REQUIRED SIDEWALK, VERTICAL OBSTRUCTIONS ARE ONLY PERMITTED WITHIN THE REQUIRED GRASS STRIP OR FRONTAGE ZONE.

THE SPECIFIC PLAN PROCESS IS A MULTI-STEP PROCESS. IF THE PRELIMINARY SP IS APPROVED, THERE ARE ADDITIONAL STEPS REQUIRED PRIOR TO ISSUANCE OF A BUILDING PERMIT. THESE STEPS INCLUDE: FINAL SITE PLAN AND BUILDING PERMIT REVIEW. THE FINAL SITE PLAN IS SUBMITTED THROUGH THE NORMAL PLANNING COMMISSION REVIEW PROCESS. FOR BUILDING PERMIT REVIEW, WHEN APPLYING FOR A BUILDING PERMIT YOU MUST SUBMIT 3 COPIES OF PLANS AND A REVIEW FEE OF \$250 DIRECTLY TO THE PLANNING FRONT COUNTER FOR PROCESSING. WE DO NOT NEED THE COMPLETE BUILDING PERMIT SET. PLEASE SUBMIT ONLY SITE PLAN, LANDSCAPING PLAN, GRADING PLAN, AND BUILDING ELEVATIONS.

TRADITIONS

6922 NOLENSVILLE PIKE

NASHVILLE, TN

CASE NO. 2017SP-070-001

DATE

19 JUL 2017

BATSON & ASSOCIATES

Civil Engineering Consultants

5150 REMINGTON DRIVE

BRENTWOOD, TENNESSEE 37027 (615) 424-4840 • FAX (615) 370-9363

PRELIMINARY PARKING SUMMARY SP PLAN

86 REGULAR PARKING SPACES 4 HANDICAP PARKING SPACES

90 TOTAL PARKING SPACES 74 REQUIRED PARKING SPACES

PER BED FOR 58 INDEPENDENT AND PER 3 BEDS FOR 48 ASSISTED LIVING = 74 PARKING SPACES

MAP: 181 PARCEL: 85 & 180

DESCRIPTION

COMMENT

LEGEND

RECULAR DUTY PAVEMENT

HEAVY DUTY PAVEMENT

CONCRETE SIDEWALK/PAVEMENT

INDICATES NUMBER OF PARKING SPACES IN ROW

 $\begin{pmatrix} 2 \\ C-4 \end{pmatrix}$ DETAIL "2" ON SHEET "C4"

SSWL 4" SINGLE SOUD WHITE LINE

SCALE : $1^* = 30'$

PROJECT NO. 28 JUN 2017 DATE DRAWN BY CHECKED BY

> SITE LAYOUT **PLAN**

SHEET 2 OF 15