


SP PLAN AMENDMENT HAMMER MILL MULTIFAMILY CASE NO. 2016SP-005-003

Adams Street
Nashville, Davidson County, Tennessee

OCTOBER 18, 2017

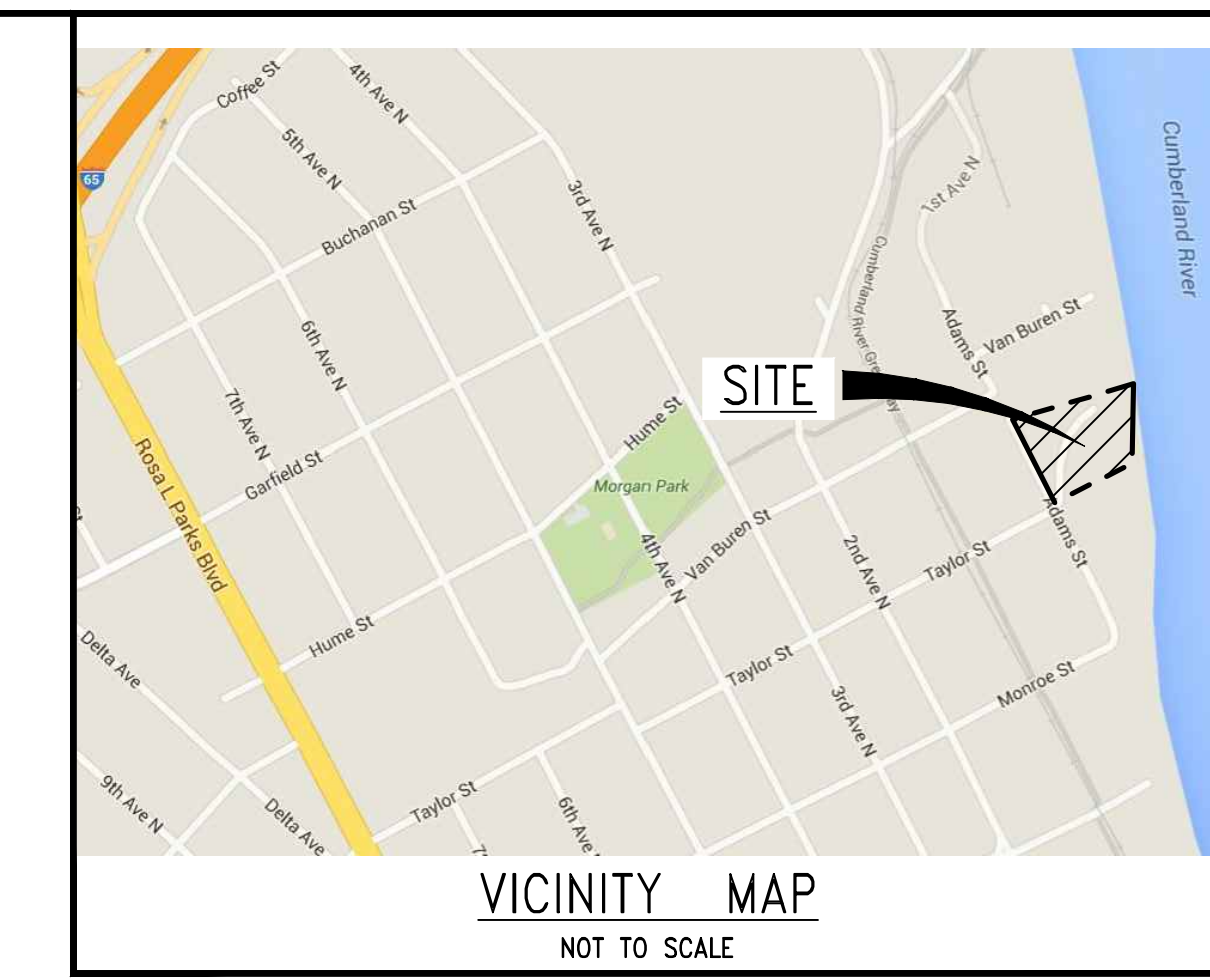

SITE DATA

PROJECT NAME: HAMMER MILL MULTIFAMILY
MAP/PARCEL: 82-05 / 158

USE: RESIDENTIAL RESTAURANT, OFFICE
EXISTING ZONING: SP (SPECIFIC PLAN)
ZONING OVERLAY: OVI-120 (URBAN ZONING OVERLAY)
PROPOSED ZONING: OVI-FD (FLOOD OVERLAY)
SP (SPECIFIC PLAN)

SITE CRITERIA:
LOT 1 SIZE: 151,129 S.F.
LOT 2 SIZE: 16,811 S.F.
FAR (LOT 1): 1.48 (223,830/151,129)
FAR (LOT 2): 1.26 (21,134/16,811)
SR: 748 (123,475/167,840)
PER MAJOR COLLECTOR STREET PLAN

LOT 1 BUILDING HEIGHT: 7 STORY
LOT 2 BUILDING HEIGHT: 2 STORY
PARKING GARAGE BUILDING HEIGHT: 7 STORY
REQUIRED BUFFER YARDS: 75' FLOOD
OPAQUE FENCE ADJACENT TO RESIDENTIAL IN PARKING AREA: N/A
BUFFER YARD ADJUSTMENT: N/A
SCREENING AROUND DUMPSTERS: PROVIDED

SITE DATA:
COUNCIL DISTRICT: 19
COUNCIL MEMBER: FREDDIE O'CONNELL
TOTAL SITE ACRES: 3.99 AC. (173,912 SQ. FT.)
R.O.W. TO BE DEDICATED: 0.13 AC. (5,672 SQ. FT.)
LOT 1: 3.47 AC. (151,129 SQ. FT.)
LOT 2: 0.39 AC. (16,811 SQ. FT.)

BUILDING DATA:
LOT 1
MULTI-FAMILY: 151 - 1 BEDROOM
53 - 2 BEDROOM
53 - STUDIO
255 / 229,530 GROSS S.F.
RESTAURANT: 4,000 S.F.

LOT 2: RESTAURANT (1st FLOOR HAMMER MILL): 13,465 S.F.
OFFICE (2nd FLOOR): 6,503 S.F.

DEVELOPER: TRIBRIDGE RESIDENTIAL
1575 NORTHSIDE DRIVE
BUILDING 100, SUITE 200
ATLANTA, GA 30318
404.352.2800
WILLIAM NORRIS
wnorris@tribridges.com

APPLICANT: LITTLEJOHN
1935 21st AVE. SOUTH
NASHVILLE, TN 37212
615.385.4144
MR. ANDREW WOLTERS
awolters@leinc.com

MINIMUM PARKING REQUIREMENTS:

MULTI-FAMILY (1 SP/BEDROOM + 1.5 SP/2 OR MORE BR.)	281 SPACES
RESTAURANT (204 + 77 (1.505) = 281)	20 SPACES
OFFICE (1 SP/500 S.F. ABOVE 1,000 S.F.)	9 SPACES
OFFICE (1 SP/500 S.F. ABOVE 2,000 S.F.)	9 SPACES
OFFICE (4,503 S.F./500 S.F. = 9)	394 SPACES
REQUIRED PARKING	-39 SPACES
PARKING REDUCTIONS (PEDESTRIAN ACCESS -10% (590x10))	355 SPACES
TOTAL REQUIRED PARKING	50 SPACES
BICYCLE (1/4 UNITS (25K) / MAX. 50 (25K UNITS / 4 = 64, MAX. 50))	

GARAGE PARKING PROVIDED:

BASEMENT/TRASH	55 SPACES
LEVEL 1	55 SPACES
LEVEL 2	63 SPACES
LEVEL 3	63 SPACES
LEVEL 4	64 SPACES
LEVEL 5	44 SPACES
TOTAL GARAGE PARKING PROVIDED	348 SPACES
ACCESSIBLE SPACES	8 SPACES TOTAL (2 VAN)

SITE PARKING PROVIDED:

ON-SITE PARALLEL PARKING	2 SPACES
ON-STREET PARKING PROVIDED	
ON-STREET PARALLEL PARKING	20 SPACES
TOTAL ON STREET PARKING (50X COUNTED)	10 SPACES
TOTAL PARKING PROVIDED	358 SPACES

BICYCLE PARKING PROVIDED:

IN GARAGE SPACES	40 SPACES
PUBLIC ON SITE	10 SPACES
TOTAL BICYCLE PARKING PROVIDED	50 SPACES

PROPOSED LAND USE TABLE (QUALIFYING USES)

MULTI-FAMILY RESIDENTIAL


COMMERCIAL USES:
HOTEL
RESTAURANT
BAR OR NIGHTCLUB
RETAIL
BUSINESS SERVICE
PERSONAL CARE SERVICE

OFFICE USES:
GENERAL OFFICE
LEASING AND SALES OFFICE

NOTE: ANY ADDITIONAL USES QUALIFYING UNDER THE MUI ZONING DESIGNATION

DEVELOPMENT SUMMARY & NOTES

- THE PURPOSE OF THIS SPECIFIC PLAN IS TO AMEND THE CURRENT SPECIFIC PLAN ZONING FOR THIS DEVELOPMENT TO ALLOW FOR AN ADDITIONAL 4,000 SQUARE FEET OF COMMERCIAL USE.
- AS THE PROPERTY EXTENDS TO THE LOW WATER MARK OF THE CUMBERLAND RIVER, A PORTION OF THE PARCEL DOES LIE WITHIN THE 100 YEAR FLOODPLAIN AND IS DETERMINED TO BE IN ZONE "A". HOWEVER, THE DEVELOPABLE PORTION OF THE SITE THAT LIES WEST OF THE RIVER BLUFF DOES NOT LIE WITHIN THE 100 YEAR FLOOD PLAN AND IS DETERMINED TO BE IN ZONE "X" PER THE FEDERAL EMERGENCY MANAGEMENT FIRM PANEL NUMBER 47037020241H, APRIL 5, 2017, PANEL 241 OF 478. THE 100-YR FLOOD ELEVATION IS 415.6' (NOOD-25).
- ANY EXCAVATION, FILL OR DISTURBANCE OF THE EXISTING GROUND ELEVATION MUST BE DONE IN ACCORDANCE WITH STORM WATER MANAGEMENT ORDINANCE NO. 78/ 840 AND APPROVED BY THE METROPOLITAN DEPARTMENT OF WATER SERVICES.
- METRO WATER SERVICES SHALL BE PROVIDED SUFFICIENT AND UNHINDERED ACCESS IN ORDER TO MAINTAIN AND REPAIR UTILITIES IN THIS SITE.
- ALL DEVELOPMENT WITHIN THE BOUNDARIES OF THIS PLAN WILL MEET THE AMERICANS WITH DISABILITIES ACT AND THE FAIR HOUSING ACT.
- EPS, VINYL SIDING AND UNTREATED WOOD SHALL BE PROHIBITED.
- A RAISED FOUNDATION OF 18"-24" IS REQUIRED FOR ALL RESIDENTIAL STRUCTURES.
- FINAL DETAILS OF THE PLAN SHALL BE GOVERNED BY THE REGULATIONS AT THE TIME OF FINAL APPLICATION.
- APPROVAL OF ANY SPECIFIC PLAN DOES NOT DEEMPT ANY PARCEL SHOWN ON THE PLAN OR ANY DEVELOPMENT WITHIN THE SP FROM COMPLIANCE WITH ALL PROVISIONS OF THE METRO ZONING CODE WITH RESPECT TO FLOODPLAIN, STEEP SLOPES, UNSTABLE SOILS, SINKHOLES, ROCK OUTCROPPINGS, STREAMS, SPRINGS AND CRITICAL LOTS.
- IT IS ANTICIPATED THAT THE PROJECT WILL BEGIN CONSTRUCTION IN NOVEMBER OF 2016 AND WILL TAKE APPROXIMATELY 24 MONTHS TO BE COMPLETED.
- THE FINAL SITE PLAN/ BUILDING PERMIT SITE PLAN SHALL DEPICT THE REQUIRED PUBLIC SIDEWALKS, ANY REQUIRED GRASS STRIP OR FRONTAGE ZONE, AND THE LOCATION OF ALL EXISTING AND PROPOSED VERTICAL OBSTRUCTIONS WITHIN THE REQUIRED SIDEWALK AND GRASS STRIP OR FRONTAGE ZONE. PRIOR TO THE ISSUANCE OF USE AND OCCUPANCY PERMITS, EXISTING VERTICAL OBSTRUCTIONS SHALL BE RELOCATED OUTSIDE OF THE REQUIRED SIDEWALK. VERTICAL OBSTRUCTIONS ARE ONLY PERMITTED WITHIN THE REQUIRED GRASS STRIP OR FRONTAGE ZONE.
- DRAWING IS FOR ILLUSTRATION PURPOSES TO INDICATE THE BASIC PREMISE OF THE DEVELOPMENT, AS IT PERTAINS TO STORM WATER APPROVAL/COMMENTS ONLY. THE FINAL LOT COUNT AND DETAILS OF THE PLAN SHALL BE GOVERNED BY THE APPROPRIATE STORM WATER REGULATIONS AT THE TIME OF FINAL APPLICATION.

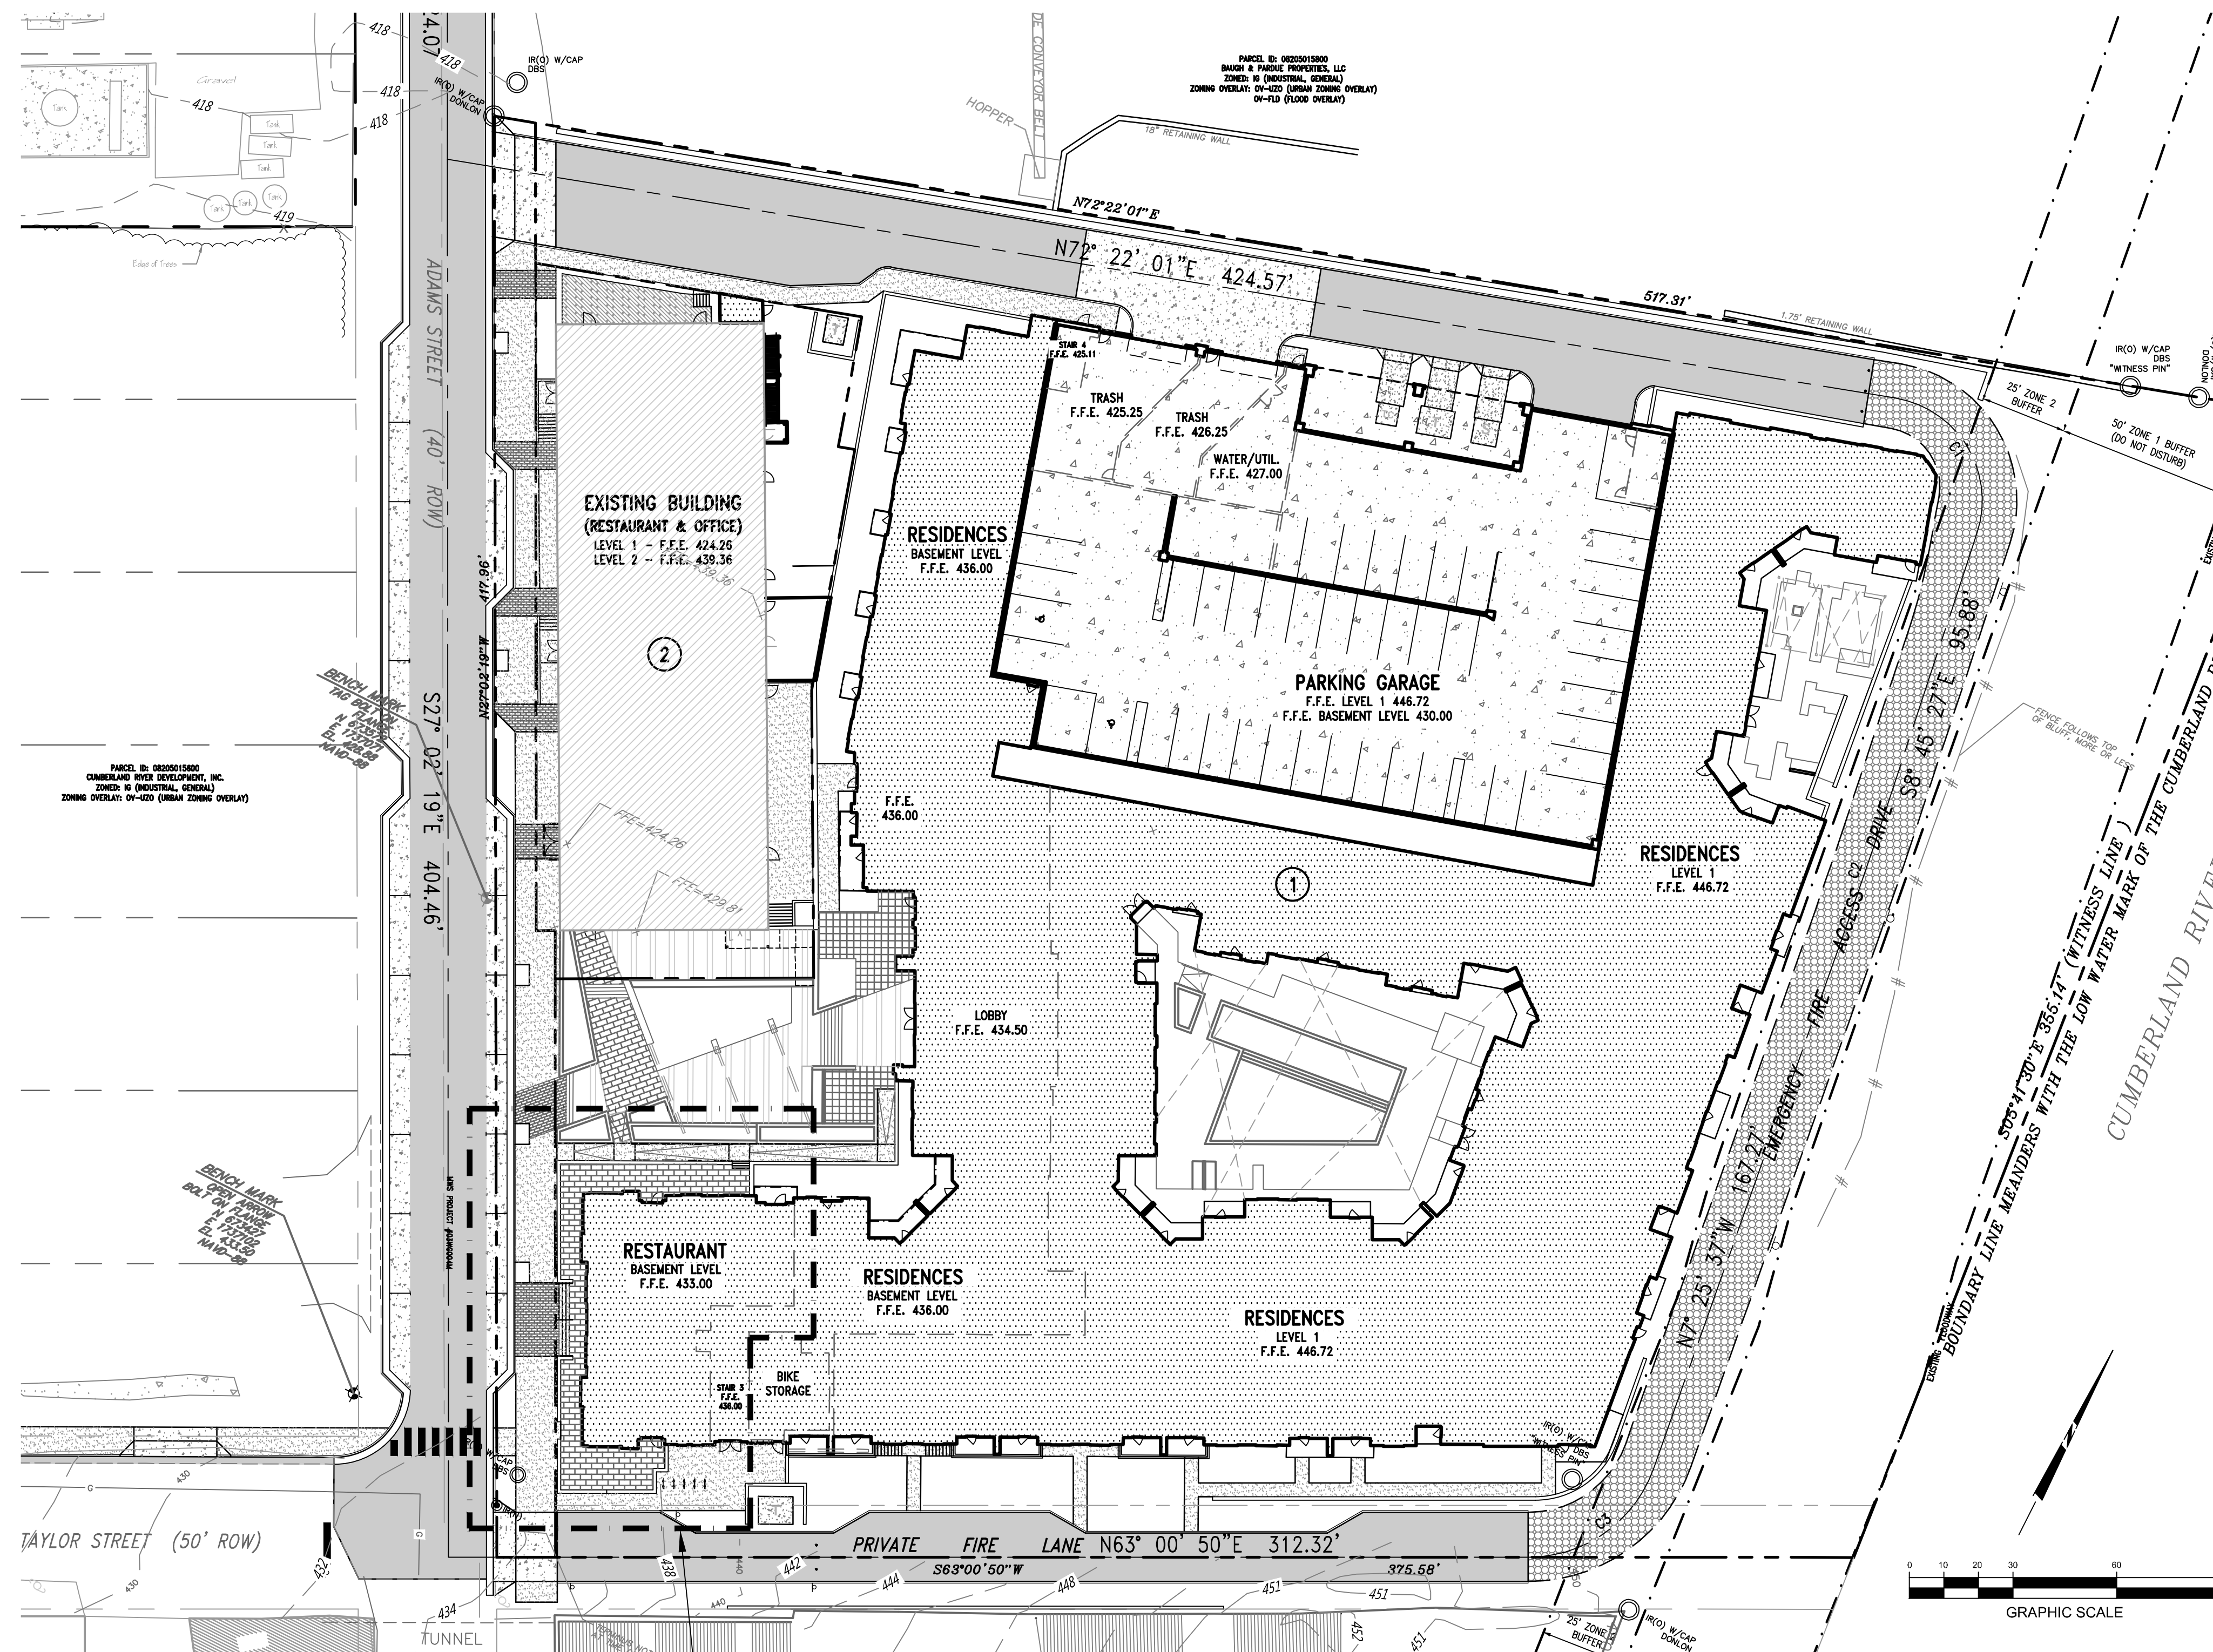

AREA OF SP PLAN AMENDMENT

INDEX OF SHEETS

SHT. NO.	SHEET TITLE
C0.0	COVER SHEET
C1.0	EXISTING CONDITIONS
C3.0	EPSC PLAN - INITIAL
C3.1	EPSC PLAN - INTERIM
C3.2	EPSC PLAN - FINAL
C3.3	EPSC DETAILS
C4.0	SITE DEMOLITION
C5.0	SITE LAYOUT
C5.1	OFF-SITE LAYOUT
C6.0	SITE GRADING & DRAINAGE
C6.1	OFF-SITE GRADING & DRAINAGE
C7.0	SITE UTILITIES
C7.1	PUBLIC SANITARY SEWER
C7.2	PUBLIC WATER PLAN
C8.0	SITE DETAILS
C8.1	SITE DETAILS
C8.2	SITE DETAILS
C8.3	SITE DETAILS
C8.4	SITE DETAILS
L7.00	REQUIRED PLANTING PLAN
SP4-01	EXTERIOR ELEVATIONS
SP4-02	EXTERIOR ELEVATIONS


ARCHITECT:
dwell design studio
3655 BROOKSIDE PKWY., SUITE 150
ALPHARETTA, GA 30022
770.864.1035

PREPARED FOR:
Gateway TBR Hammer Mill, GP
1575 NORTHSIDE DRIVE
BUILDING 100, SUITE 200
ATLANTA, GA 30318
404.352.2800

CIVIL ENGINEER:
Littlejohn
An S&ME Company
1935 21st Avenue South, NASHVILLE, TENNESSEE 37212
T 615.385.4144 F 615.385.4020 www.leinc.com




C0.0

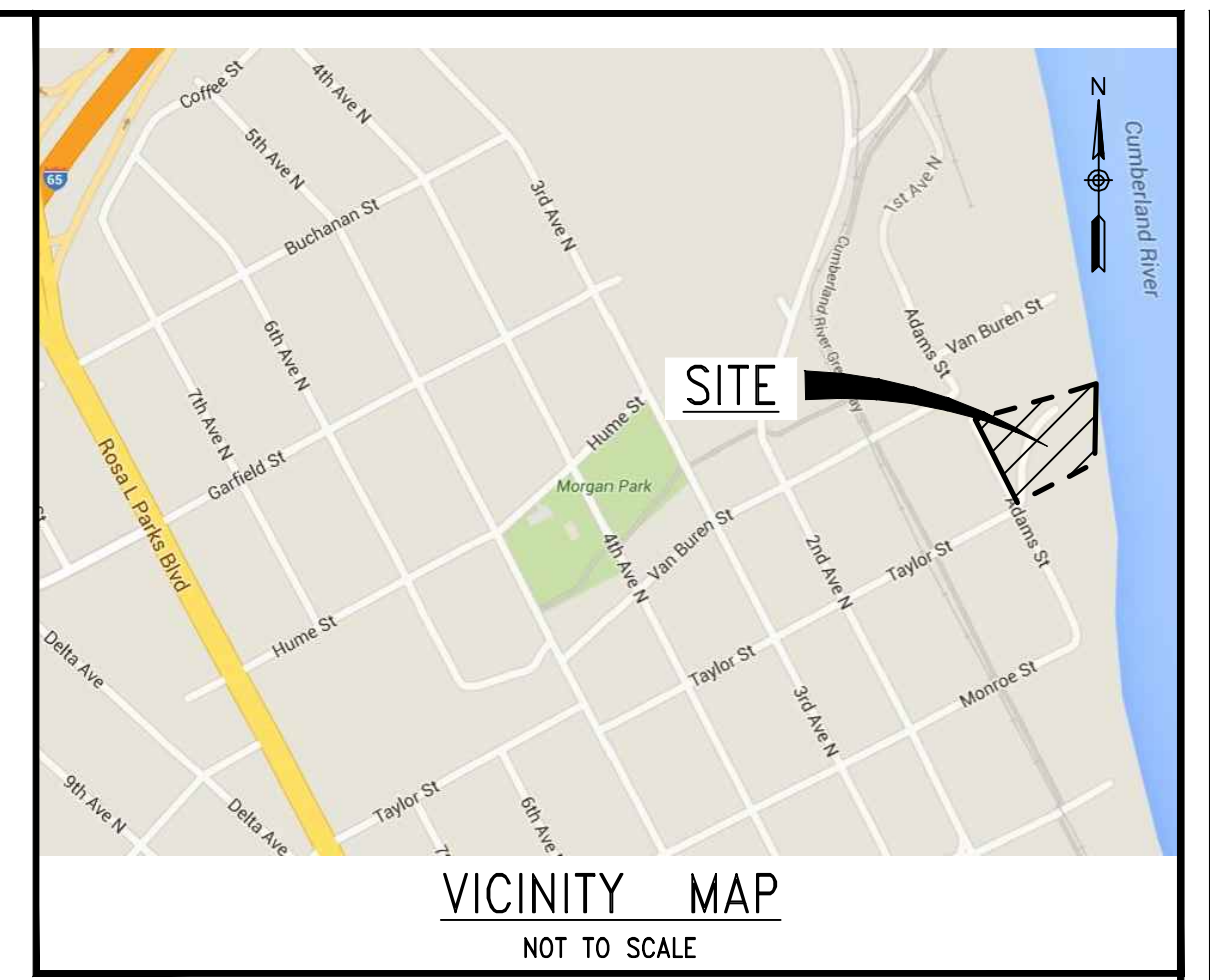

Case No: 2016SP-005-003
SP PLAN AMENDMENT
HAMMER MILL MULTIFAMILY
NASHVILLE, DAVIDSON COUNTY, TENNESSEE

Gateway TBR
Hammer Mill, GP
1575 NORTHSIDE DRIVE
BUILDING 100, SUITE 200
ATLANTA, GA 30318

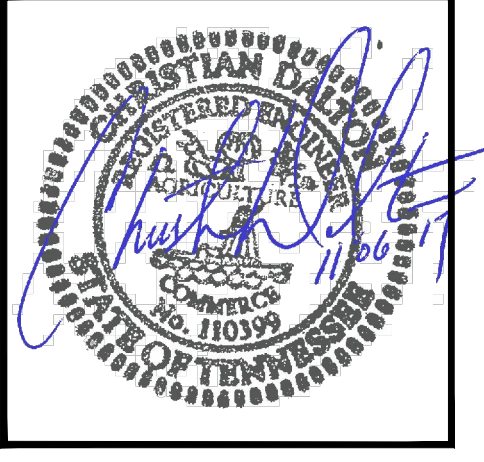

EXISTING FEATURES LEGEND


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EDGE OF PAVEMENT	---
BUILDING	[Hatched Box]
CONCRETE PAVEMENT	[Dotted Box]
RETAINING WALL	[Double Line]
EXISTING CONTOUR	---
SANITARY MANHOLE	⊙
FIRE HYDRANT	⊕
LIGHT/POWER POLE	⊕
SANITARY SEWER	SAN
WATER LINE	W
GAS LINE	G
OVERHEAD POWER	---OP---
BENCHMARK	⊕

DATE	REVISIONS
2017.09.28	20150950


C1.0
EXISTING CONDITIONS

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NOTE
ALL SOILS ON SITE ARE TYPE Ln
(LINDELL-URBAN LAND COMPLEX)

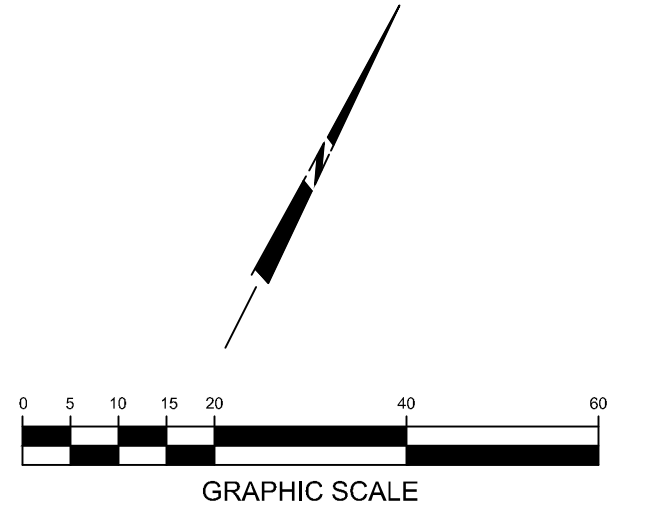

(MAP 82.09 PAR 250)
PT LOT 99
HUGH W. MCGAVOCK'S
ADDITION TO NORTH NASHVILLE
P.B. 17, PG. 640
CUMBERLAND RIVER DEVELOPMENT, INC.
I.N. 200904080032243

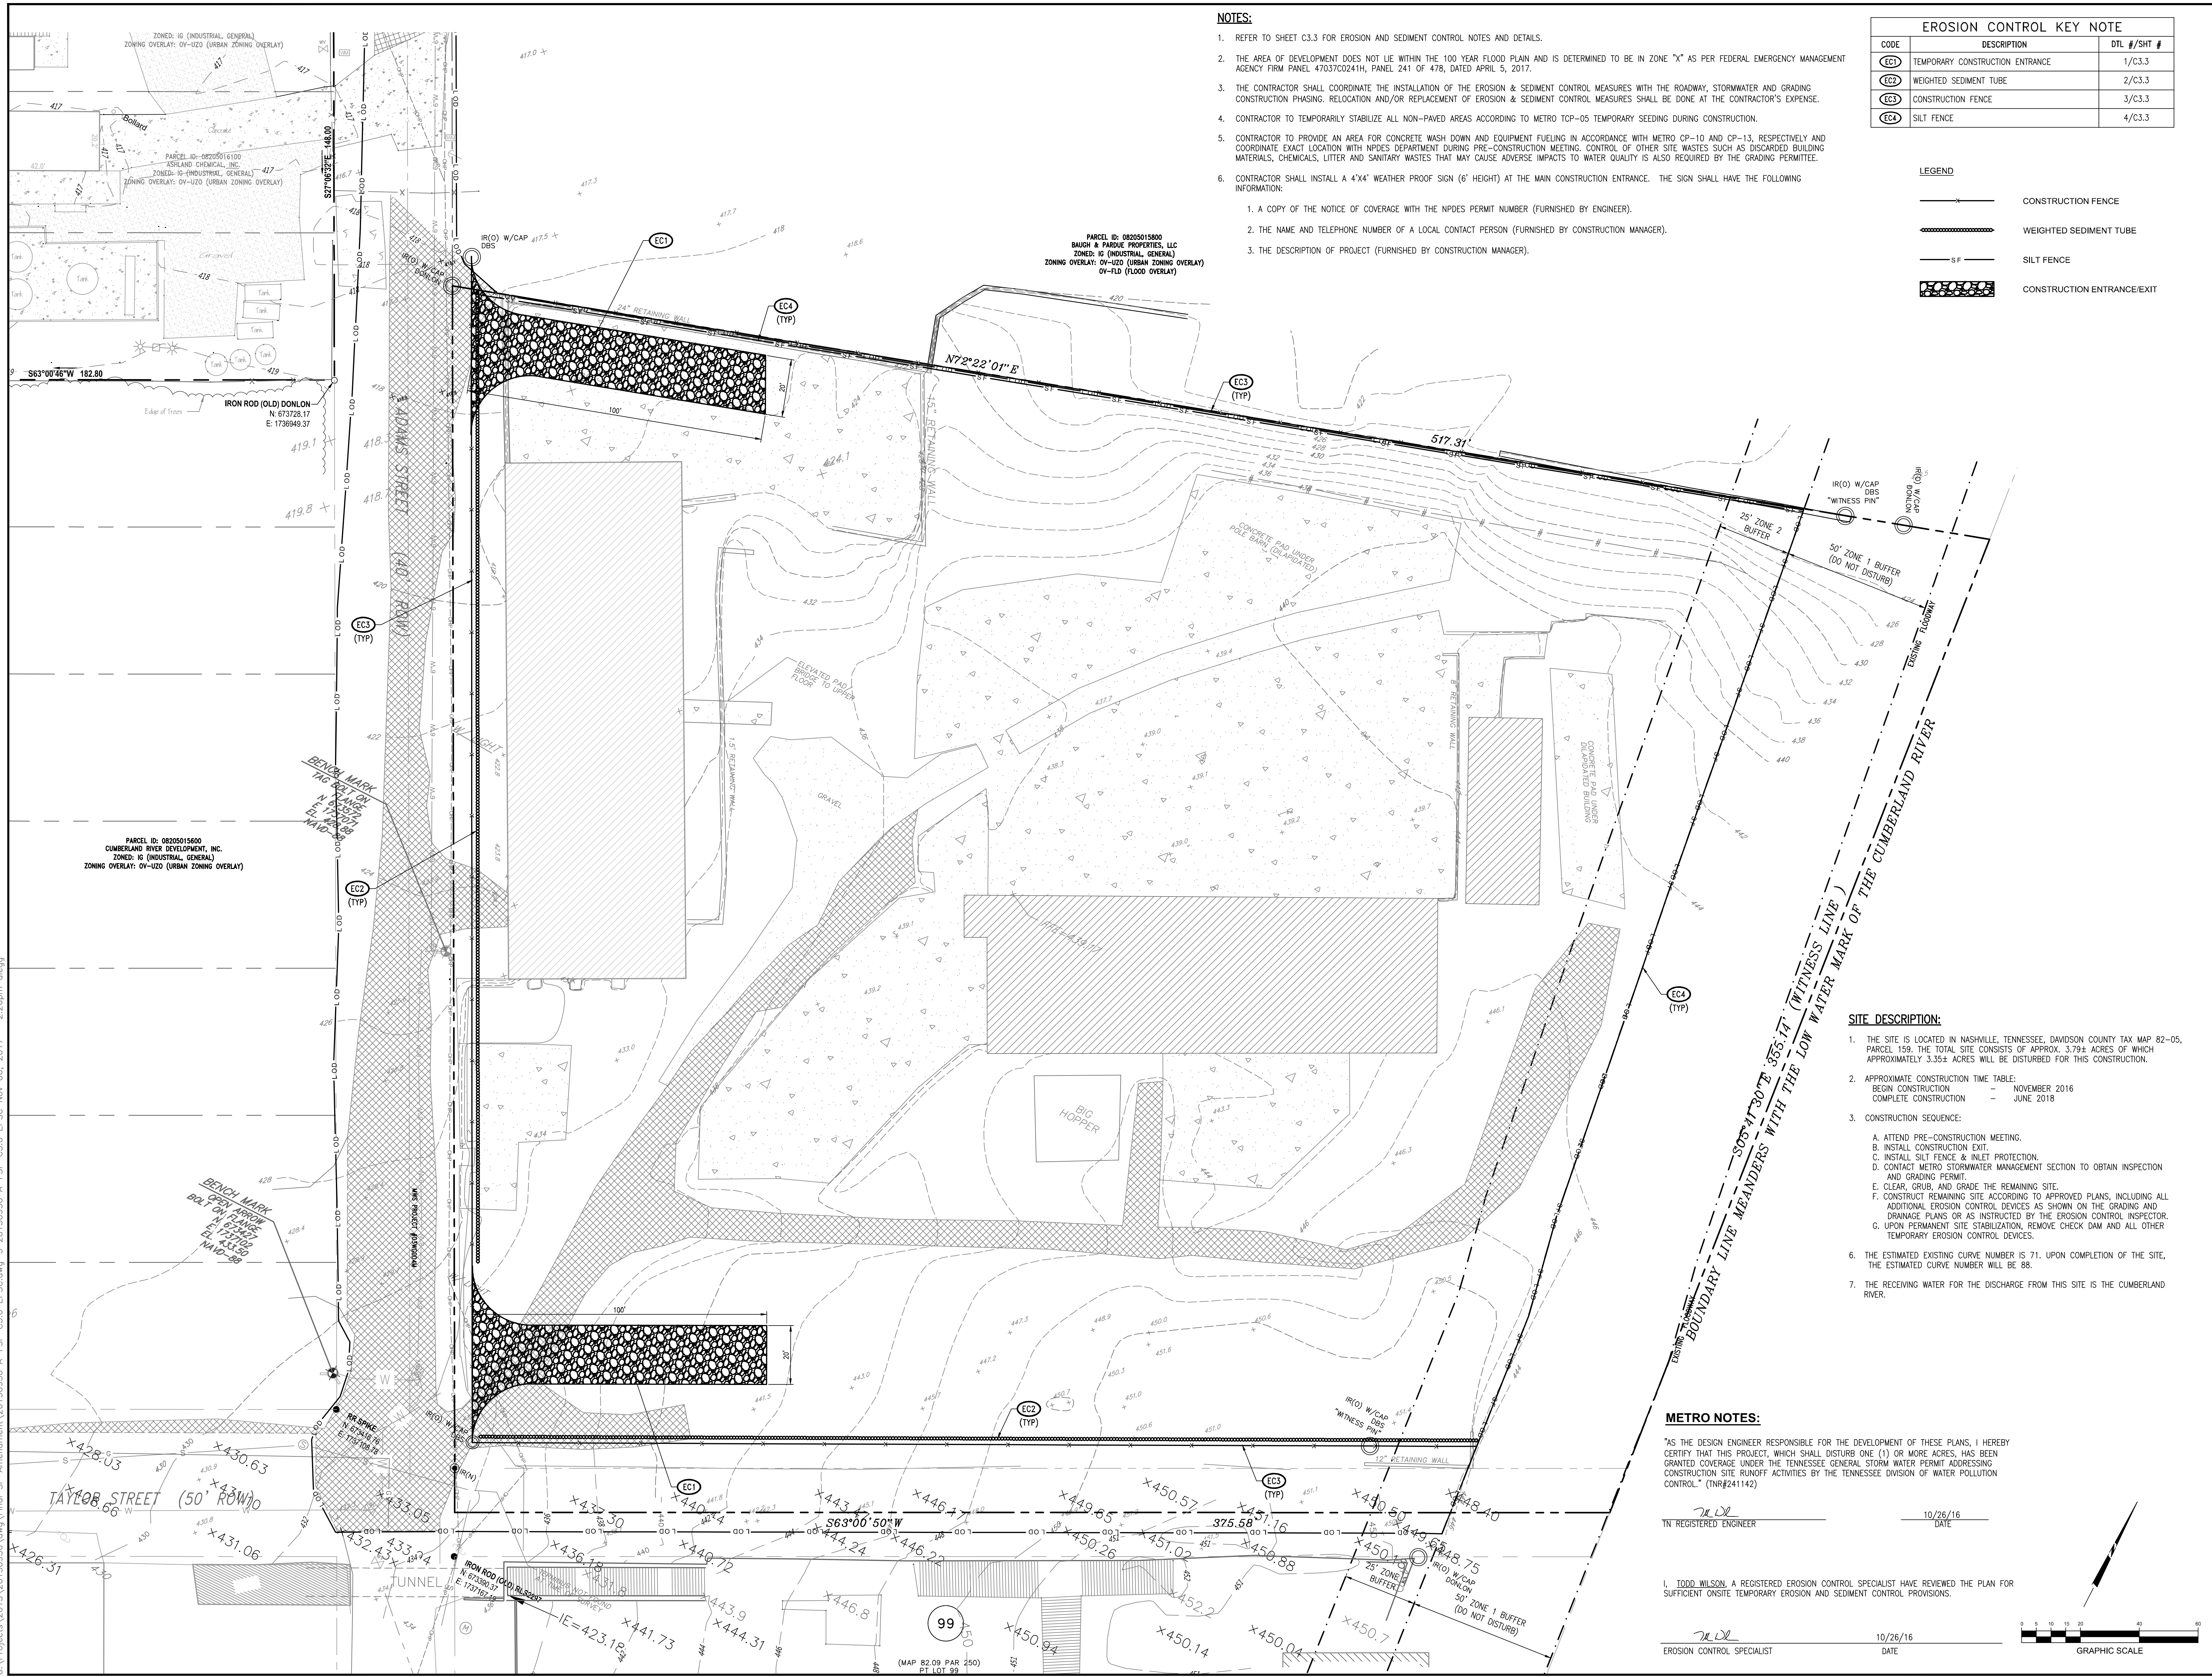

NOTES:

- REFER TO SHEET C3.3 FOR EROSION AND SEDIMENT CONTROL NOTES AND DETAILS.
- THE AREA OF DEVELOPMENT DOES NOT LIE WITHIN THE 100 YEAR FLOOD PLAIN AND IS DETERMINED TO BE IN ZONE "X" AS PER FEDERAL EMERGENCY MANAGEMENT AGENCY FIRM PANEL 47037C0241H, PANEL 241 OF 478, DATED APRIL 5, 2017.
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- CONTRACTOR TO TEMPORARILY STABILIZE ALL NON-PAVED AREAS ACCORDING TO METRO TCP-05 TEMPORARY SEEDING DURING CONSTRUCTION.
- CONTRACTOR TO PROVIDE AN AREA FOR CONCRETE WASH DOWN AND EQUIPMENT FUELING IN ACCORDANCE WITH METRO CP-10 AND CP-13, RESPECTIVELY AND COORDINATE EXACT LOCATION WITH NPDES DEPARTMENT DURING PRE-CONSTRUCTION MEETING. CONTROL OF OTHER SITE WASTES SUCH AS DISCARDED BUILDING MATERIALS, CHEMICALS, LITTER AND SANITARY WASTES THAT MAY CAUSE ADVERSE IMPACTS TO WATER QUALITY IS ALSO REQUIRED BY THE GRADING PERMITTEE.
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EROSION CONTROL KEY NOTE		
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EC1	TEMPORARY CONSTRUCTION ENTRANCE	1/C3.3
EC2	WEIGHTED SEDIMENT TUBE	2/C3.3
EC3	CONSTRUCTION FENCE	3/C3.3
EC4	SILT FENCE	4/C3.3

LEGEND

- CONSTRUCTION FENCE
- WEIGHTED SEDIMENT TUBE
- SILTY FENCE
- CONSTRUCTION ENTRANCE/EXIT

SITE DESCRIPTION:


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 C. INSTALL SILT FENCE & INLET PROTECTION.
 D. CONTACT METRO STORMWATER MANAGEMENT SECTION TO OBTAIN INSPECTION AND GRADING PERMIT.
 E. CLEAR, GRUB, AND GRADE THE REMAINING SITE.
 F. CONSTRUCT REMAINING SITE ACCORDING TO APPROVED PLANS, INCLUDING ALL ADDITIONAL EROSION CONTROL DEVICES AS SHOWN ON THE GRADING AND DRAINAGE PLANS OR AS INSTRUCTED BY THE EROSION CONTROL INSPECTOR.
 G. UPON PERMANENT SITE STABILIZATION, REMOVE CHECK DAM AND ALL OTHER TEMPORARY EROSION CONTROL DEVICES.
- THE ESTIMATED EXISTING CURVE NUMBER IS 71. UPON COMPLETION OF THE SITE, THE ESTIMATED CURVE NUMBER WILL BE 88.
- THE RECEIVING WATER FOR THE DISCHARGE FROM THIS SITE IS THE CUMBERLAND RIVER.

METRO NOTES:

"AS THE DESIGN ENGINEER RESPONSIBLE FOR THE DEVELOPMENT OF THESE PLANS, I HEREBY CERTIFY THAT THIS PROJECT, WHICH SHALL DISTURB ONE (1) OR MORE ACRES, HAS BEEN GRANTED COVERAGE UNDER THE TENNESSEE GENERAL STORM WATER PERMIT ADDRESSING CONSTRUCTION SITE RUNOFF ACTIVITIES BY THE TENNESSEE DIVISION OF WATER POLLUTION CONTROL." (TR#241142)


M. De
 TN REGISTERED ENGINEER 10/26/16
 DATE

M. De
 EROSION CONTROL SPECIALIST 10/26/16
 DATE

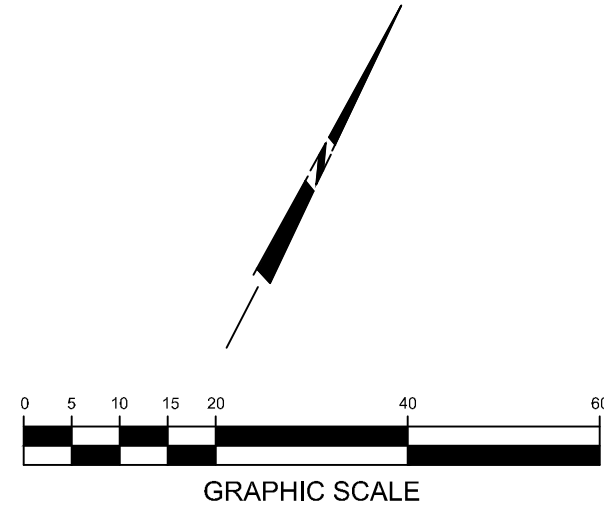

Littlejohn
 An S&ME Company
 1935 21st Avenue South, Nashville, Tennessee 37217
 T 615.385.9144 F 615.385.4020 www.littlejohn.com


Case No: 2016SP-005-003
 SP PLAN AMENDMENT
HAMMER MILL MULTIFAMILY
 NASHVILLE, DAVIDSON COUNTY, TENNESSEE

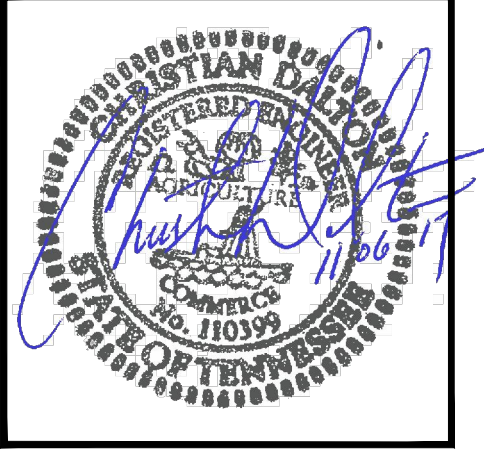

DATE	REVISIONS
2017.09.28	20150950

C3.0
 EPSC PLAN - INITIAL

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NOTES:
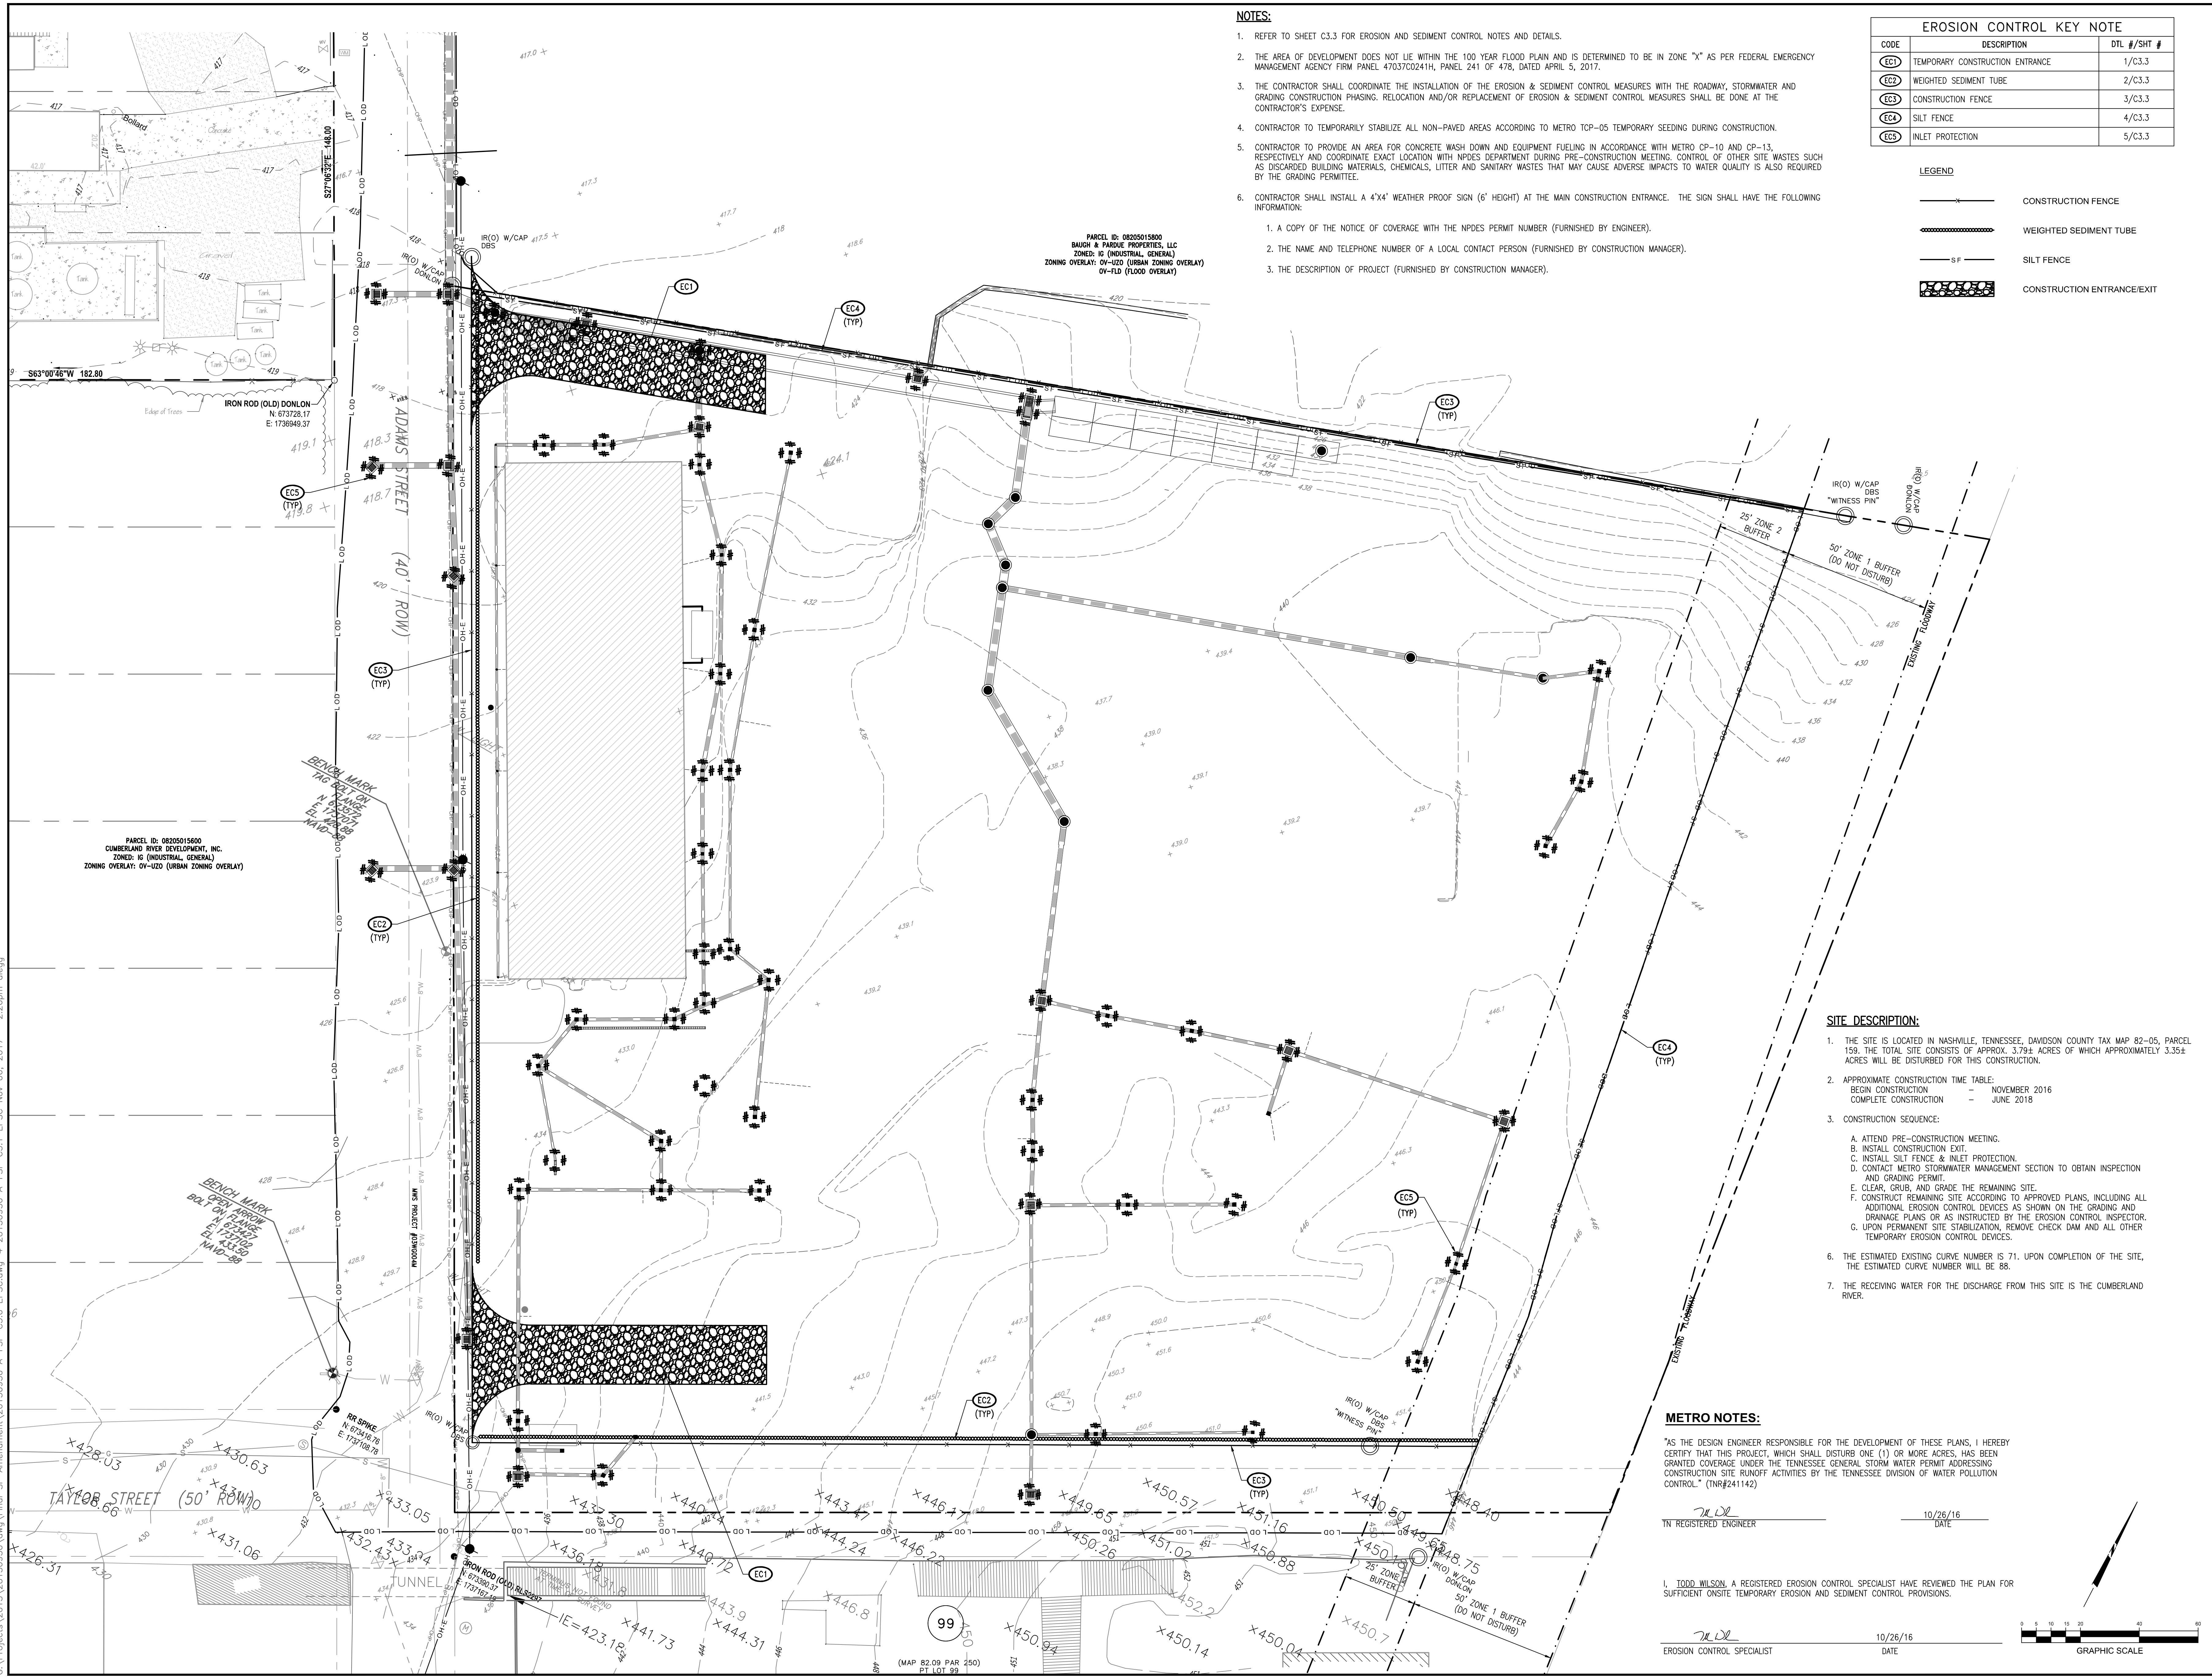
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EC5	INLET PROTECTION	5/C3.3

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- CONSTRUCTION FENCE
- WEIGHTED SEDIMENT TUBE
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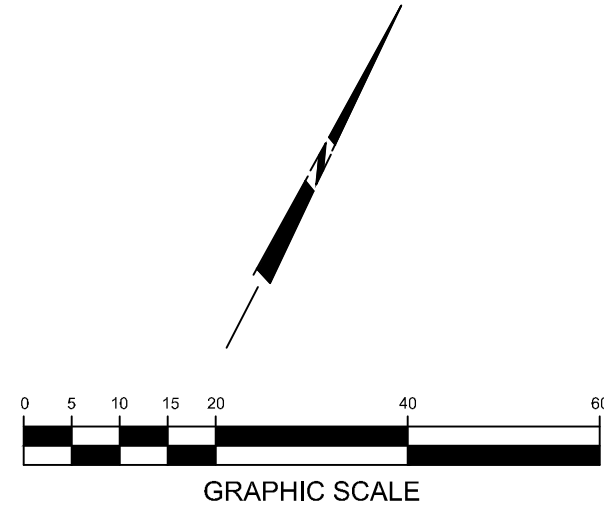
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 TN REGISTERED ENGINEER 10/26/16
 DATE

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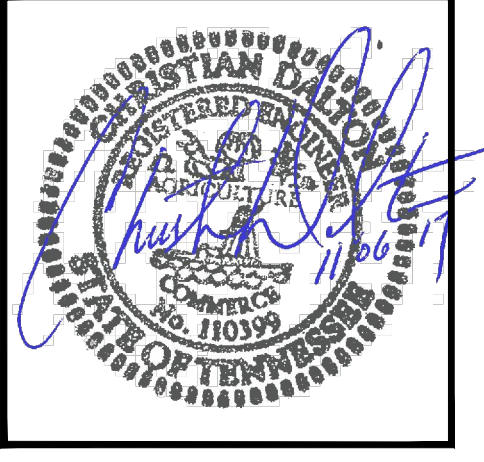


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Case No: 2016SP-005-003
 SP PLAN AMENDMENT
HAMMER MILL MULTIFAMILY
 NASHVILLE, DAVIDSON COUNTY, TENNESSEE


Gateway TBR
 Hammer Mill, GP
 1575 NORTHSIDE DRIVE
 BUILDING 100, SUITE 200
 ATLANTA, GA 30318



DATE	REVISIONS
2017.09.28	20150950

C3.1
 EPSC PLAN - INTERIM


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- NOTES:**
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 - THE DESCRIPTION OF PROJECT (FURNISHED BY CONSTRUCTION MANAGER).
 - REFER TO LANDSCAPE PLANS FOR ADDITIONAL FINAL STABILIZATION AND GROUND COVER DETAILS AND SPECIFICATIONS.

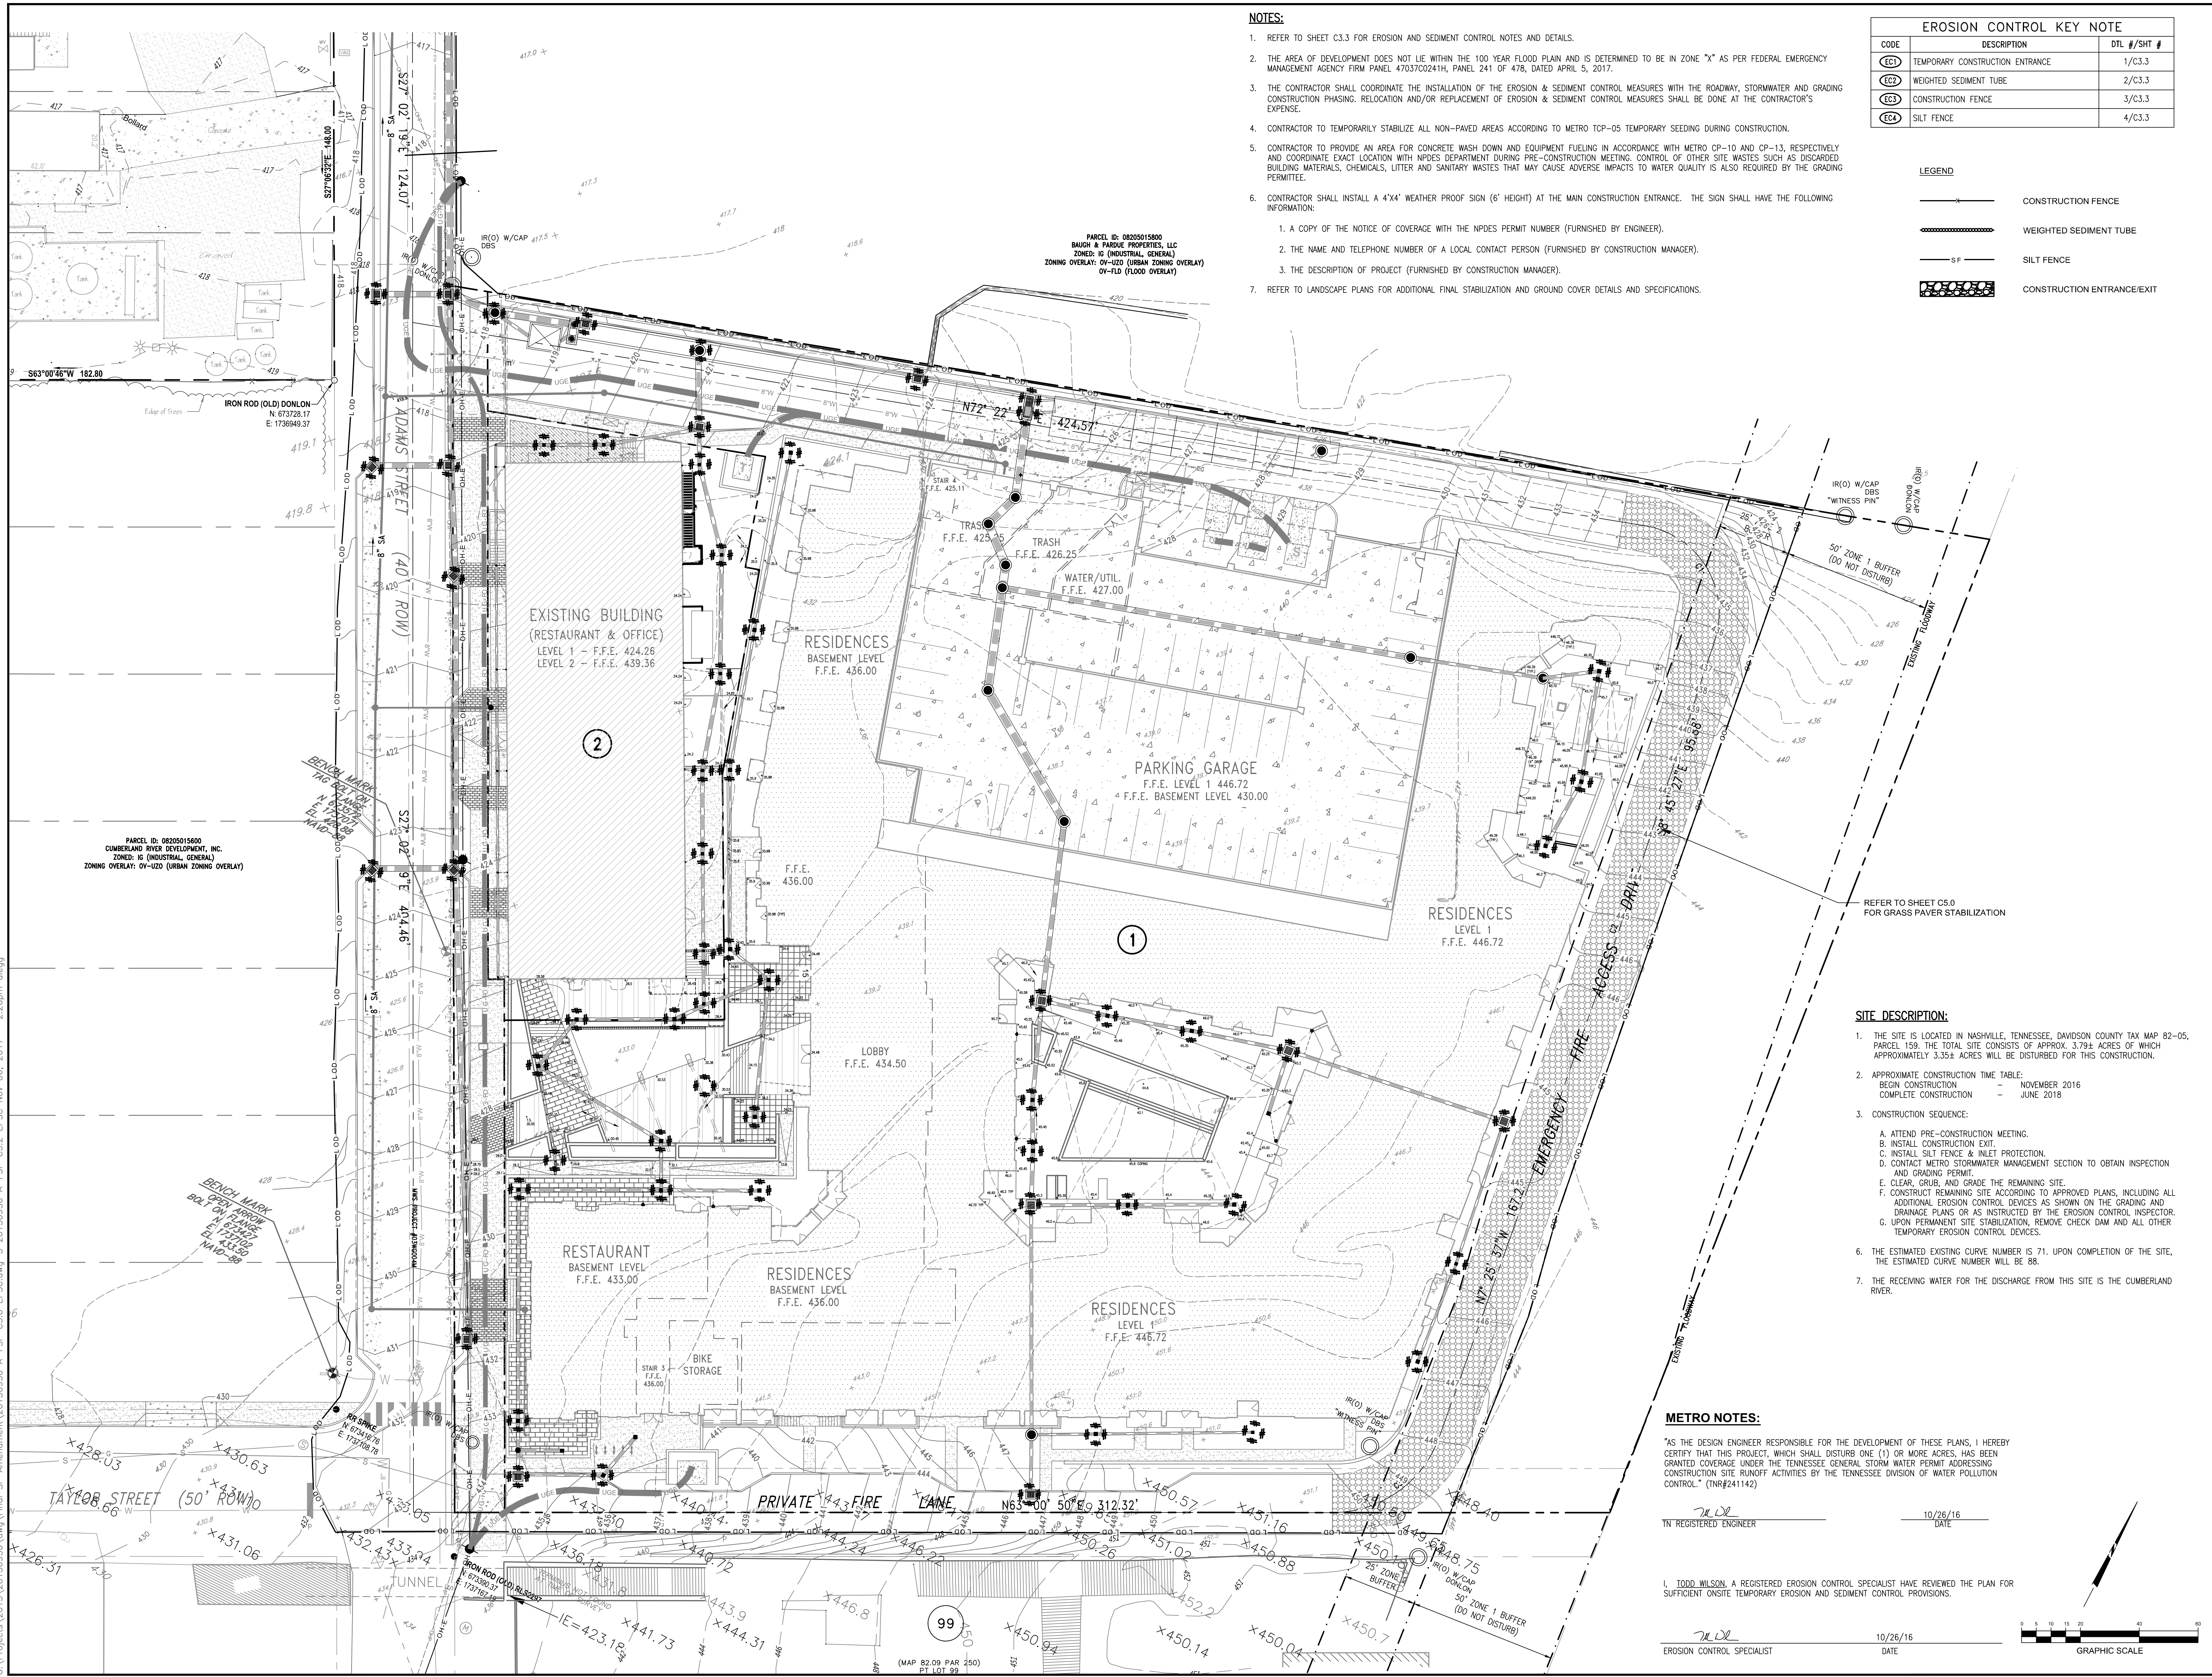EROSION CONTROL KEY NOTE

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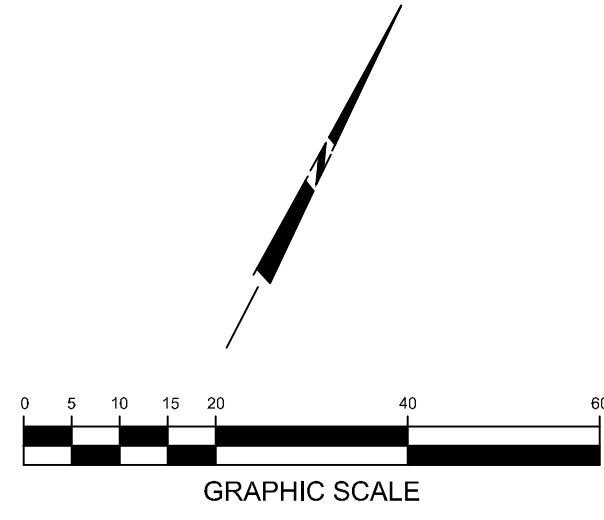
REFER TO SHEET C5.0 FOR GRASS PAVER STABILIZATION

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 - CONSTRUCTION SEQUENCE:
 - ATTEND PRE-CONSTRUCTION MEETING.
 - INSTALL CONSTRUCTION EXIT.
 - INSTALL SILT FENCE & INLET PROTECTION.
 - CONTACT METRO STORMWATER MANAGEMENT SECTION TO OBTAIN INSPECTION AND GRADING PERMIT.
 - CLEAR, GRUB, AND GRADE THE REMAINING SITE.
 - CONSTRUCT REMAINING SITE ACCORDING TO APPROVED PLANS, INCLUDING ALL ADDITIONAL EROSION CONTROL DEVICES AS SHOWN ON THE GRADING AND DRAINAGE PLANS OR AS INSTRUCTED BY THE EROSION CONTROL INSPECTOR.
 - UPON PERMANENT SITE STABILIZATION, REMOVE CHECK DAM AND ALL OTHER TEMPORARY EROSION CONTROL DEVICES.
 - THE ESTIMATED EXISTING CURVE NUMBER IS 71. UPON COMPLETION OF THE SITE, THE ESTIMATED CURVE NUMBER WILL BE 88.
 - THE RECEIVING WATER FOR THE DISCHARGE FROM THIS SITE IS THE CUMBERLAND RIVER.

METRO NOTES:

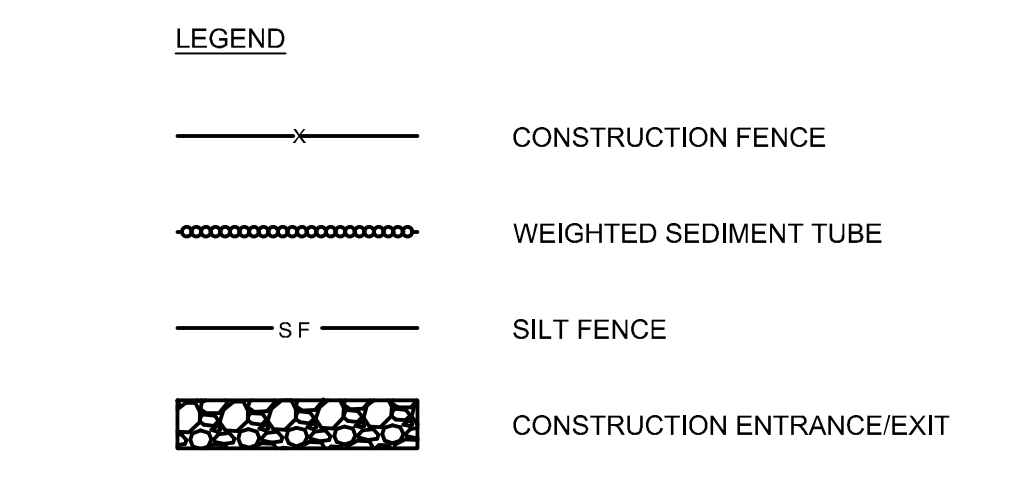
"AS THE DESIGN ENGINEER RESPONSIBLE FOR THE DEVELOPMENT OF THESE PLANS, I HEREBY CERTIFY THAT THIS PROJECT, WHICH SHALL DISTURB ONE (1) OR MORE ACRES, HAS BEEN GRANTED COVERAGE UNDER THE TENNESSEE GENERAL STORM WATER PERMIT ADDRESSING CONSTRUCTION SITE RUNOFF ACTIVITIES BY THE TENNESSEE DIVISION OF WATER POLLUTION CONTROL." (TN#241142)

TN REGISTERED ENGINEER 10/26/16 DATE
 EROSION CONTROL SPECIALIST 10/26/16 DATE



Case No: 2016SP-005-003
 SP PLAN AMENDMENT
HAMMER MILL MULTIFAMILY
 NASHVILLE, DAVIDSON COUNTY, TENNESSEE

Gateway TBR
 Hammer Mill, GP
 1575 NORTHSIDE DRIVE
 BUILDING 100, SUITE 200
 ATLANTA, GA 30318

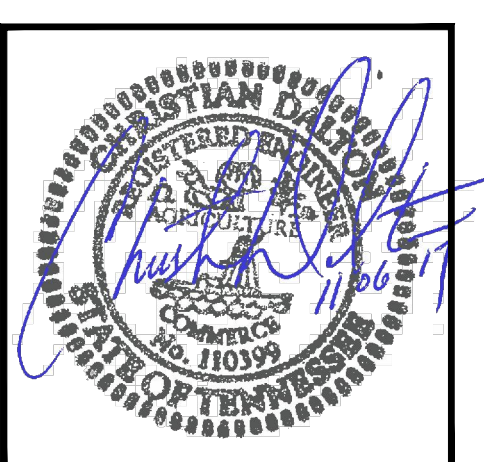

DATE	REVISIONS
2017.09.28	20150950

C3.2
 EPSC PLAN - FINAL

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SCHEDULE OF INSPECTIONS AND MAINTENANCE NOTES

- INSPECTIONS DESCRIBED IN PARAGRAPHS 2, 3 AND 4 BELOW, SHALL BE PERFORMED AT LEAST TWICE EVERY CALENDAR WEEK. INSPECTIONS SHALL BE PERFORMED AT LEAST 72 HOURS APART. WHERE SITES OR PORTIONS OF CONSTRUCTION SITES HAVE BEEN TEMPORARILY STABILIZED, OR RUNOFF IS UNLIKELY DUE TO WINTER CONDITIONS (E.G., SITE COVERED WITH SNOW OR ICE) OR DUE TO EXTREME DROUGHT, SUCH INSPECTION ONLY HAS TO BE CONDUCTED ONCE PER MONTH UNLESS THAWING OR PRECIPITATION RESULTS IN RUNOFF OR CONSTRUCTION ACTIVITY RESUMES. INSPECTION REQUIREMENTS DO NOT APPLY TO DEFINABLE AREAS THAT HAVE BEEN FINALLY STABILIZED. WRITTEN NOTIFICATION OF THE INTENT TO CHANGE THE INSPECTION FREQUENCY AND THE JUSTIFICATION FOR SUCH REQUEST MUST BE SUBMITTED TO THE LOCAL ENVIRONMENTAL FIELD OFFICE, OR THE DIVISION'S NASHVILLE CENTRAL OFFICE FOR PROJECTS OF THE TENNESSEE DEPARTMENT OF TRANSPORTATION (TDOT) AND THE TENNESSEE VALLEY AUTHORITY (TVA). SHOULD TDEC DISCOVER THAT MONTHLY INSPECTIONS OF THE SITE ARE NOT APPROPRIATE DUE TO INSUFFICIENT STABILIZATION MEASURES OR OTHERWISE, TWICE WEEKLY INSPECTIONS SHALL RESUME. TDEC MAY INSPECT THE SITE TO CONFIRM OR DENY THE NOTIFICATION TO CONDUCT MONTHLY INSPECTIONS.
- QUALIFIED PERSONNEL (PROVIDED BY THE PERMITTEE OR COOPERATIVELY BY MULTIPLE PERMITTEES) SHALL INSPECT DISTURBED AREAS OF THE CONSTRUCTION SITE THAT HAVE NOT BEEN FINALLY STABILIZED, AREAS USED FOR STORAGE OF MATERIALS THAT ARE EXPOSED TO PRECIPITATION, STRUCTURAL CONTROL MEASURES, LOCATIONS WHERE VEHICLES ENTER OR EXIT THE SITE, AND EACH OUTFALL.
- DISTURBED AREAS AND AREAS USED FOR STORAGE OF MATERIALS THAT ARE EXPOSED TO PRECIPITATION SHALL BE INSPECTED FOR EVIDENCE OF THE POTENTIAL FOR POLLUTANTS ENTERING THE SITE'S DRAINAGE SYSTEM. EROSION PREVENTION AND SEDIMENT CONTROL MEASURES SHALL BE OBSERVED TO ENSURE THAT THEY ARE OPERATING CORRECTLY.
- OUTFALL POINTS (WHERE DISCHARGES LEAVE THE SITE AND/OR ENTER WATERS OF THE STATE) SHALL BE INSPECTED TO DETERMINE WHETHER EROSION PREVENTION AND SEDIMENT CONTROL MEASURES ARE EFFECTIVE IN PREVENTING SIGNIFICANT POLLUTION TO RECEIVING WATERS. WHERE DISCHARGE LOCATIONS ARE INACCESSIBLE, NEARBY DOWNSTREAM LOCATIONS SHALL BE INSPECTED. LOCATIONS WHERE VEHICLES ENTER OR EXIT THE SITE SHALL BE INSPECTED FOR EVIDENCE OF OFF-SITE SEDIMENT TRACKING.
- BASED ON THE RESULTS OF THE INSPECTION, ANY INADEQUATE CONTROL MEASURES OR CONTROL MEASURES IN DISREPAIR SHALL BE REPLACED OR MODIFIED, OR REPAIRED AS NECESSARY, BEFORE THE NEXT RAIN EVENT, BUT IN NO CASE MORE THAN 7 DAYS AFTER THE NEED IS IDENTIFIED.
- BASED ON THE RESULTS OF THE INSPECTION, THE SITE DESCRIPTION AND POLLUTION PREVENTION MEASURES IDENTIFIED IN THIS SWPPP SHALL BE REVISED AS APPROPRIATE, BUT IN NO CASE LATER THAN 7 DAYS FOLLOWING THE INSPECTION. SUCH MODIFICATIONS SHALL PROVIDE FOR TIMELY IMPLEMENTATION OF ANY CHANGES TO THE SWPPP, BUT IN NO CASE LATER THAN 14 DAYS FOLLOWING THE INSPECTION.
- ALL INSPECTIONS SHALL BE DOCUMENTED ON THE CONSTRUCTION STORMWATER INSPECTION CERTIFICATION FORM PROVIDED IN APPENDIX D OF THE SWPPP REPORT FOR ALL CONSTRUCTION SITES. INSPECTION DOCUMENTATION WILL BE MAINTAINED ON SITE AND MADE AVAILABLE TO TDEC UPON REQUEST. INSPECTION REPORTS MUST BE SUBMITTED TO TDEC WITHIN 10 DAYS OF THE REQUEST. IF TDEC REQUESTS THE CONSTRUCTION STORMWATER INSPECTION CERTIFICATION FORM TO BE SUBMITTED, THE SUBMITTED FORM MUST CONTAIN THE PRINTED NAME AND SIGNATURE OF THE TRAINED CERTIFIED INSPECTOR AND THE PERSON WHO MEETS THE SIGNATORY REQUIREMENTS OF SECTION 7.7.2 OF THE NPDES GENERAL PERMIT.
- TRAINED CERTIFIED INSPECTORS SHALL COMPLETE INSPECTION DOCUMENTATION TO THE BEST OF THEIR ABILITY. FALSIFYING INSPECTION RECORDS OR OTHER DOCUMENTATION OR FAILURE TO COMPLETE INSPECTION DOCUMENTATION SHALL RESULT IN A VIOLATION OF THIS PERMIT AND ANY OTHER APPLICABLE ACTS OR RULES.
- SUBSEQUENT OPERATOR(S) (PRIMARY PERMITTEES) WHO HAVE OBTAINED COVERAGE UNDER THE NPDES GENERAL PERMIT SHOULD CONDUCT TWICE WEEKLY INSPECTIONS, UNLESS THEIR PORTION(S) OF THE SITE HAS BEEN TEMPORARILY STABILIZED, OR RUNOFF IS UNLIKELY DUE TO WINTER CONDITIONS OR DUE TO EXTREME DROUGHT AS STATED IN PARAGRAPH A) ABOVE. THE PRIMARY PERMITTEE (SUCH AS A DEVELOPER) IS NO LONGER REQUIRED TO CONDUCT INSPECTIONS OF PORTIONS OF THE SITE THAT ARE COVERED BY A SUBSEQUENT PRIMARY PERMITTEE (SUCH AS A HOME BUILDER).

NOTE:

CONTRACTOR SHALL INSTALL A 4'X4' WEATHER PROOF SIGN (6' HEIGHT) AT THE MAIN CONSTRUCTION ENTRANCE. THE SIGN SHALL HAVE THE FOLLOWING INFORMATION:

- A COPY OF THE NOTICE OF COVERAGE WITH THE NPDES PERMIT NUMBER (FURNISHED BY ENGINEER).
- THE NAME AND TELEPHONE NUMBER OF A LOCAL CONTACT PERSON (FURNISHED BY CONSTRUCTION MANAGER).
- DESCRIPTION OF PROJECT (FURNISHED BY CONSTRUCTION MANAGER).

NOTE:

- AFTER EVERY STORM EVENT, THE ENTIRE SILT FENCE MUST BE INSPECTED AND ANY NEEDED REPAIRS DONE AT THAT TIME. SHOULD ANY DAMAGE OCCUR DUE TO TRAFFIC OR ANY OTHER ACTIVITY THE FENCE MUST BE REPAIRED BEFORE THE END OF EACH WORK DAY.
- PLEASE SEE SHEETS C2.0 & C6.0 OF THE CONTRACT DOCUMENTS FOR THE SITE GRADING AND DRAINAGE PLAN AND ADDITIONAL SITE GRADING & EROSION CONTROL NOTES. THESE SHEETS SHALL REMAIN A PERMANENT PART OF THE SWPPP AFTER CONSTRUCTION IS COMPLETE.

TYPICAL NOTES

- ALL CONTROL MEASURES MUST BE PROPERLY SELECTED, INSTALLED, AND MAINTAINED IN ACCORDANCE WITH THE MANUFACTURER SPECIFICATIONS AND THE CONTRACT DOCUMENTS. IF PERIODIC INSPECTIONS OR OTHER INFORMATION INDICATES A CONTROL HAS BEEN USED INAPPROPRIATELY OR INCORRECTLY, THE CONTRACTOR MUST REPLACE OR MODIFY THE CONTROL FOR SITE SITUATIONS.
- IF SEDIMENT ESCAPES THE CONSTRUCTION SITE, OFF-SITE ACCUMULATIONS OF SEDIMENT THAT HAVE NOT REACHED A STREAM MUST BE REMOVED IMMEDIATELY TO MINIMIZE OFF-SITE IMPACTS. PERMITTEES SHALL NOT INITIATE REMEDIATION/RESTORATION OF A STREAM WITHOUT CONSULTING THE DIVISION FIRST. THIS PERMIT DOES NOT, HOWEVER, AUTHORIZE ACCESS TO PRIVATE PROPERTY.
- SEDIMENT SHOULD BE REMOVED FROM SEDIMENT TRAPS, SILT FENCES, SEDIMENTATION PONDS, AND OTHER SEDIMENT CONTROLS AS NECESSARY, AND MUST BE REMOVED WHEN DESIGN CAPACITY HAS BEEN REDUCED BY 33%.
- LITTER, CONSTRUCTION DEBRIS, AND CONSTRUCTION CHEMICALS EXPOSED TO STORM WATER SHALL BE PICKED UP PRIOR TO ANTICIPATED STORM EVENTS, OR OTHERWISE PREVENTED FROM BECOMING A POLLUTANT SOURCE FOR STORM WATER DISCHARGES.
- PRE-CONSTRUCTION VEGETATIVE GROUND COVER SHALL NOT BE DESTROYED, REMOVED OR DISTURBED MORE THAN 15 CALENDAR DAYS PRIOR TO GRADING OR EARTH MOVING UNLESS THE AREA IS SEEDED AND/OR MULCHED OR OTHER TEMPORARY COVER IS INSTALLED.
- CLEARING AND GRUBBING MUST BE HELD TO THE MINIMUM NECESSARY FOR GRADING AND EQUIPMENT OPERATION.
- CONSTRUCTION MUST BE SEQUENCED TO MINIMIZE THE EXPOSURE TIME OF GRADED OR DENuded AREAS.
- EROSION AND SEDIMENT CONTROL MEASURES MUST BE IN PLACE AND FUNCTIONAL BEFORE EARTH MOVING OPERATIONS BEGIN, AND MUST BE CONSTRUCTED AND MAINTAINED THROUGHOUT THE CONSTRUCTION PERIOD. TEMPORARY MEASURES MAY BE REMOVED AT THE BEGINNING OF THE WORK DAY, BUT MUST BE REPLACED AT THE END OF THE WORK DAY.
- THE FOLLOWING RECORDS SHALL BE MAINTAINED ON SITE: THE DATES WHEN MAJOR GRADING ACTIVITIES OCCUR; THE DATES WHEN CONSTRUCTION ACTIVITIES TEMPORARILY OR PERMANENTLY CEASE ON A PORTION OF THE SITE; AND THE DATES WHEN STABILIZATION MEASURES ARE INITIATED.
- STABILIZATION MEASURES SHALL BE INITIATED AS SOON AS PRACTICAL IN PORTIONS OF THE SITE WHERE CONSTRUCTION ACTIVITIES HAVE TEMPORARILY OR PERMANENTLY CEASED, BUT IN NO CASE MORE THAN SEVEN DAYS AFTER THE CONSTRUCTION ACTIVITY IN THAT PORTION OF THE SITE HAS TEMPORARILY OR PERMANENTLY CEASED, EXCEPT IN THE FOLLOWING TWO SITUATIONS: 1. WHERE THE INITIATION OF STABILIZATION MEASURES BY THE SEVENTH DAY IS PRECIPITATED BY SNOW COVER OR FROZEN GROUND CONDITIONS, STABILIZATION MEASURES SHALL BE INITIATED AS SOON AS PRACTICAL; OR 2. WHERE CONSTRUCTION ACTIVITY ON A PORTION OF THE SITE IS TEMPORARILY CEASED, AND EARTH DISTURBING ACTIVITIES WILL BE RESUMED WITHIN 15 DAYS, TEMPORARY STABILIZATION MEASURES DO NOT HAVE TO BE INITIATED ON THAT PORTION OF SITE.
- CONSTRUCTION MUST BE PHASED FOR PROJECTS IN WHICH OVER 50 ACRES OF SOIL WILL BE DISTURBED. AREAS OF THE COMPLETED PHASE MUST BE STABILIZED WITHIN 21 DAYS AFTER ANOTHER PHASE HAS BEEN INITIATED OR OTHERWISE PREVENTED FROM BECOMING A POLLUTANT SOURCE FOR STORM WATER DISCHARGES; AFTER USE, SILT FENCES SHOULD BE REMOVED OR OTHERWISE PREVENTED FROM BECOMING A POLLUTANT SOURCE FOR STORM WATER DISCHARGES.
- TEMPORARY OR PERMANENT SOIL STABILIZATION SHALL BE ACCOMPLISHED WITHIN 15 DAYS AFTER FINAL GRADING OR OTHER EARTH WORK. PERMANENT STABILIZATION WITH PERENNIAL VEGETATION OR OTHER PERMANENTLY STABLE, NON-ERODING SURFACE SHALL REPLACE ANY TEMPORARY MEASURES AS SOON AS PRACTICABLE.
- NO SOLID MATERIALS INCLUDING BUILDING MATERIAL, SHALL BE DISCHARGED TO WATERS OF THE UNITED STATES EXCEPT AS AUTHORIZED BY A SECTION 404 PERMIT AND/OR TENNESSEE AQUATIC RESOURCE ALTERATION PERMIT.
- OFF-SITE VEHICLE TRACKING OF SEDIMENTS AND THE GENERATION OF DUST SHALL BE MINIMIZED.


NOTE:

- SIZE DRIVEWAY CULVERTS PER THE DESIGN CRITERIA SET FORTH BY THE METRO STORM WATER MANAGEMENT MANUAL (MINIMUM DRIVEWAY CULVERT IN METRO ROW IS 15" CMP)
- MAINTENANCE AGREEMENT #: 20161122-0123478


SITE ASSESSMENT NOTES

- THE SITE ASSESSMENT SHALL BE PERFORMED BY INDIVIDUALS WITH THE FOLLOWING QUALIFICATIONS:
 - A LICENSED PROFESSIONAL ENGINEER OR LANDSCAPE ARCHITECT
 - A CERTIFIED PROFESSIONAL IN EROSION AND SEDIMENT CONTROL (CPESC) OR
 - A PERSON THAT SUCCESSFULLY COMPLETED THE "LEVEL II DESIGN PRINCIPLES FOR EROSION PREVENTION AND SEDIMENT CONTROL FOR CONSTRUCTION SITES" COURSE.
- QUALITY ASSURANCE OF EROSION PREVENTION AND SEDIMENT CONTROLS SHALL BE DONE BY PERFORMING SITE ASSESSMENT AT A CONSTRUCTION SITE. THE SITE ASSESSMENT SHALL BE CONDUCTED AT EACH OUTFALL INVOLVING DRAINAGE TOTALING 10 OR MORE ACRES OR 5 OR MORE ACRES IF DRAINING TO AN IMPAIRED OR EXCEPTIONAL QUALITY WATERS, WITHIN A MONTH OF CONSTRUCTION COMMENCING AT EACH PORTION OF THE SITE THAT DRAINS THE QUALIFYING ACREAGE OF SUCH PORTION OF THE SITE.
- AS A MINIMUM, SITE ASSESSMENT SHOULD BE PERFORMED TO VERIFY THE INSTALLATION, FUNCTIONALITY AND PERFORMANCE OF THE CPESC MEASURES DESCRIBED IN THE SWPPP REPORT. THE SITE ASSESSMENT SHOULD BE PERFORMED WITH THE INSPECTOR, AND SHOULD INCLUDE A REVIEW AND UPDATE (IF APPLICABLE) OF THE SWPPP REPORT. MODIFICATIONS OF PLANS AND SPECIFICATIONS FOR ANY BUILDING OR STRUCTURE, INCLUDING THE DESIGN OF SEDIMENT BASINS OR OTHER SEDIMENT CONTROLS INVOLVING STRUCTURAL, HYDRAULIC, HYDROLOGIC OR OTHER ENGINEERING CALCULATIONS SHALL BE PREPARED BY A LICENSED PROFESSIONAL ENGINEER OR LANDSCAPE ARCHITECT AND STAMPED AND CERTIFIED IN ACCORDANCE WITH THE TENNESSEE CODE ANNOTATED, TITLE 62, CHAPTER 2 AND THE RULES OF THE TENNESSEE BOARD OF ARCHITECTURAL AND ENGINEERING EXAMINERS.
- THE SITE ASSESSMENT FINDINGS SHALL BE DOCUMENTED AND THE DOCUMENTATION KEPT WITH THE SWPPP REPORT AT THE SITE. AT A MINIMUM, THE DOCUMENTATION SHALL INCLUDE INFORMATION INCLUDED IN THE INSPECTION FORM PROVIDED IN APPENDIX D OF THE SWPPP REPORT. THE DOCUMENTATION MUST CONTAIN THE PRINTED NAME AND SIGNATURE OF THE INDIVIDUAL PERFORMING THE SITE ASSESSMENT AND THE FOLLOWING CERTIFICATION:



"I CERTIFY UNDER PENALTY OF LAW THAT THIS REPORT AND ALL ATTACHMENTS ARE, TO THE BEST OF MY KNOWLEDGE AND BELIEF, TRUE, ACCURATE, AND COMPLETE. I AM AWARE THAT THERE ARE SIGNIFICANT PENALTIES FOR SUBMITTING FALSE INFORMATION, INCLUDING THE POSSIBILITY OF FINE AND IMPRISONMENT FOR KNOWING VIOLATIONS."
- THE SITE ASSESSMENT CAN TAKE THE PLACE OF ONE OF THE TWICE WEEKLY INSPECTIONS REQUIREMENT.
- TDEC MAY REQUIRE ADDITIONAL SITE ASSESSMENT(S) TO BE PERFORMED IF SITE INSPECTED BY TDEC'S PERSONNEL REVEALS SITE CONDITIONS THAT HAVE POTENTIAL OF CAUSING POLLUTION TO THE WATERS OF THE STATE.

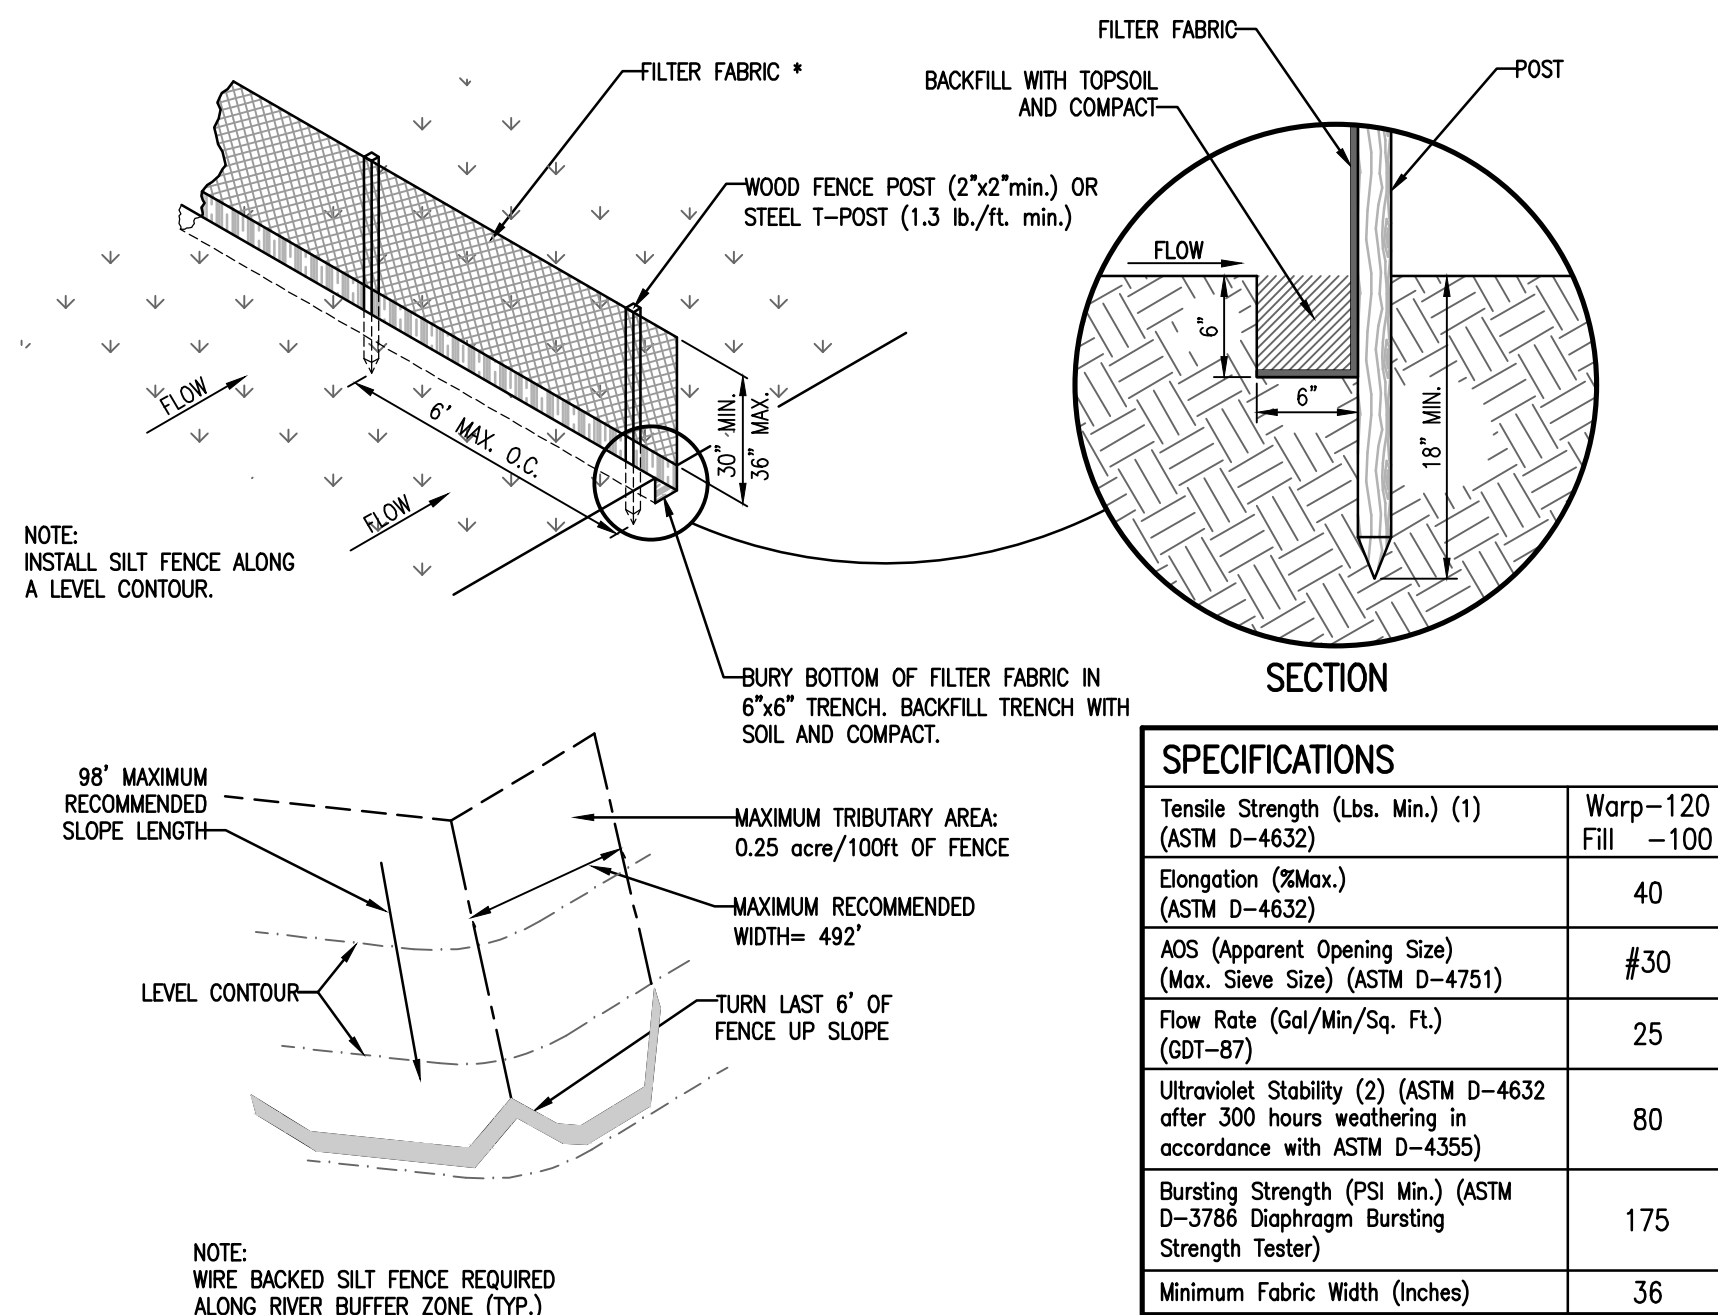


4 SILT FENCE (TCP-13)
NOT TO SCALE

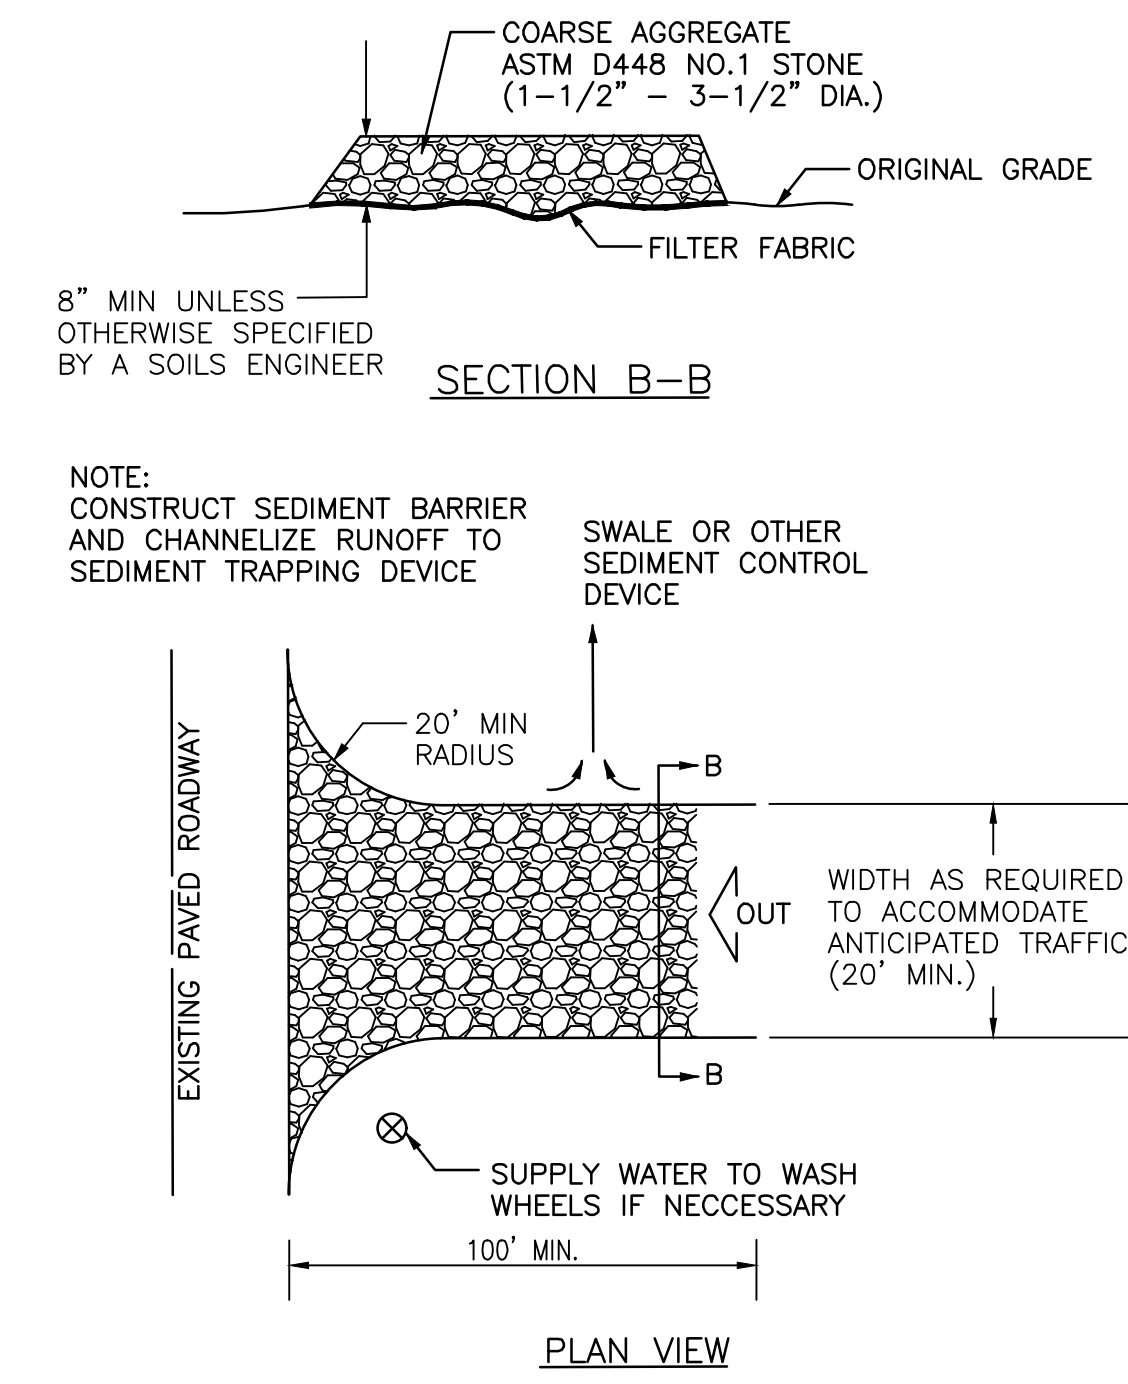


1 TEMPORARY CONSTRUCTION ENTRANCE (TCP-03)
NOT TO SCALE

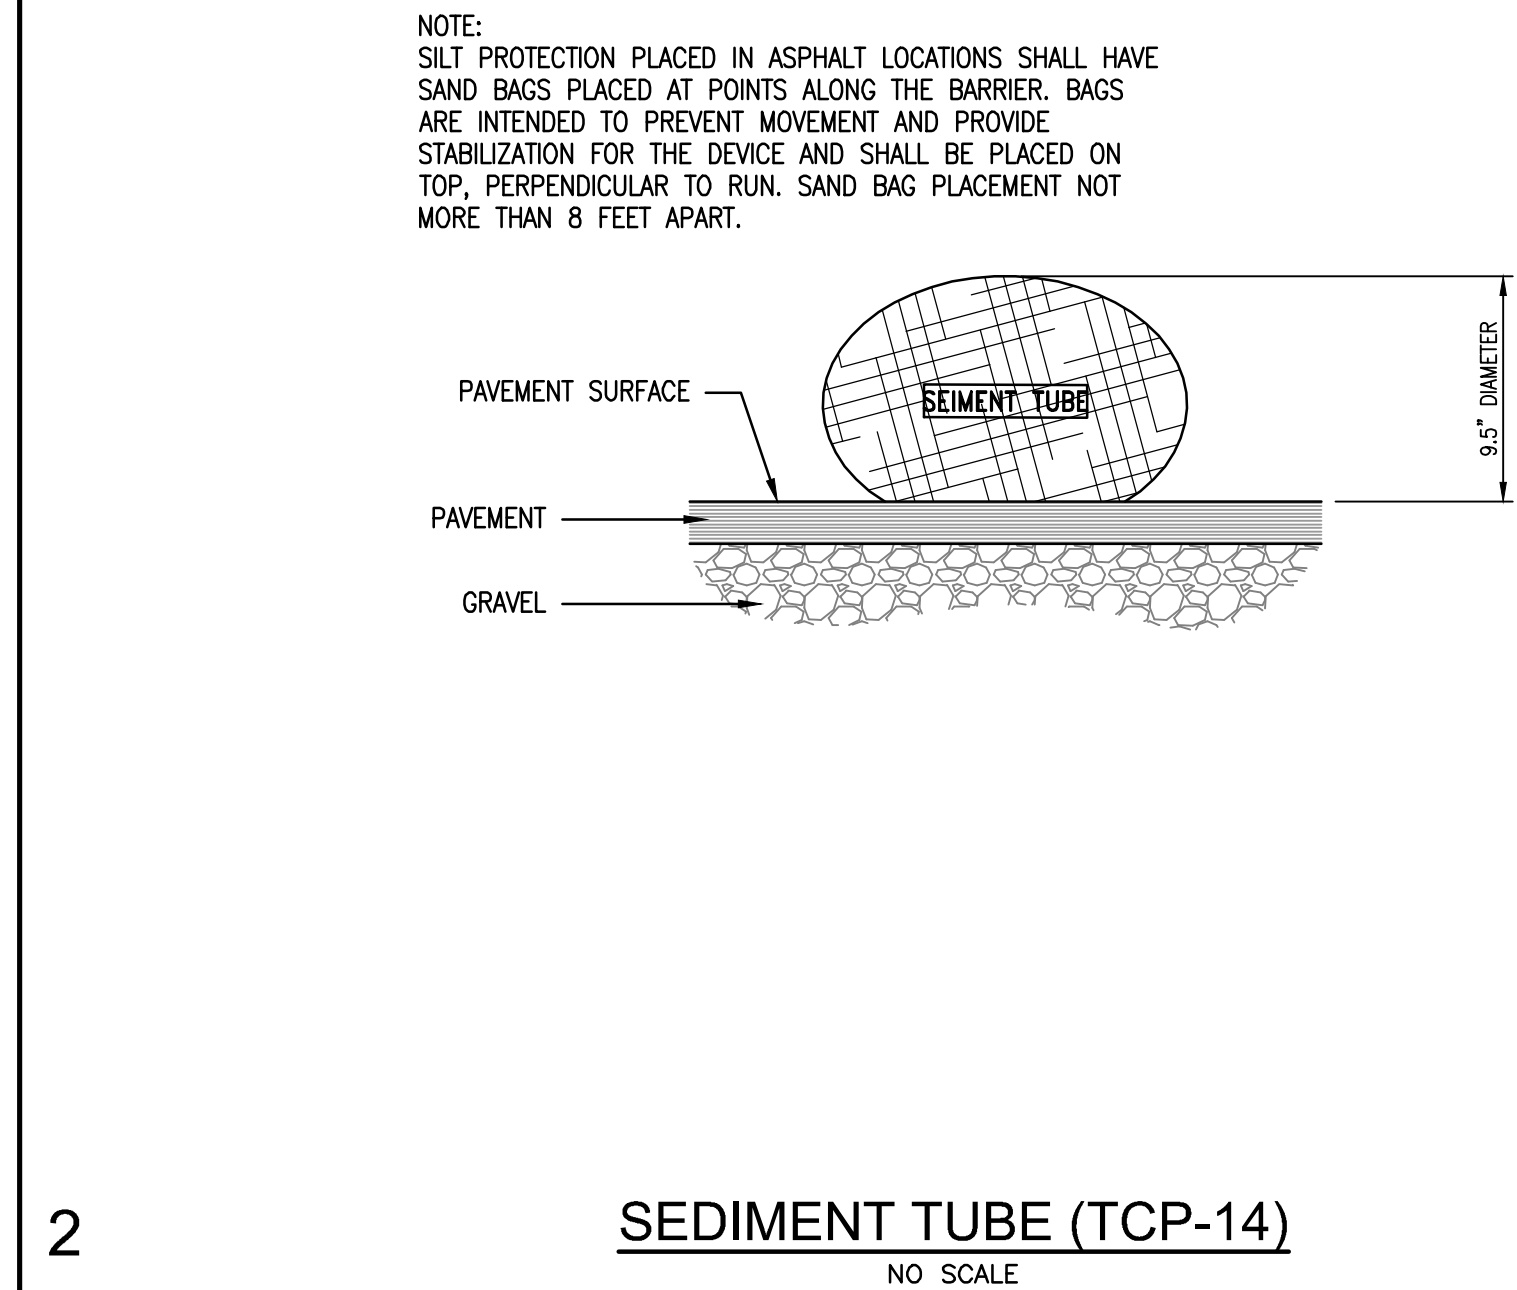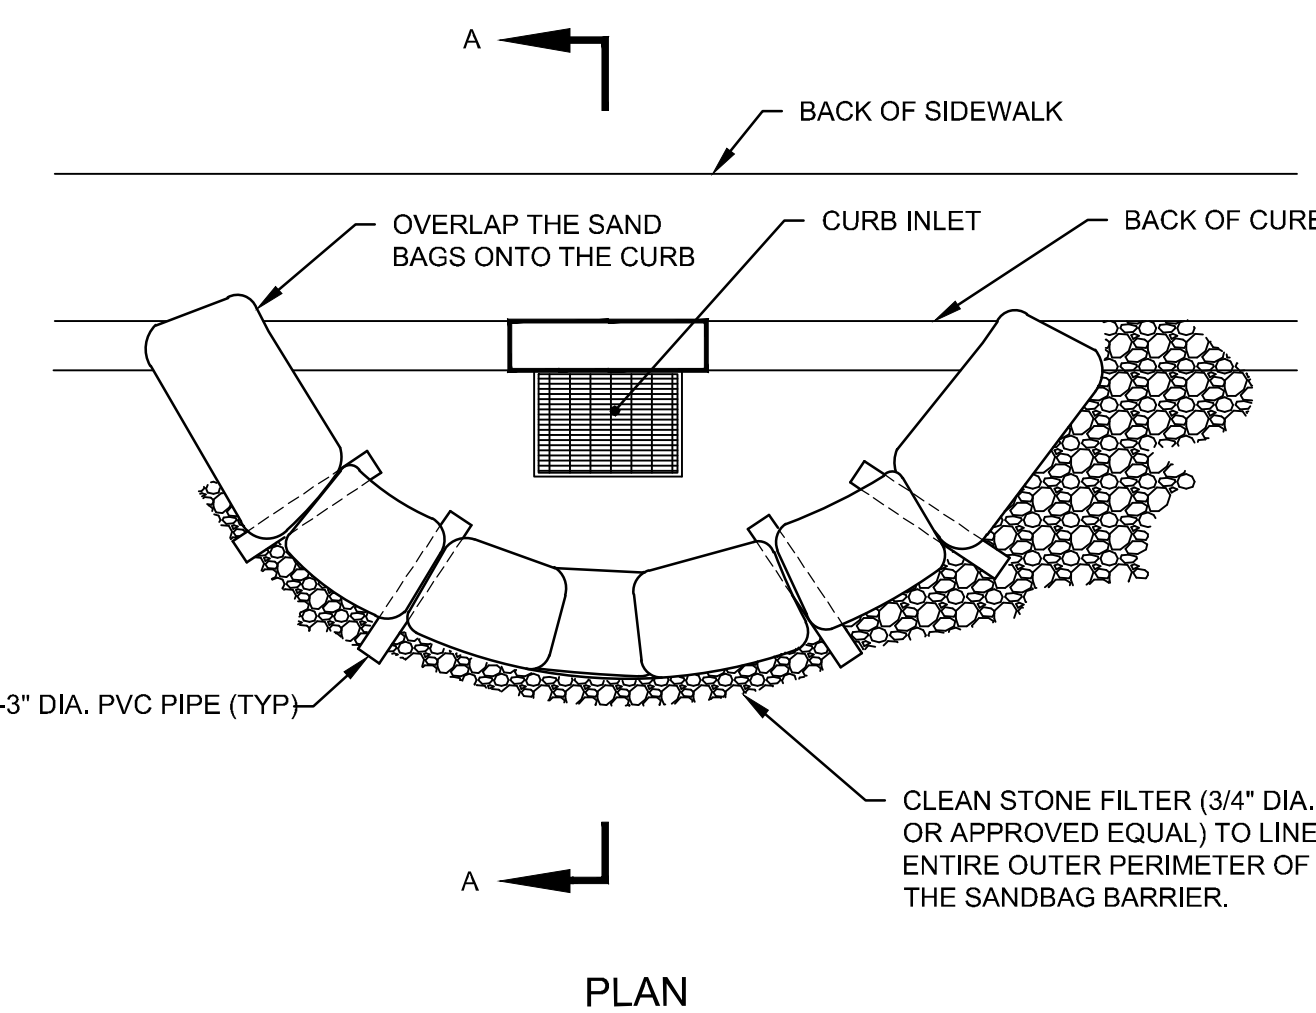


2 SEDIMENT TUBE (TCP-14)
NO SCALE

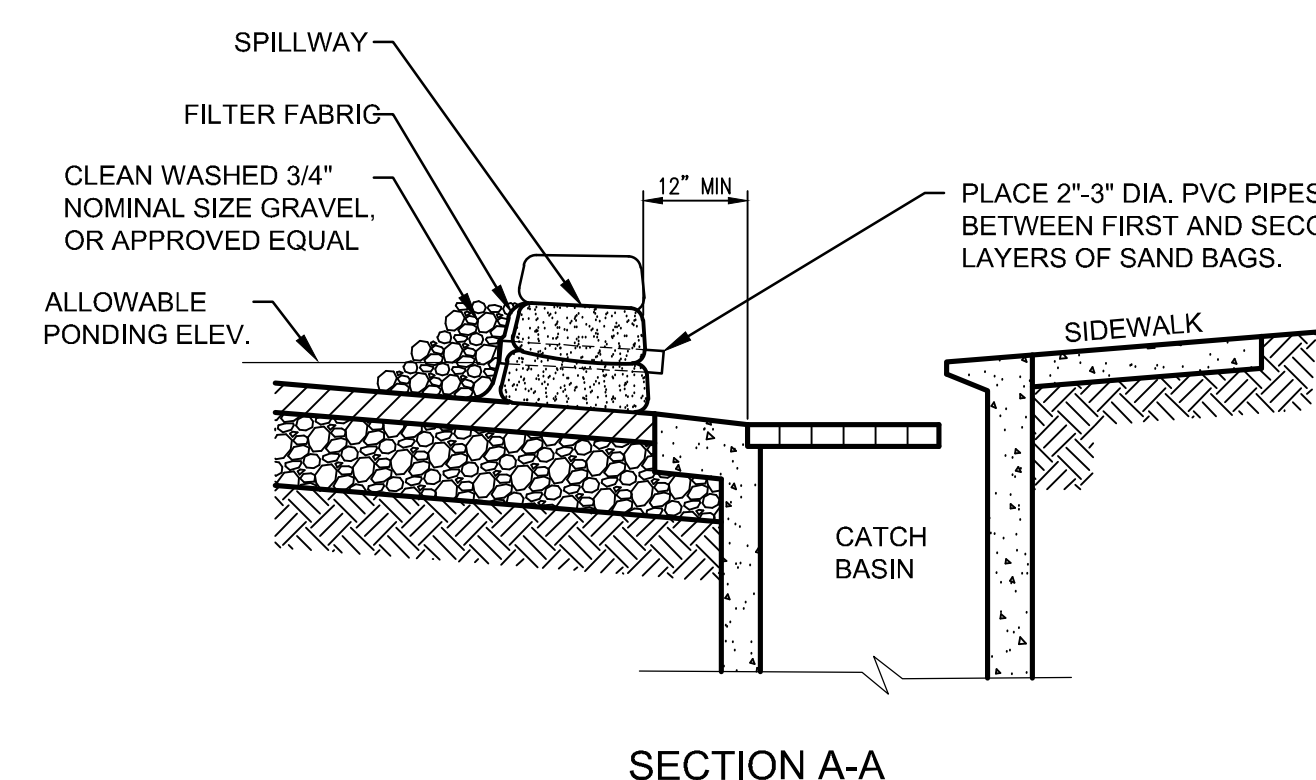

5 INLET PROTECTION (TCP-24)
NO SCALE

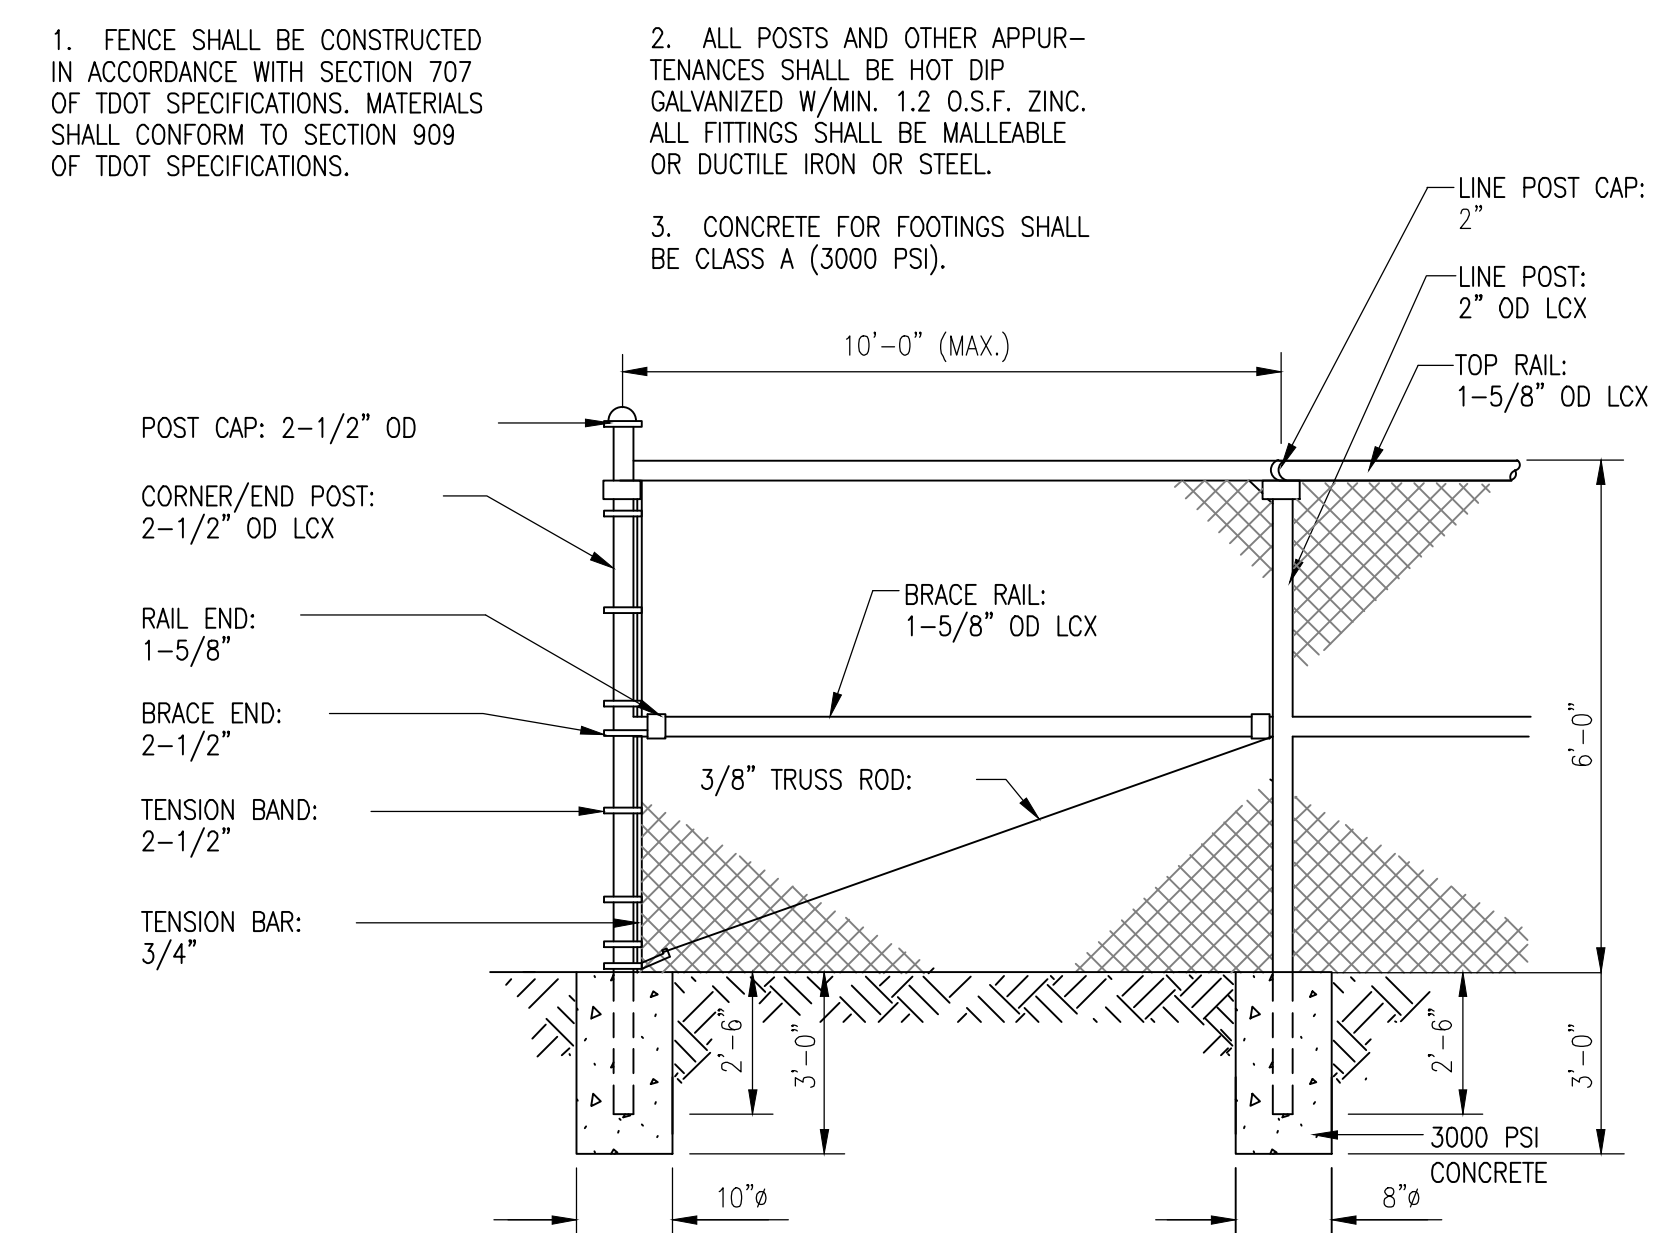



3 CONSTRUCTION FENCE
NOT TO SCALE

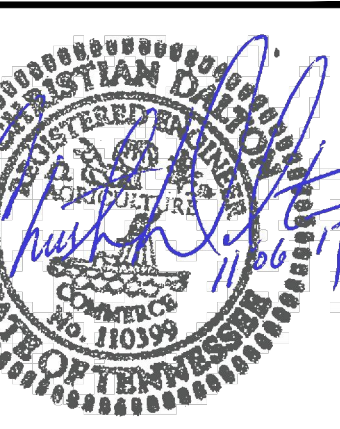

DATE	REVISIONS
2017.09.28	20150950

C3.3

EPSC DETAILS

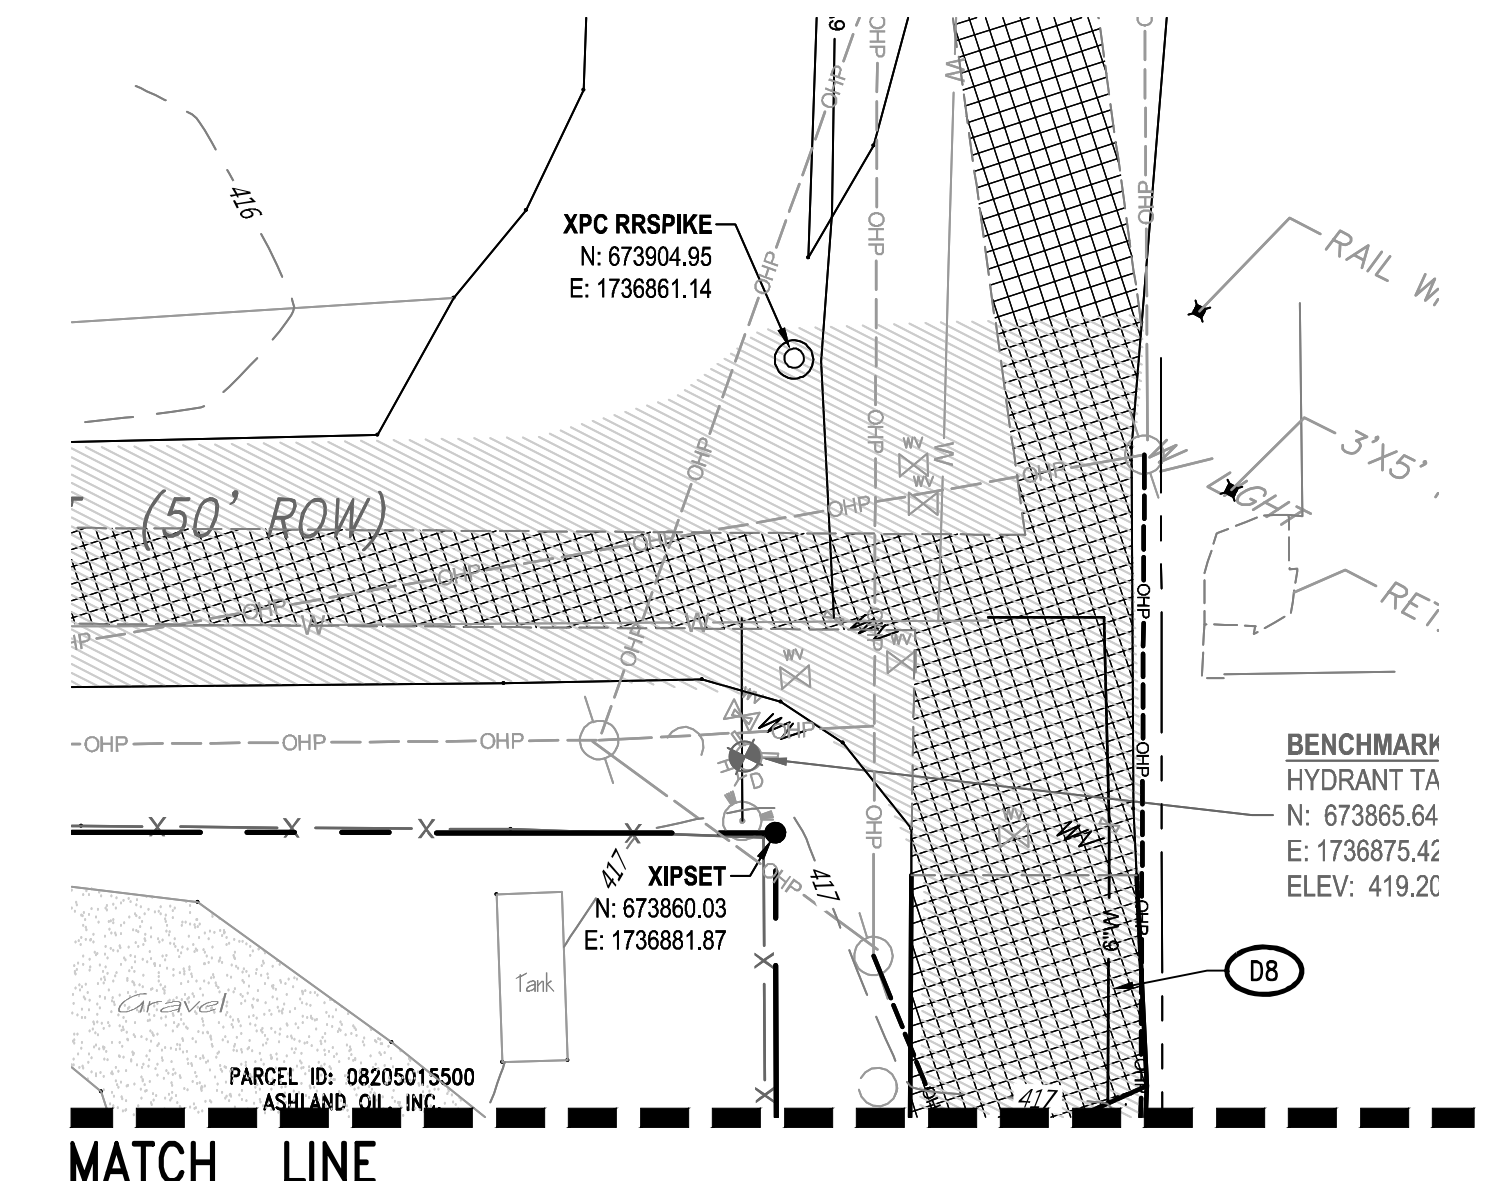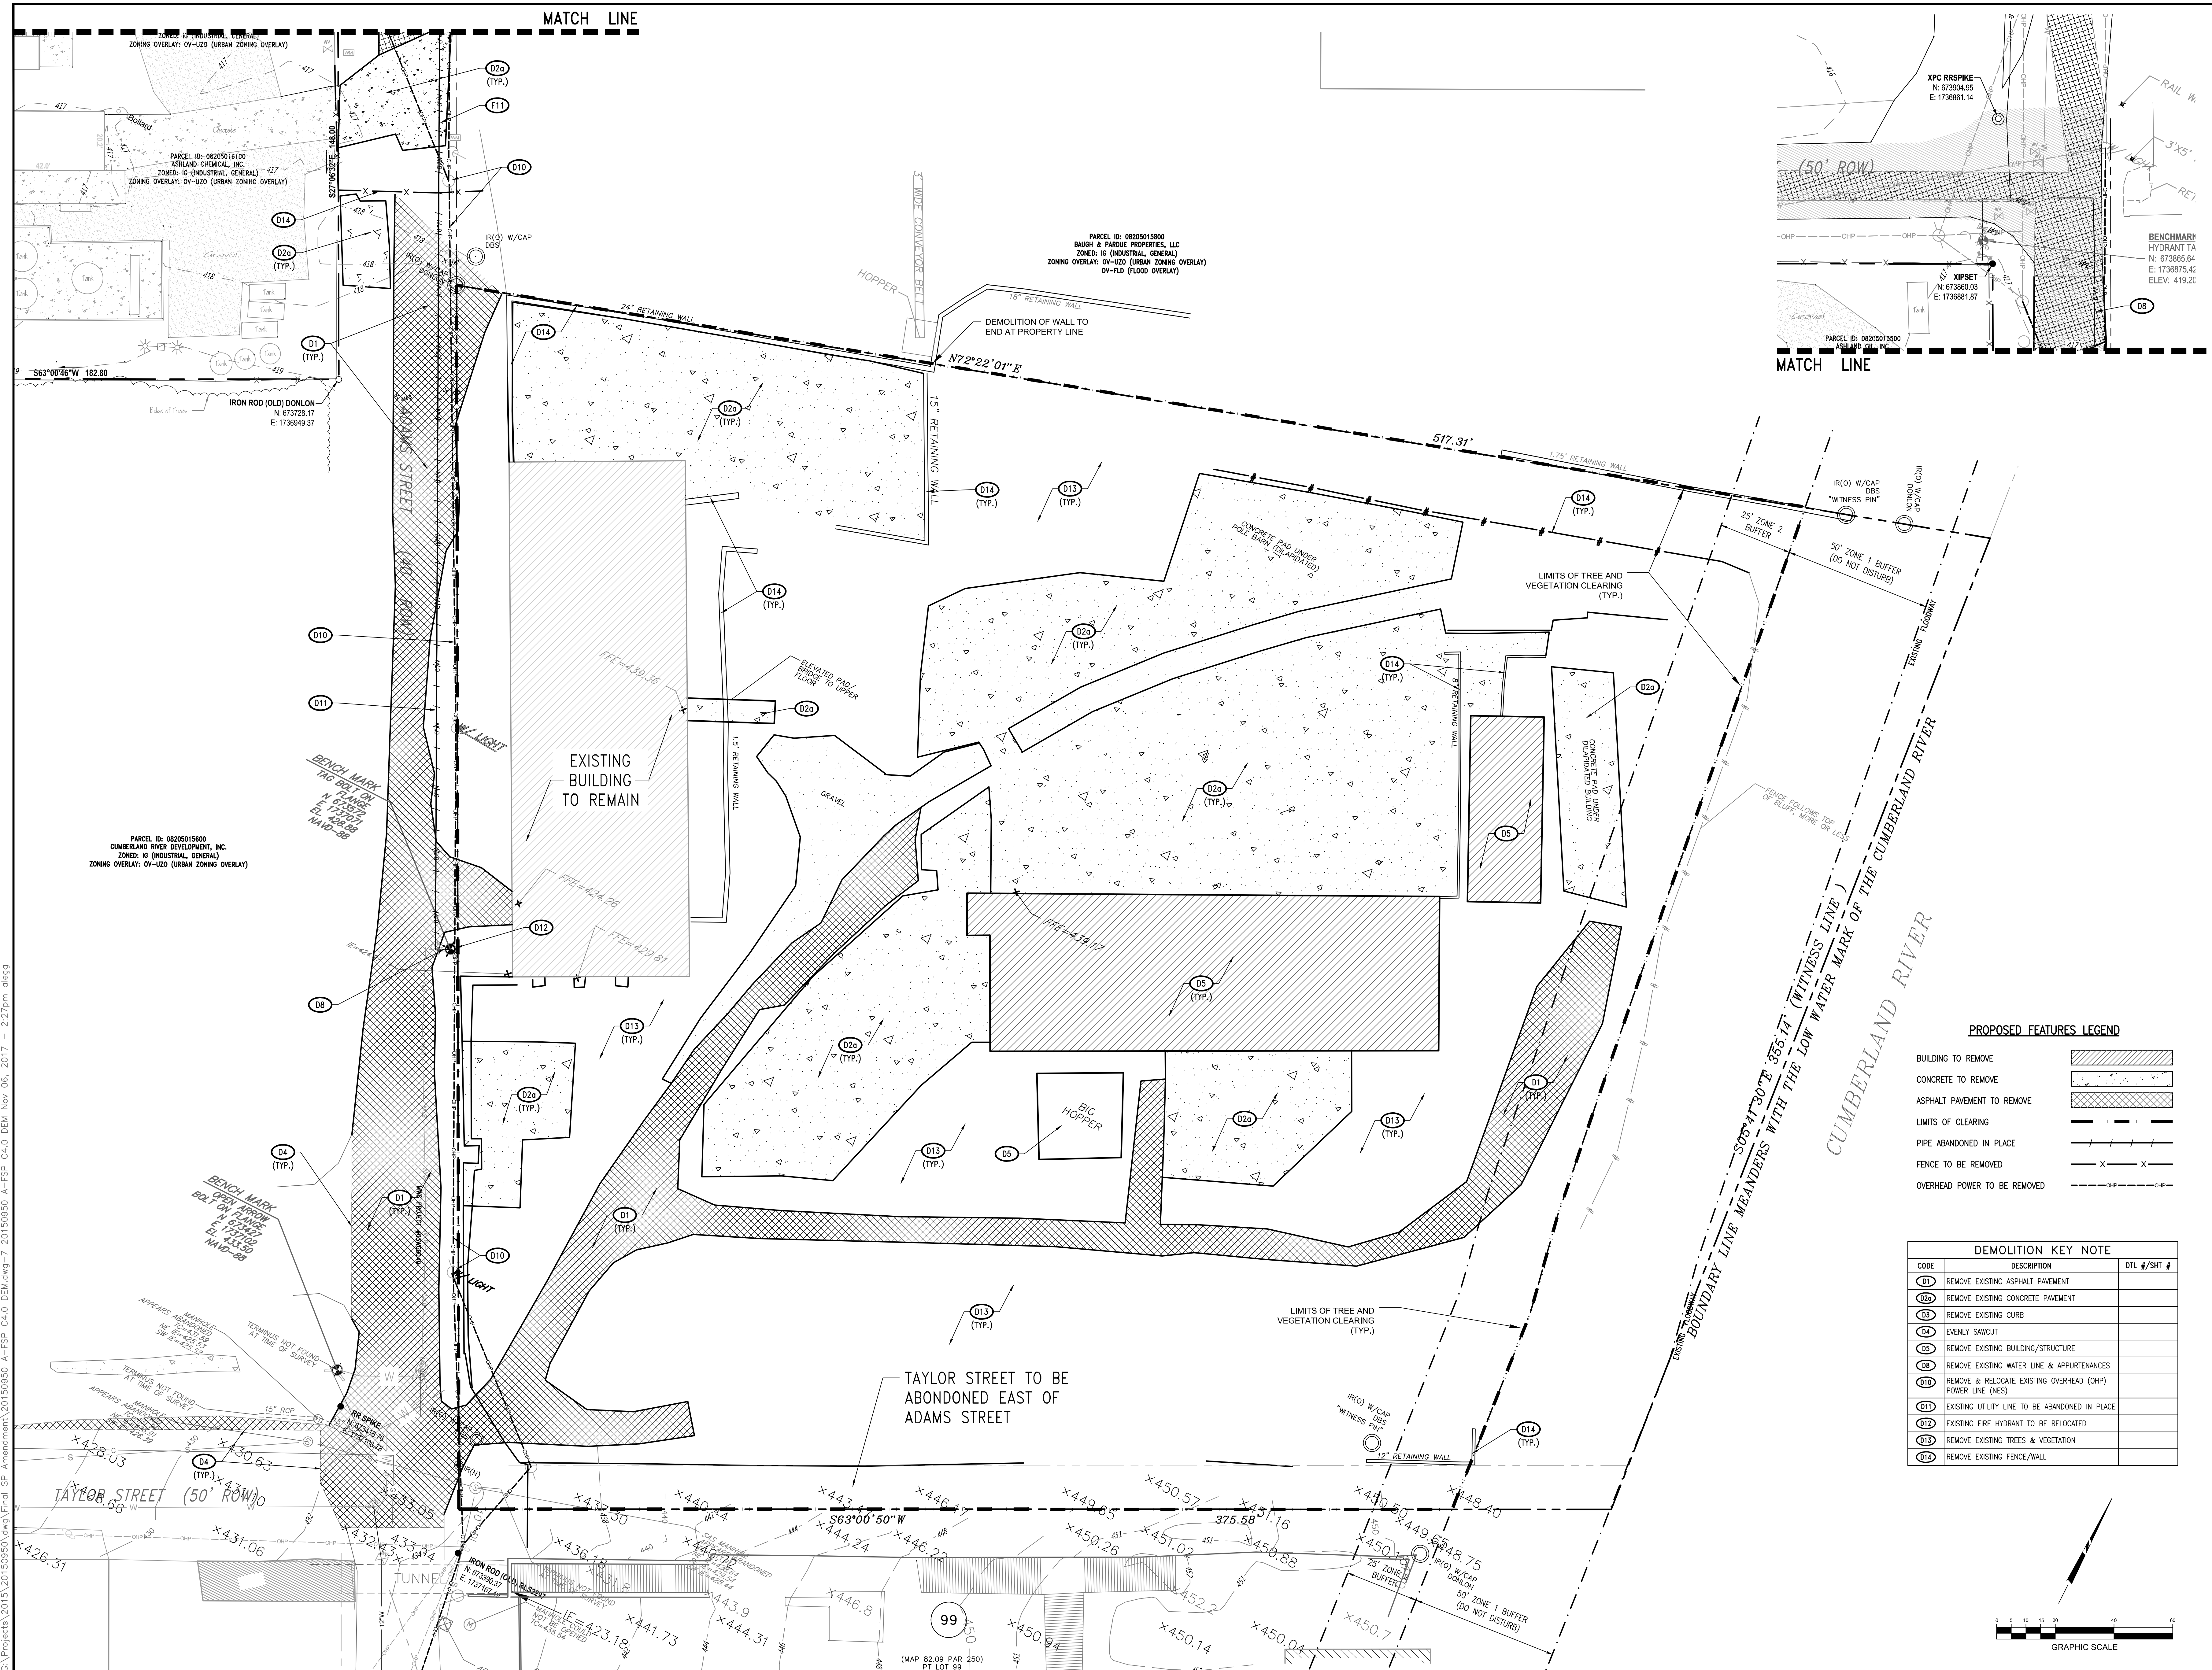

PROPOSED FEATURES LEGEND

BUILDING TO REMOVE	
CONCRETE TO REMOVE	
ASPHALT PAVEMENT TO REMOVE	
LIMITS OF CLEARING	
PIPE ABANDONED IN PLACE	
FENCE TO BE REMOVED	
OVERHEAD POWER TO BE REMOVED	

DEMOLITION KEY NOTE


CODE	DESCRIPTION	DTL #/SHT #
D1	REMOVE EXISTING ASPHALT PAVEMENT	
D2a	REMOVE EXISTING CONCRETE PAVEMENT	
D3	REMOVE EXISTING CURB	
D4	EVENLY SAWCUT	
D5	REMOVE EXISTING BUILDING/STRUCTURE	
D8	REMOVE EXISTING WATER LINE & APPURTENANCES	
D10	REMOVE & RELOCATE EXISTING OVERHEAD (OHP) POWER LINE (NES)	
D11	EXISTING UTILITY LINE TO BE ABANDONED IN PLACE	
D12	EXISTING FIRE HYDRANT TO BE RELOCATED	
D13	REMOVE EXISTING TREES & VEGETATION	
D14	REMOVE EXISTING FENCE/WALL	

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SP PLAN AMENDMENT
HAMMER MILL MULTIFAMILY
NASHVILLE, DAVIDSON COUNTY, TENNESSEE

Gateway TBR
Hammer Mill, GP
1575 NORTHSIDE DRIVE
BUILDING 100, SUITE 200
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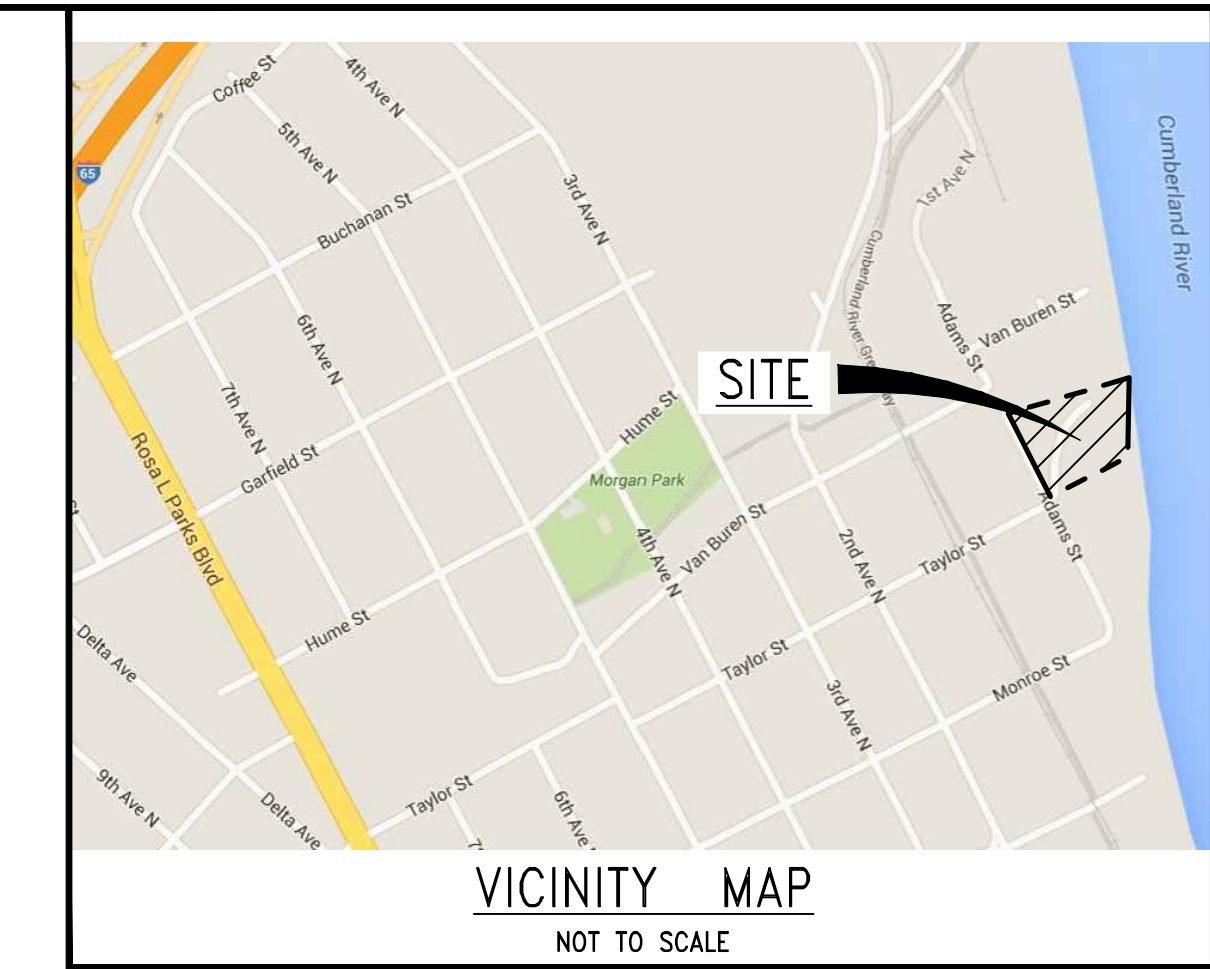
C4.0
SITE DEMOLITION

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MATCH LINE SHEET C5.1

CURVE TABLE					
CURVE #	LENGTH	RADIUS	DELTA	CHORD DIRECTION	CHORD LENGTH
C1	51.77	30.00	98.88	N58° 11' 43"W	45.58
C2	23.45	1010.00	1.33	N8° 05' 32"W	23.45
C3	47.32	38.49	70.44	N27° 47' 36"E	44.40

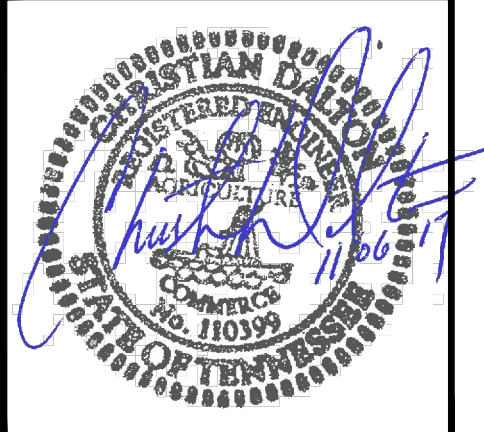SIGNAGE KEY NOTE		
CODE	DESCRIPTION	DTL #/SHT #
S60	ACCESSIBLE PARKING SIGN	-
S62	ACCESSIBLE PASSENGER LOADING/UNLOADING SIGN	-
S63	"STOP" SIGN	-
S64	"DO NOT ENTER" SIGN	-
S65	"ONE WAY" SIGN	-
S66	"FIRE LANE" "NO PARKING" SIGNAGE	-
S67	DIRECTIONAL SIGNAGE	-
S68	"NO PARKING" SIGN	-



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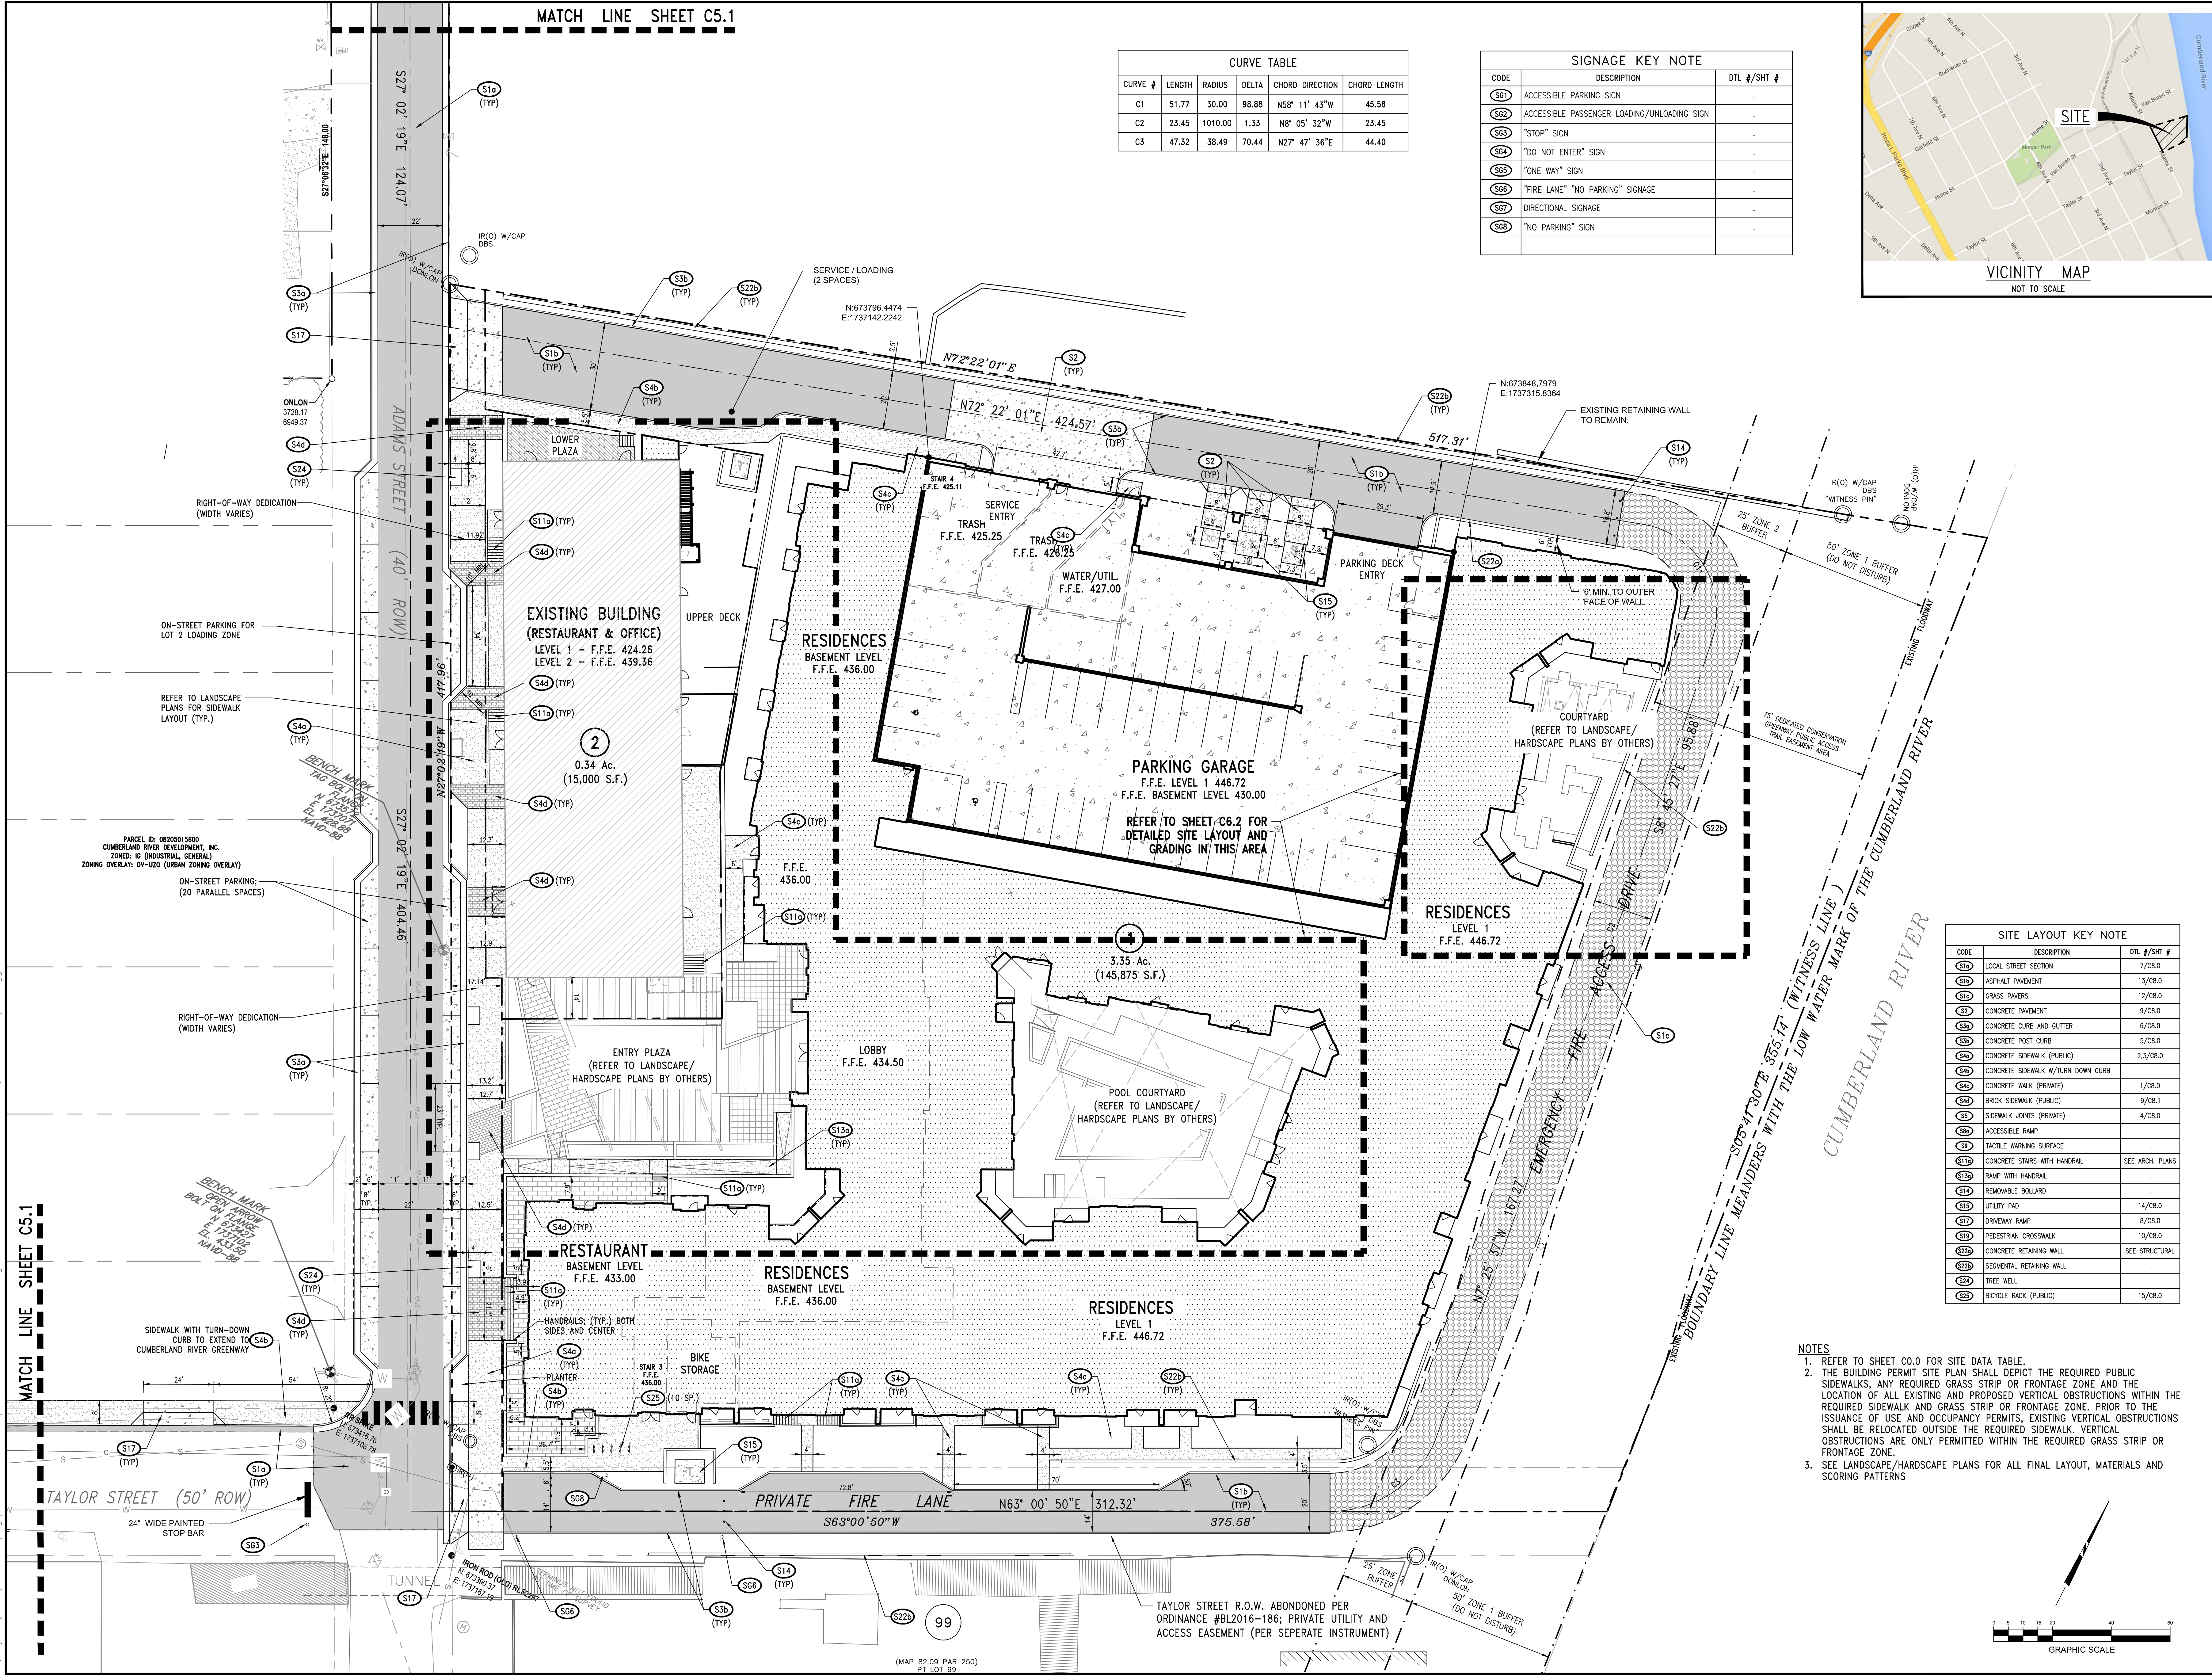
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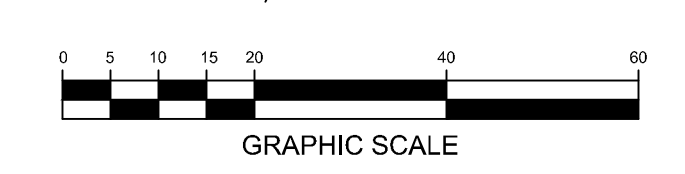
DATE	REVISIONS
2017.09.28	20150950

C5.0
SITE LAYOUT



SITE LAYOUT KEY NOTE		
CODE	DESCRIPTION	DTL #/SHT #
S10	LOCAL STREET SECTION	7/C8.0
S11	ASPHALT PAVEMENT	13/C8.0
S12	GRASS PAVERS	12/C8.0
S13	CONCRETE PAVEMENT	9/C8.0
S14	CONCRETE CURB AND GUTTER	6/C8.0
S15	CONCRETE POST CURB	5/C8.0
S16	CONCRETE SIDEWALK (PUBLIC)	2,3/C8.0
S17	CONCRETE SIDEWALK W/TURN DOWN CURB	-
S18	CONCRETE WALK (PRIVATE)	1/C8.0
S19	BRICK SIDEWALK (PUBLIC)	9/C8.1
S20	SIDEWALK JOINTS (PRIVATE)	4/C8.0
S21	ACCESSIBLE RAMP	-
S22	TACTILE WARNING SURFACE	-
S23	CONCRETE STAIRS WITH HANDRAIL	SEE ARCH. PLANS
S24	RAMP WITH HANDRAIL	-
S25	REMOVABLE BOLLARD	-
S26	UTILITY PAD	14/C8.0
S27	DRIVEWAY RAMP	8/C8.0
S28	PEDESTRIAN CROSSWALK	10/C8.0
S29	CONCRETE RETAINING WALL	SEE STRUCTURAL
S30	SEGMENTAL RETAINING WALL	-
S31	TREE WELL	-
S32	BICYCLE RACK (PUBLIC)	15/C8.0

- NOTES
- REFER TO SHEET C0.0 FOR SITE DATA TABLE.
 - THE BUILDING PERMIT SITE PLAN SHALL DEPICT THE REQUIRED PUBLIC SIDEWALKS, ANY REQUIRED GRASS STRIP OR FRONTAGE ZONE AND THE LOCATION OF ALL EXISTING AND PROPOSED VERTICAL OBSTRUCTIONS WITHIN THE REQUIRED SIDEWALK AND GRASS STRIP OR FRONTAGE ZONE. PRIOR TO THE ISSUANCE OF USE AND OCCUPANCY PERMITS, EXISTING VERTICAL OBSTRUCTIONS SHALL BE RELOCATED OUTSIDE THE REQUIRED SIDEWALK. VERTICAL OBSTRUCTIONS ARE ONLY PERMITTED WITHIN THE REQUIRED GRASS STRIP OR FRONTAGE ZONE.
 - SEE LANDSCAPE/HARDSCAPE PLANS FOR ALL FINAL LAYOUT, MATERIALS AND SCORING PATTERNS.





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- NO GRADING PERMIT SHALL BE REQUIRED FOR AN EXCAVATION OR FILL THAT SATISFIES ALL OF THE FOLLOWING CRITERIA:
1. FILL MATERIAL CONTAINS ONLY INERT SOIL, ROCK, CONCRETE WITHOUT REBAR AND NO MORE THAN 24 INCHES IN LENGTH, AND/OR BRICK RUBBLE.
 2. FILL IS NOT IN THE 100-YEAR FLOODPLAIN AND IS LESS THAN FIVE (5) FEET IN VERTICAL DEPTH AT ITS DEEPEST POINT AS MEASURED FROM THE NATURAL GROUND.
 3. DOES NOT RESULT IN A TOTAL QUANTITY OF MORE THAN 100 CUBIC YARDS OF MATERIAL BEING REMOVED FROM, DEPOSITED ON, OR DISTURBED ON ANY LOT, PARCEL, OR SUBDIVISION THEREOF.
 4. DOES NOT IMPAIR EXISTING SURFACE STORMWATER MANAGEMENT SYSTEMS, CONSTITUTE A POTENTIAL EROSION HAZARD, OR ACT AS A SOURCE OF SEDIMENTATION TO ANY ADJACENT LAND OR WATERCOURSE.
 5. HAS NO FILL PLACED ON A SURFACE HAVING A SLOPE STEEPER THAN FIVE (5) FEET HORIZONTAL TO ONE FOOT VERTICAL (STEEPER SLOPES CAN BE ALLOWED IF JUSTIFIED BY CALCULATIONS FOR APPROPRIATE STABILIZATION MEASURES).
 6. HAS NO FINAL SLOPES STEEPER THAN ONE (1) FOOT VERTICAL TO THREE (3) FEET HORIZONTAL (STEEPER SLOPES CAN BE ALLOWED IF JUSTIFIED BY CALCULATIONS FOR APPROPRIATE STABILIZATION MEASURES).
 7. HAS TEMPORARY OR PERMANENT SOIL STABILIZATION MEASURES APPLIED TO DENODED AREA S WITHIN 15 DAYS OF DISTURBANCE. DOES NOT CONTAIN HAZARDOUS SUBSTANCES.
 8. IS NOT PARTIALLY OR TOTALLY IN A WATERSHED WITH OUTLET TO A SINKHOLE OR DRAINAGE WELL.
 9. DOES NOT RESULT IN THE EXPOSURE OR DISTURBANCE OF MORE THAN 10,000 SQUARE FEET OF LAND.

CODE	DESCRIPTION	DTL #/SHT #
S10	LOCAL STREET SECTION	7/C8.0
S11	ASPHALT PAVEMENT	13/C8.0
S12	GRASS PAVERS	12/C8.0
S13	CONCRETE PAVEMENT	9/C8.0
S14	CONCRETE CURB AND GUTTER	6/C8.0
S15	CONCRETE POST CURB	5/C8.0
S16	CONCRETE SIDEWALK (PUBLIC)	2,3/C8.0
S17	CONCRETE SIDEWALK W/TURN DOWN CURB	
S18	CONCRETE WALK (PRIVATE)	1/C8.0
S19	BRICK SIDEWALK (PUBLIC)	9/C8.1
S20	SIDEWALK JOINTS (PRIVATE)	4/C8.0
S21	ACCESSIBLE RAMP	
S22	TACTILE WARNING SURFACE	
S23	CONCRETE STAIRS WITH HANDRAIL	SEE ARCH. PLANS
S24	RAMP WITH HANDRAIL	
S25	REMOVABLE BOLLARD	
S26	UTILITY PAD	14/C8.0
S27	DRIVEWAY RAMP	8/C8.0
S28	PEDESTRIAN CROSSWALK	10/C8.0
S29	CONCRETE RETAINING WALL	SEE STRUCTURAL
S30	SEGMENTAL RETAINING WALL	
S31	TREE WELL	
S32	BI-CYCLE RACK (PUBLIC)	15/C8.0

SITE LAYOUT KEY NOTE



- NOTES
1. THE FINAL SITE PLAN SHALL DEPICT A MINIMUM 5 FOOT CLEAR PATH OF TRAVEL FOR PEDESTRIAN WAYS, INCLUDING PUBLIC SIDEWALKS, AND THE LOCATION OF ALL EXISTING AND PROPOSED OBSTRUCTIONS. PRIOR TO THE ISSUANCE OF USE AND OCCUPANCY PERMITS, EXISTING OBSTRUCTIONS WITHIN THE PATH OF TRAVEL SHALL BE RELOCATED TO PROVIDE A MINIMUM OF 5 FEET CLEAR ACCESS.

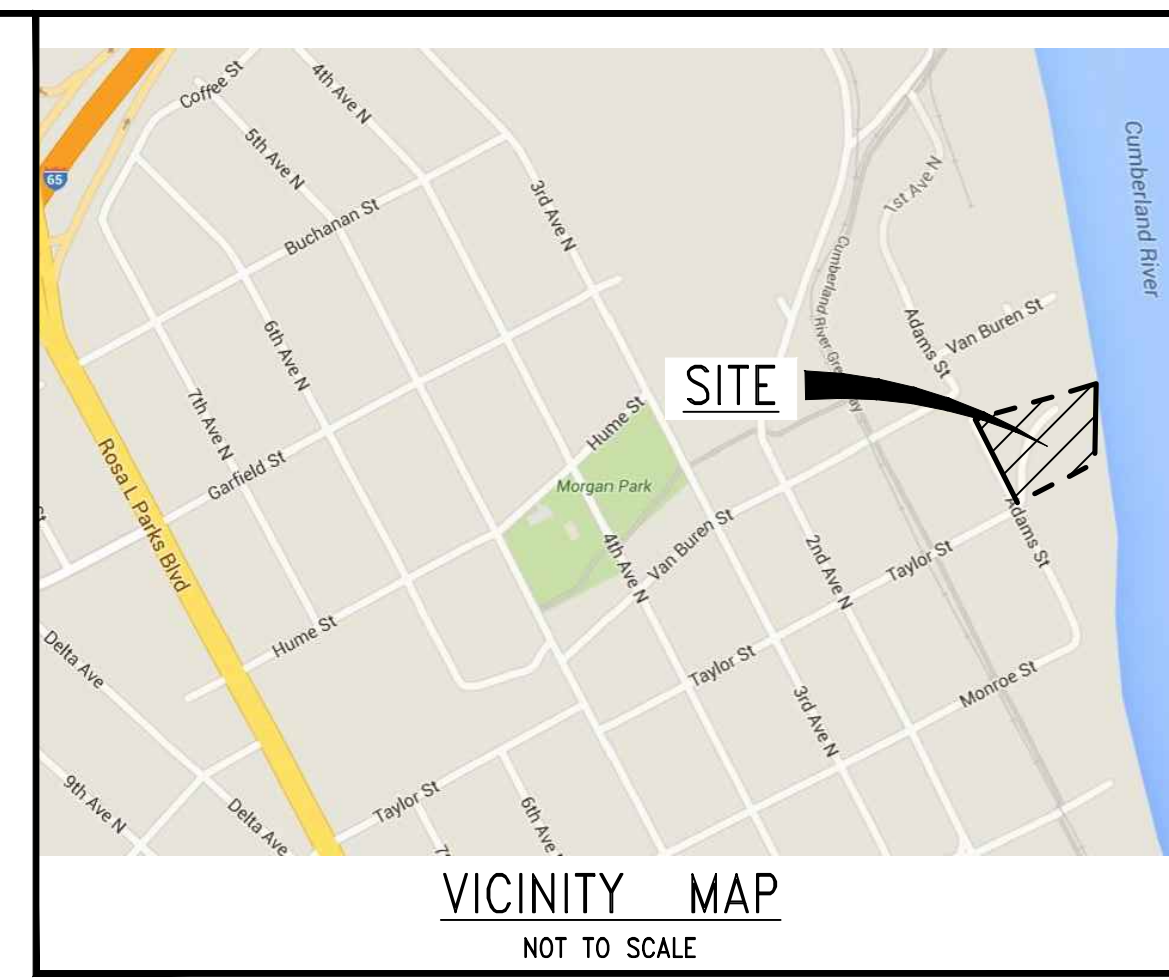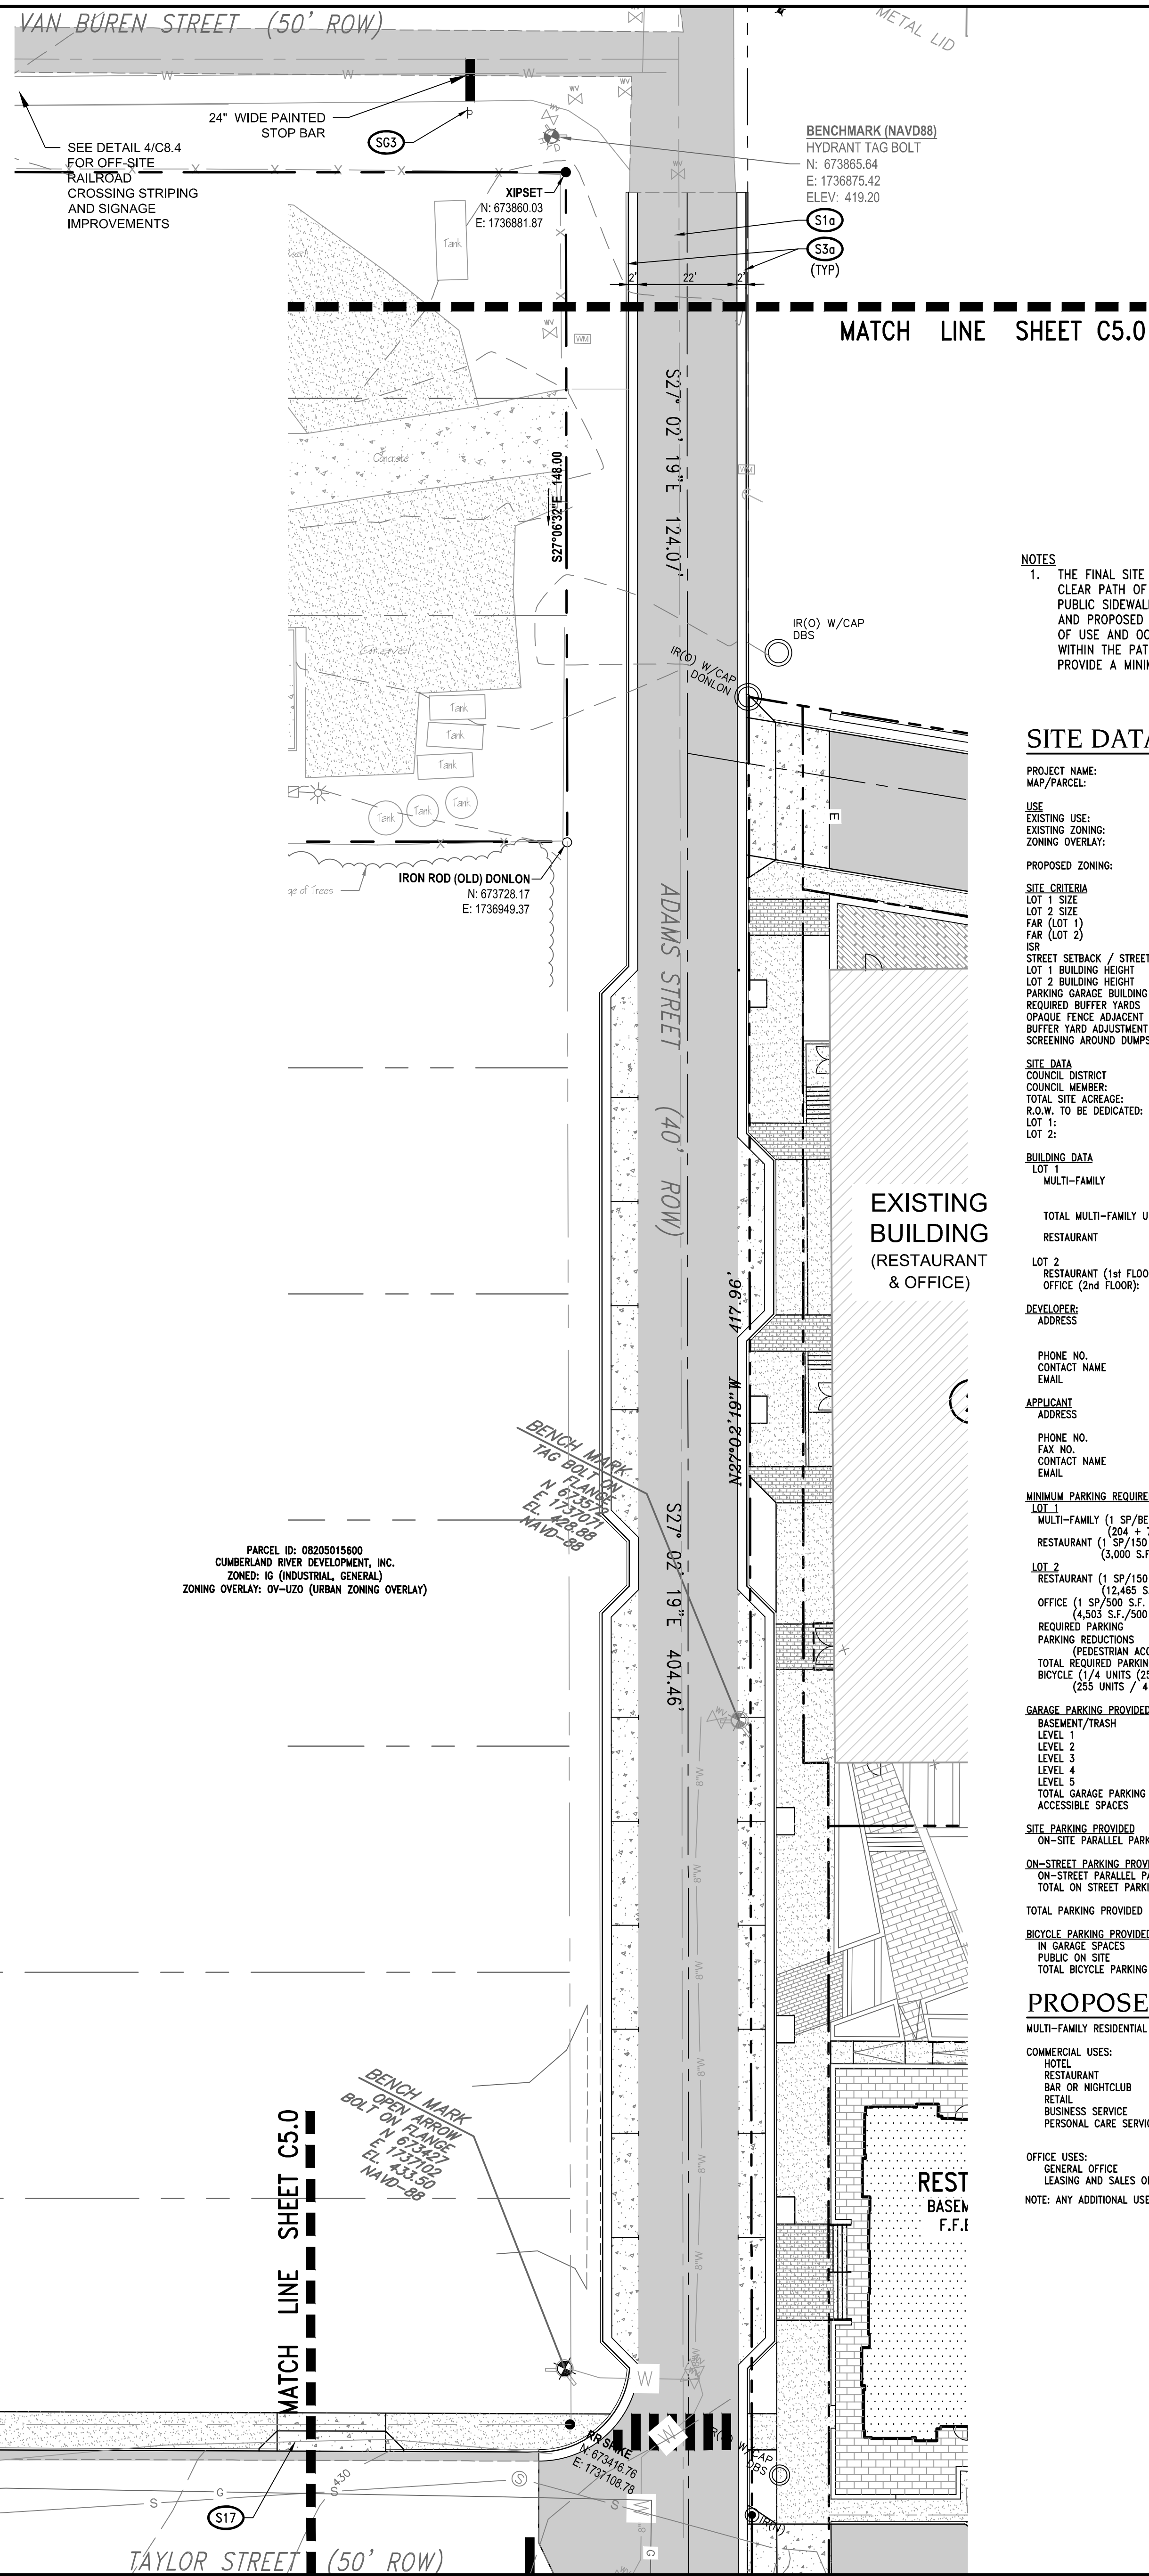SITE DATA

PROJECT NAME:	HAMMER MILL MULTIFAMILY
MAP/PARCEL:	82-05 / 159
USE:	RESIDENTIAL, RESTAURANT, OFFICE
EXISTING ZONING:	SP (SPECIFIC PLAN)
ZONING OVERLAY:	OY-UZO (URBAN ZONING OVERLAY)
PROPOSED ZONING:	OY-UZO (FLOOD OVERLAY) SP (SPECIFIC PLAN)
SITE CRITERIA	151,129 S.F. 16,811 S.F.
LOT 1 SIZE	1.48 (223,830/151,129)
LOT 2 SIZE	1.26 (21,134/16,811)
FAR (LOT 1)	74X (123,475/167,940)
FAR (LOT 2)	PER MAJOR COLLECTOR STREET PLAN
ISR	7 STORY
STREET SETBACK / STREET TYPE(S)	5 STORY W/ BASEMENT
LOT 1 BUILDING HEIGHT	2 STORY
LOT 2 BUILDING HEIGHT	7 STORY
PARKING GARAGE BUILDING HEIGHT	N/A
REQUIRED BUFFER YARDS	75' FLOOD
OPaque FENCE ADJACENT TO RESIDENTIAL IN PARKING AREA	N/A
BUFFER YARD ADJUSTMENT	N/A
SCREENING AROUND DUMPSTERS	PROVIDED
SITE DATA	19
COUNCIL DISTRICT	FREDDIE O'CONNELL
COUNCIL MEMBER:	5.99 AC. (172,812 SQ. FT.)
TOTAL SITE ACORAGE:	0.15 AC. (6,872 SQ. FT.)
LOT 1:	5.47 AC. (151,129 SQ. FT.)
LOT 2:	0.39 AC. (16,811 SQ. FT.)
BUILDING DATA	
LOT 1	MULTI-FAMILY
LOT 2	RESTAURANT (1st FLOOR HAMMER MILL); OFFICE (2nd FLOOR)
TOTAL MULTI-FAMILY UNITS:	151 - 1 BEDROOM 51 - 2 BEDROOM 53 - STUDIO 255 / 220,530 GROSS S.F. 4,000 S.F.
DEVELOPER:	TRIBRIDGE RESIDENTIAL
ADDRESS:	1575 NORTHSIDE DRIVE BUILDING 100, SUITE 200 ATLANTA, GA 30318
PHONE NO.:	404.252.2600
CONTACT NAME:	WILLIAM MORRIS
EMAIL:	william@tribridge.com
APPLICANT:	LITTLEJOHN
ADDRESS:	1835 21st AVE. SOUTH NASHVILLE, TN 37212
PHONE NO.:	615.385.4144
FAX NO.:	615.385.4020
CONTACT NAME:	MR. ANDREW WOLTERS
EMAIL:	awolters@ljohn.com

MULTI-FAMILY (1 SP/BEDROOM + 1.5 SP/2 OR MORE BR.)	281 SPACES
RESTAURANT (1 SP/150 S.F. ABOVE 1,000 S.F.)	20 SPACES
OFFICE (1 SP/500 S.F. ABOVE 2,000 S.F.)	84 SPACES
OFFICE (1 SP/200 S.F. ABOVE 1,000 S.F.)	9 SPACES
REQUIRED PARKING	394 SPACES
PARKING REDUCTIONS (PEDESTRIAN ACCESS -10% (390x10))	-39 SPACES
TOTAL REQUIRED PARKING	355 SPACES
BI-CYCLE (1/4 UNITS (25%) / MAX 50)	50 SPACES
(255 UNITS / 4 = 64; MAX. 50)	
GARAGE PARKING PROVIDED	55 SPACES
BASEMENT/TRASH	55 SPACES
LEVEL 1	63 SPACES
LEVEL 2	63 SPACES
LEVEL 3	64 SPACES
LEVEL 4	44 SPACES
LEVEL 5	44 SPACES
TOTAL GARAGE PARKING PROVIDED	344 SPACES
ACCESSIBLE SPACES	8 SPACES TOTAL (2 VAN)
SITE PARKING PROVIDED	2 SPACES
ON-SITE PARALLEL PARKING	2 SPACES
ON-STREET PARKING PROVIDED	20 SPACES
ON-STREET PARALLEL PARKING	10 SPACES
TOTAL ON STREET PARKING (50X COUNTED)	10 SPACES
TOTAL PARKING PROVIDED	356 SPACES
BI-CYCLE PARKING PROVIDED	40 SPACES
IN GARAGE SPACES	10 SPACES
PUBLIC ON SITE	30 SPACES
TOTAL BI-CYCLE PARKING PROVIDED	70 SPACES

PROPOSED LAND USE TABLE (QUALIFYING USES)

MULTI-FAMILY RESIDENTIAL	
COMMERCIAL USES:	
HOTEL	
RESTAURANT	
BAR OR NIGHTCLUB	
RETAIL	
BUSINESS SERVICE	
PERSONAL CARE SERVICE	
OFFICE USES:	
GENERAL OFFICE	
LEASING AND SALES OFFICE	


NOTE: ANY ADDITIONAL USES QUALIFYING ORDER THE MUI ZONING DESIGNATION

Littlejohn
An S&ME Company

1835 21st Avenue South, Nashville, Tennessee 37212
T: 615.385.4144 F: 615.385.4020 www.ljohn.com

Case No: 2016SP-005-003
SP PLAN AMENDMENT
HAMMER MILL MULTIFAMILY
NASHVILLE, DAVIDSON COUNTY, TENNESSEE


Gateway TBR
Hammer Mill, GP
1575 NORTHSIDE DRIVE
BUILDING 100, SUITE 200
ATLANTA, GA 30318

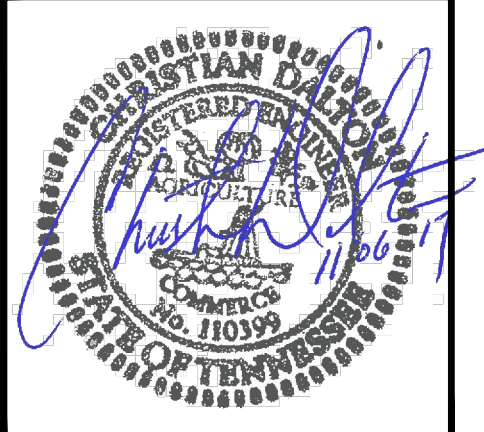

DATE	REVISIONS
2017.09.28	20150950

C5.1
OFF-SITE LAYOUT



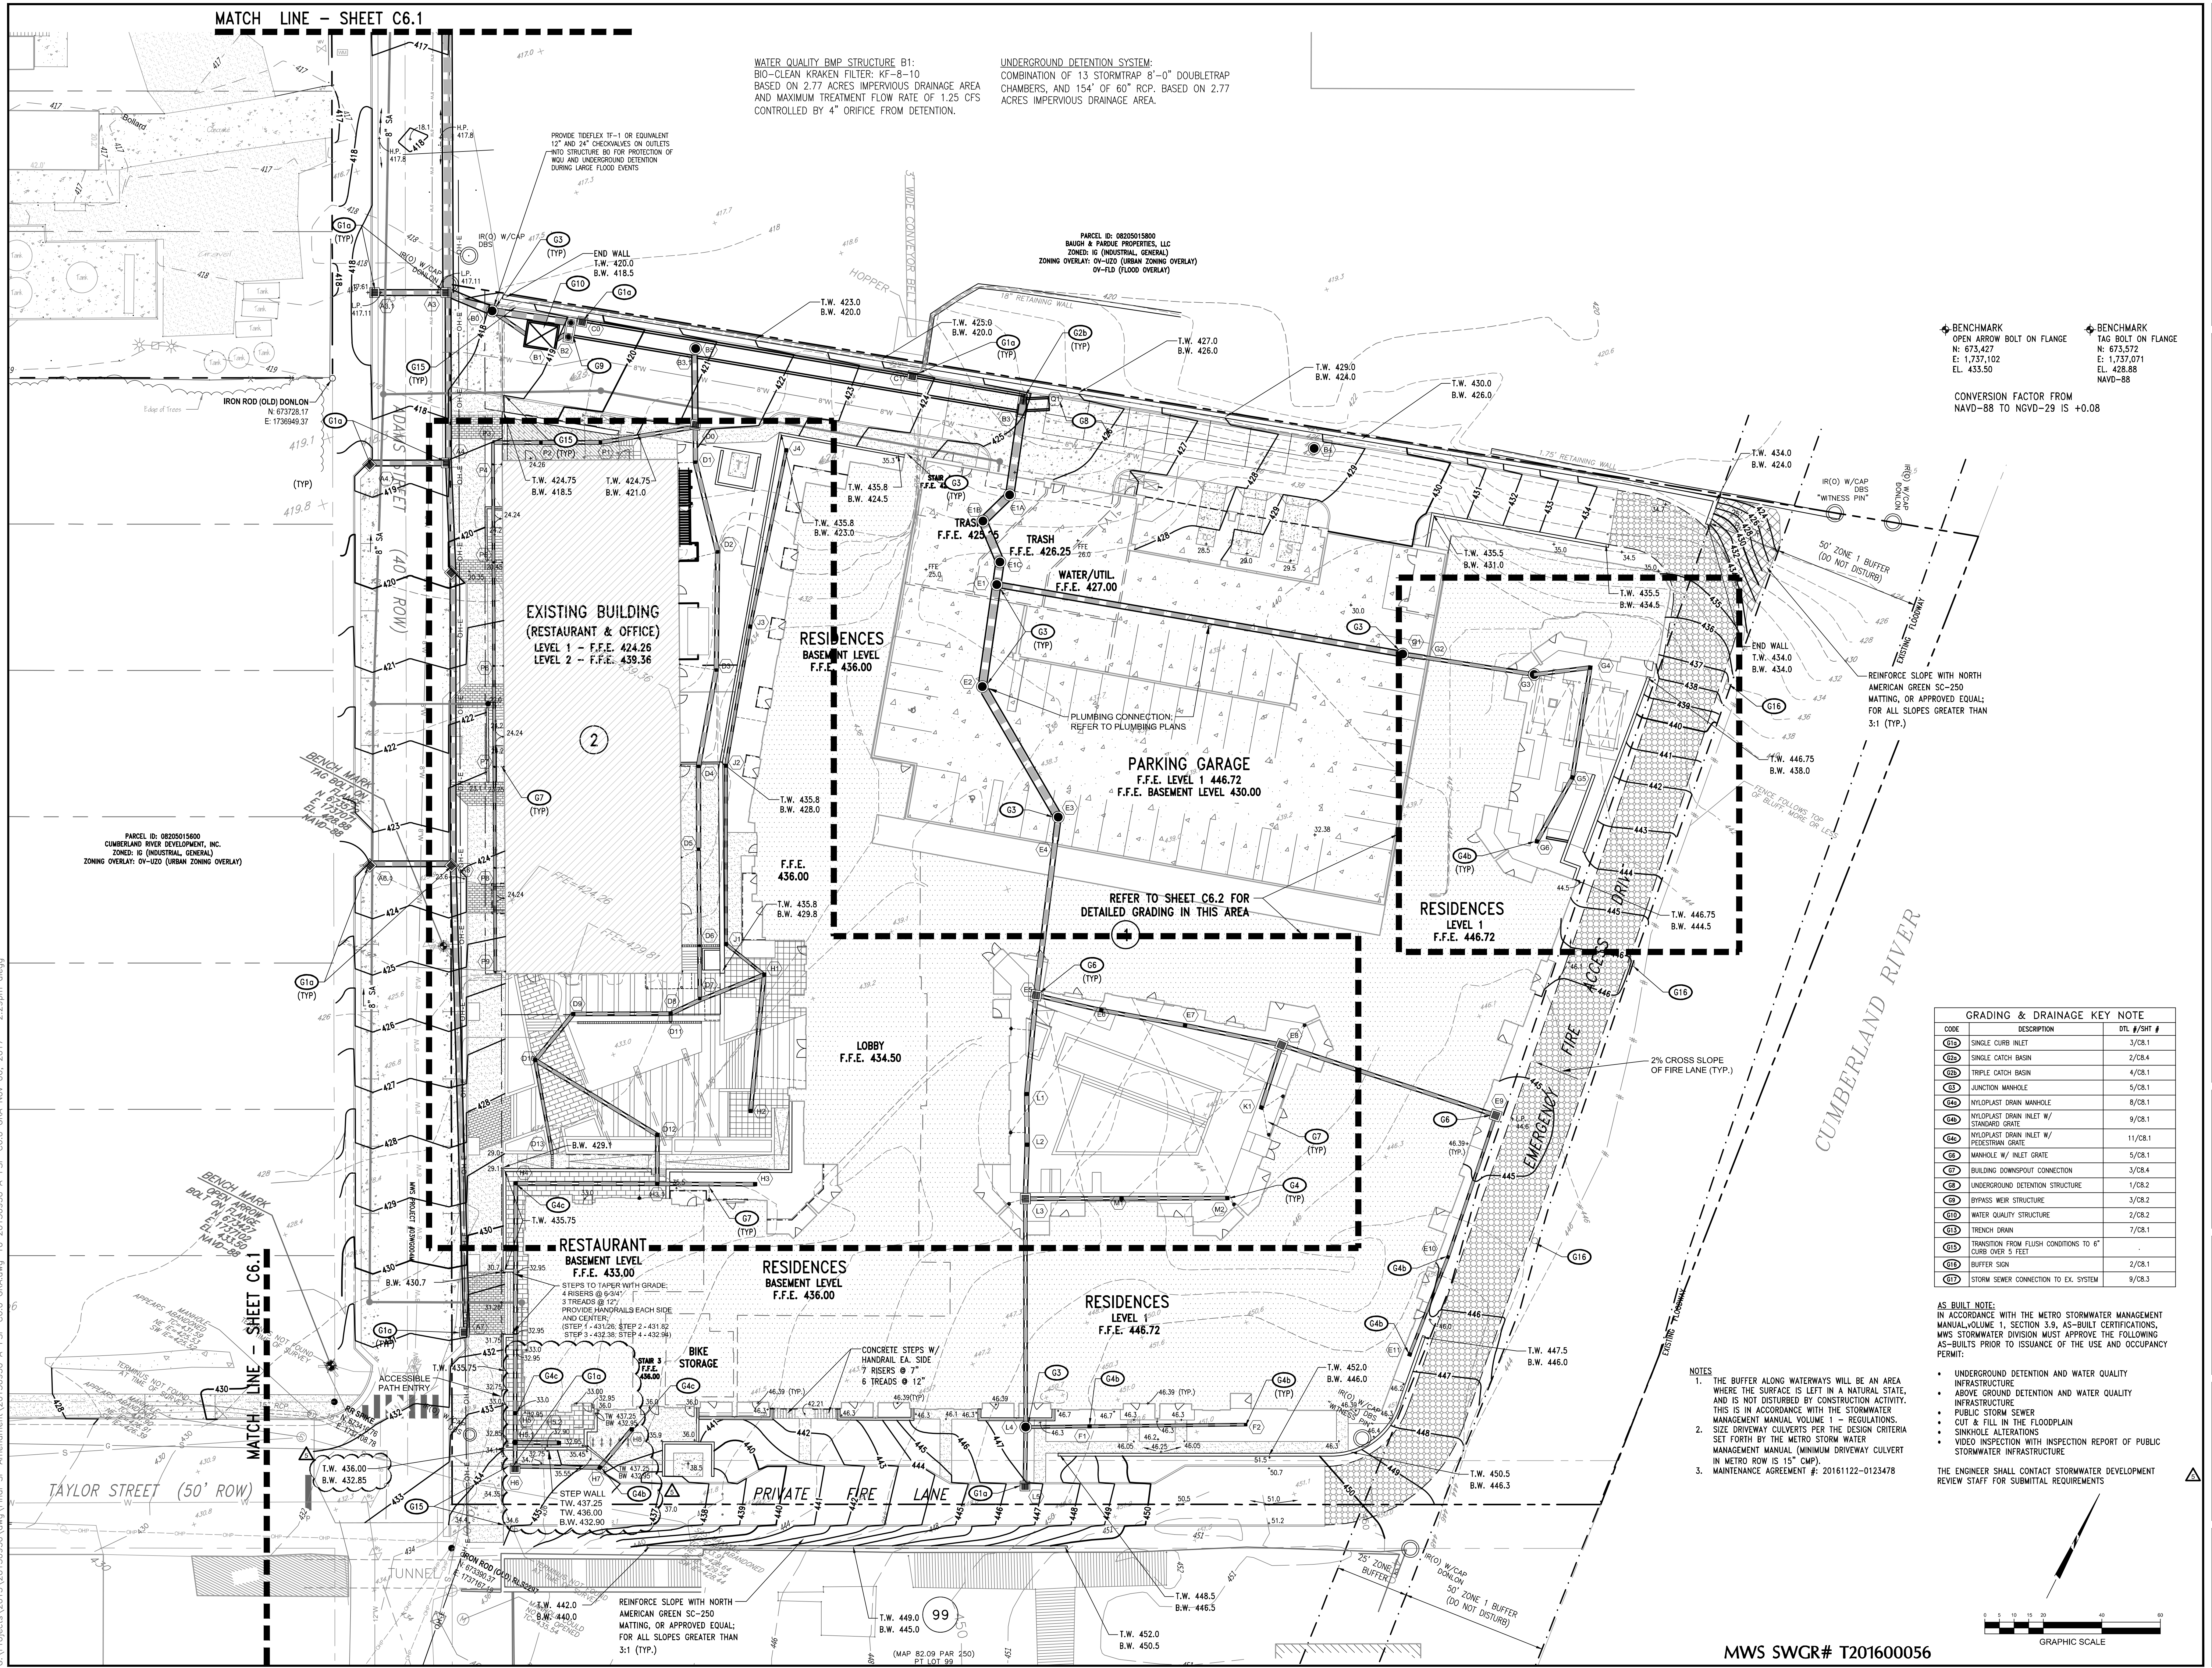

WATER QUALITY BMP STRUCTURE B1:
 BIO-CLEAN KRACKEN FILTER: KF-8-10
 BASED ON 2.77 ACRES IMPERVIOUS DRAINAGE AREA
 AND MAXIMUM TREATMENT FLOW RATE OF 1.25 CFS
 CONTROLLED BY 4" ORIFICE FROM DETENTION.

UNDERGROUND DETENTION SYSTEM:
 COMBINATION OF 13 STORMTRAP 8"-0" DOUBLETAP
 CHAMBERS, AND 154' OF 60" RCP, BASED ON 2.77
 ACRES IMPERVIOUS DRAINAGE AREA.

BENCHMARK
 OPEN ARROW BOLT ON FLANGE
 N: 673.427
 E: 1,737.102
 EL: 435.50

BENCHMARK
 TAG BOLT ON FLANGE
 N: 673.572
 E: 1,737.071
 EL: 428.88
 NAVD-88

CONVERSION FACTOR FROM
 NAVD-88 TO NGVD-29 IS +0.08

GRADING & DRAINAGE KEY NOTE



CODE	DESCRIPTION	DTL #/SHT #
G1A	SINGLE CURB INLET	3/CR.1
G2A	SINGLE CATCH BASIN	2/CR.4
G3A	TRIPLE CATCH BASIN	4/CR.1
G4A	JUNCTION MANHOLE	5/CR.1
G5A	NYLOPLAST DRAIN MANHOLE	8/CR.1
G6A	NYLOPLAST DRAIN INLET W/ STANDARD GRATE	9/CR.1
G7A	NYLOPLAST DRAIN INLET W/ PEDESTRIAN GRATE	11/CR.1
G8A	MANHOLE W/ INLET GRATE	5/CR.1
G9A	BUILDING DOWNSPOUT CONNECTION	3/CR.4
G10A	UNDERGROUND DETENTION STRUCTURE	1/CR.2
G11A	BYPASS WEIR STRUCTURE	3/CR.2
G12A	WATER QUALITY STRUCTURE	2/CR.2
G13A	TRENCH DRAIN	7/CR.1
G14A	TRANSITION FROM FLUSH CONDITIONS TO 6" CURB OVER 5 FEET	
G15A	BUFFER SIGN	2/CR.1
G16A	STORM SEWER CONNECTION TO EX. SYSTEM	9/CR.3

AS-BUILT NOTE:
 IN ACCORDANCE WITH THE METRO STORMWATER MANAGEMENT MANUAL, VOLUME 1, SECTION 3.8, AS-BUILT CERTIFICATIONS, MWS STORMWATER DIVISION MUST APPROVE THE FOLLOWING AS-BUILTS PRIOR TO ISSUANCE OF THE USE AND OCCUPANCY PERMIT:

- UNDERGROUND DETENTION AND WATER QUALITY INFRASTRUCTURE
- ABOVE GROUND DETENTION AND WATER QUALITY INFRASTRUCTURE
- PUBLIC STORM SEWER
- CUT & FILL IN THE FLOODPLAIN
- SINKHOLE ALTERATIONS
- VIDEO INSPECTION WITH INSPECTION REPORT OF PUBLIC STORMWATER INFRASTRUCTURE

THE ENGINEER SHALL CONTACT STORMWATER DEVELOPMENT REVIEW STAFF FOR SUBMITTAL REQUIREMENTS

- NOTES
1. THE BUFFER ALONG WATERWAYS WILL BE AN AREA WHERE THE SURFACE IS LEFT IN A NATURAL STATE, AND IS NOT DISTURBED BY CONSTRUCTION ACTIVITY. THIS IS IN ACCORDANCE WITH THE STORMWATER MANAGEMENT MANUAL, VOLUME 1 - REGULATIONS.
 2. SIZE DRIVEWAY CULVERTS PER THE DESIGN CRITERIA SET FORTH BY THE METRO STORMWATER MANAGEMENT MANUAL (MINIMUM DRIVEWAY CULVERT IN METRO ROW IS 15" CMP).
 3. MAINTENANCE AGREEMENT #: 20161122-0123478

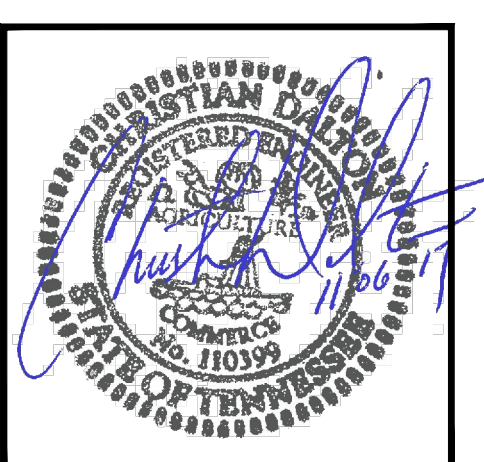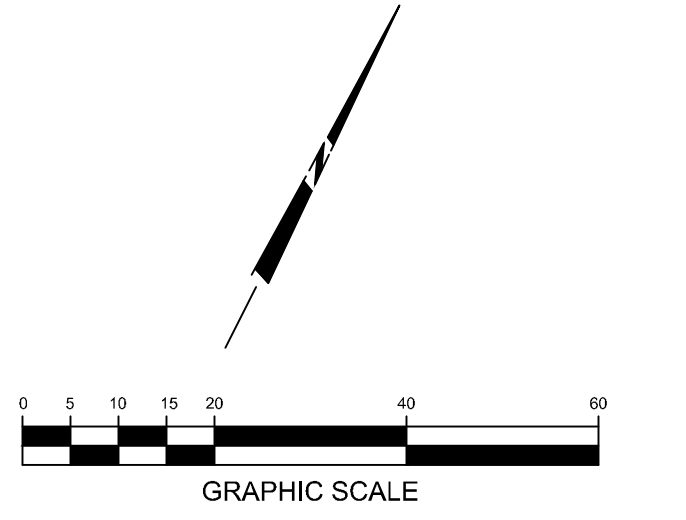

DATE	REVISIONS
2017.09.28	20150950

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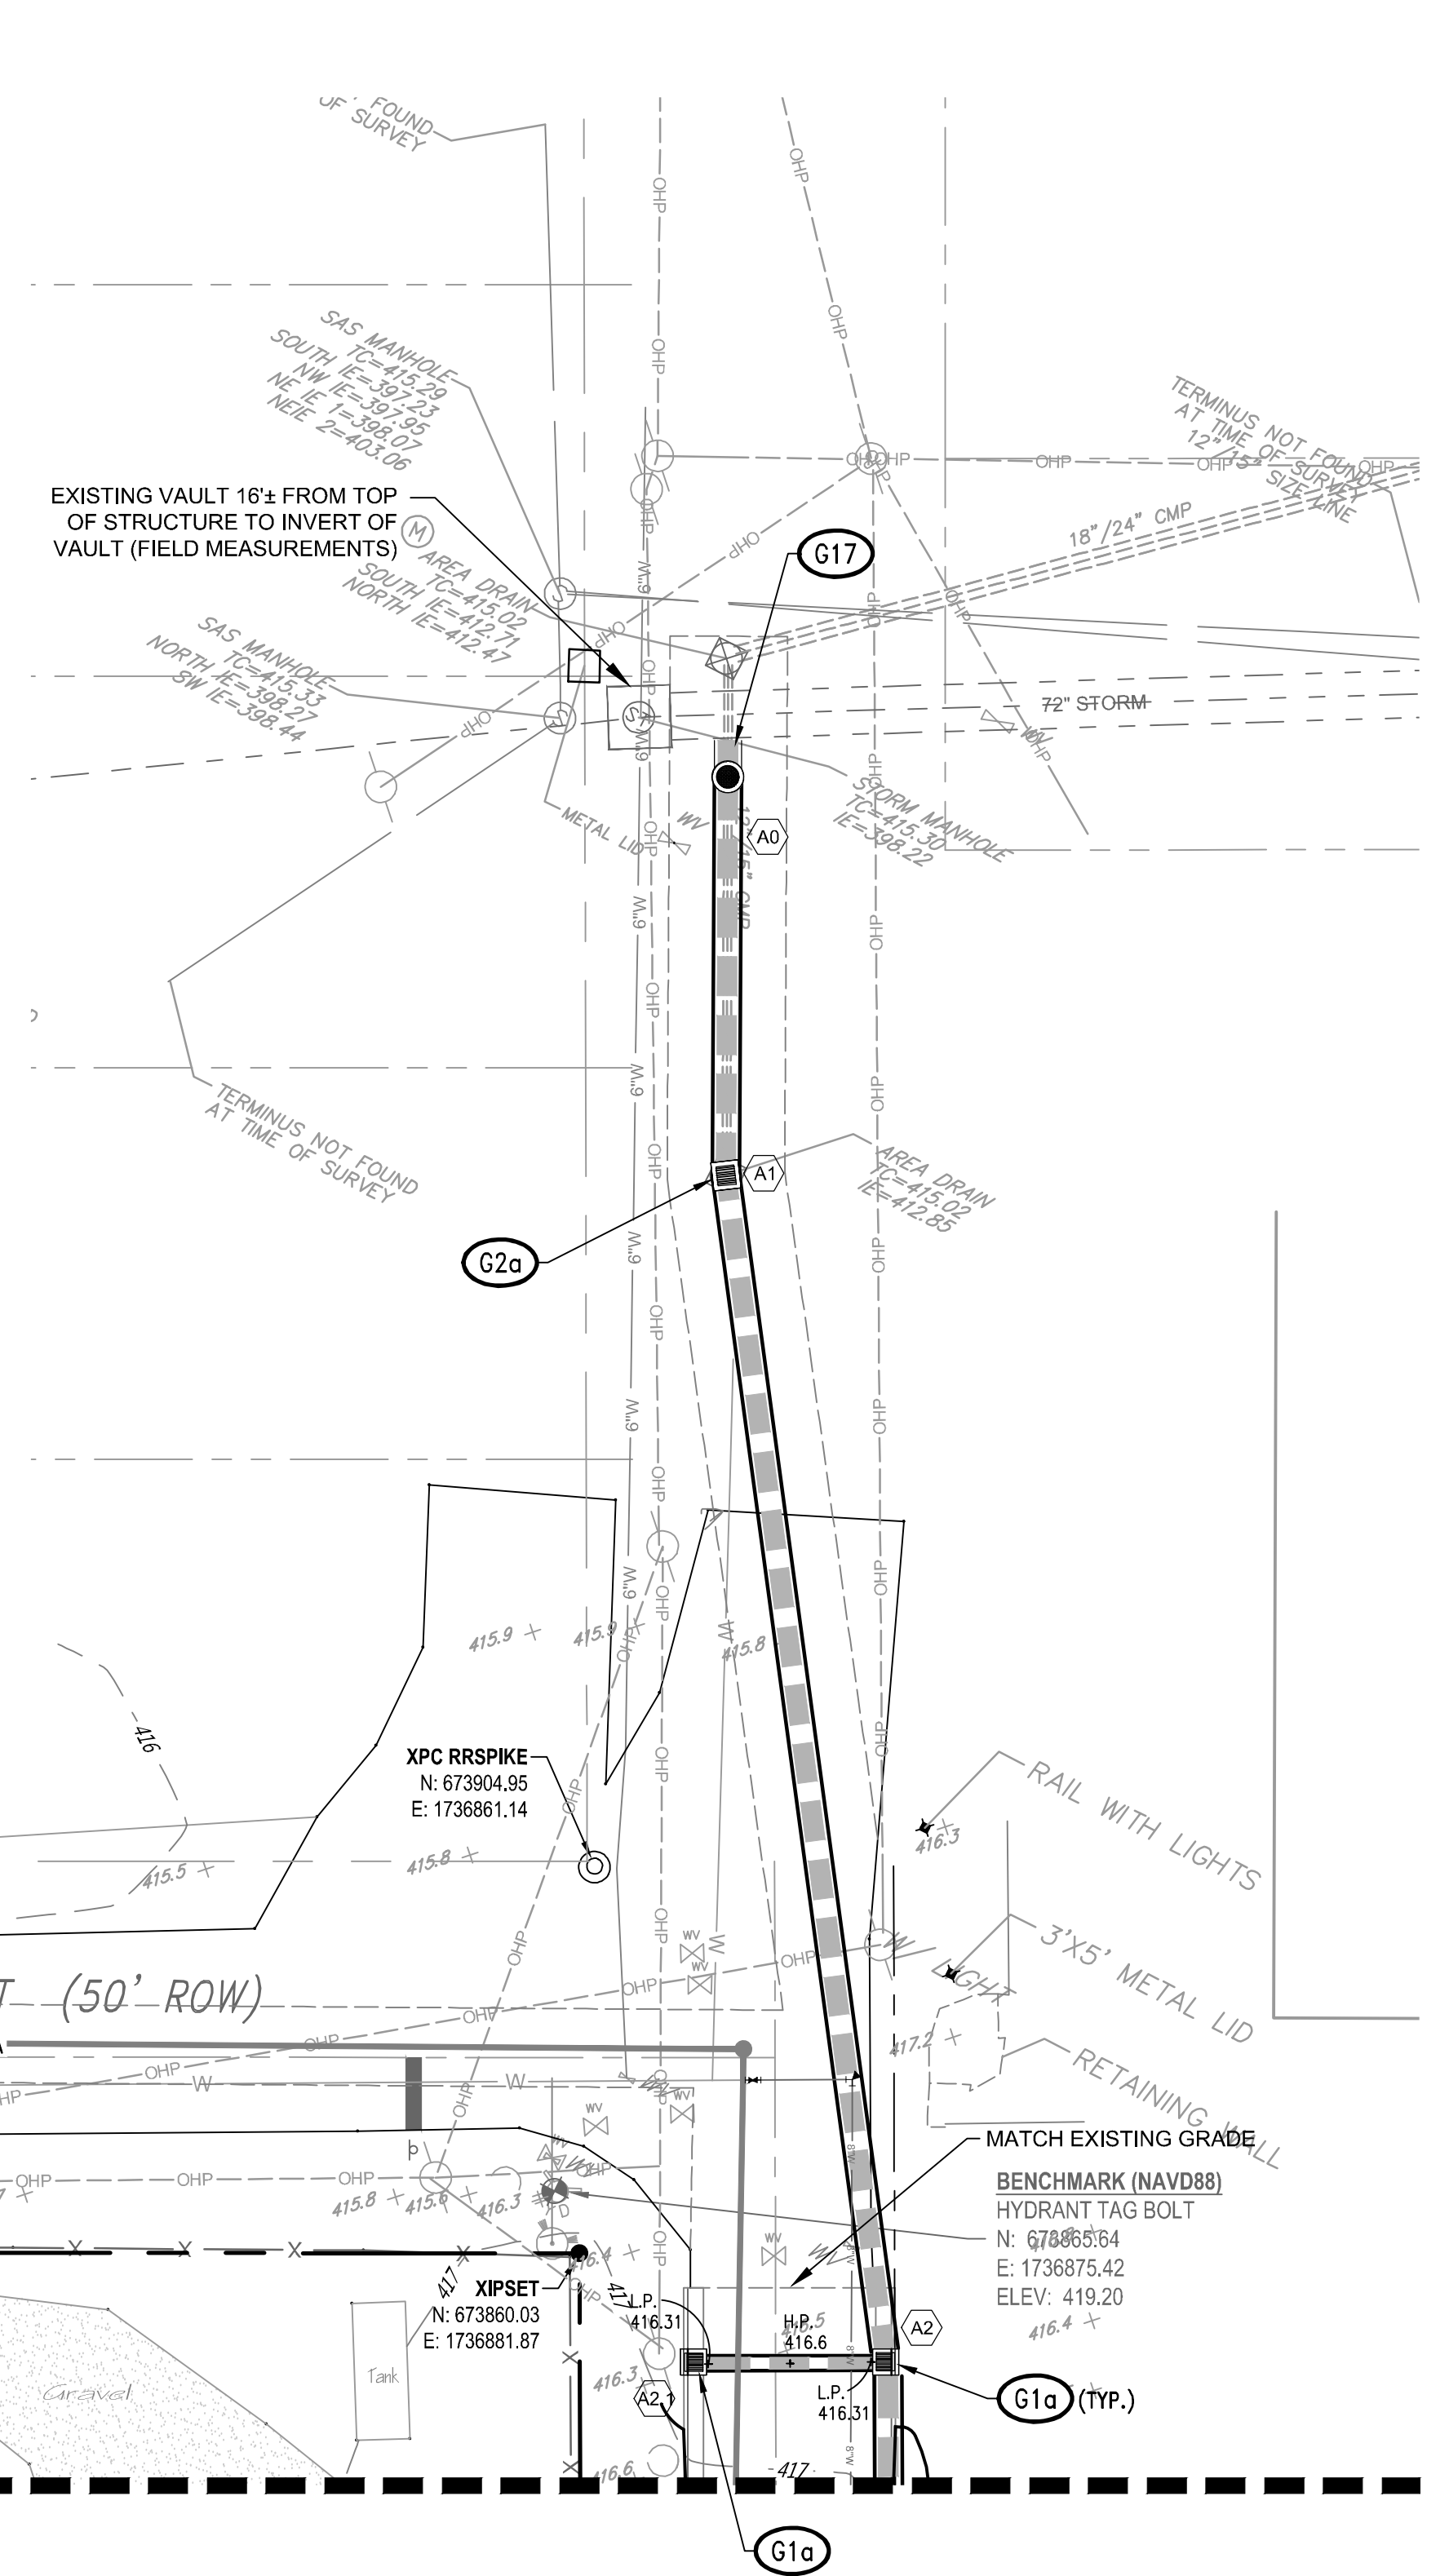
MWS SWGR# T201600056

PIPE TABLE							
FROM CODE	FROM INV	TO CODE	TO INV	GRADE (%)	SIZE (INCHES)	LENGTH (L.F.)	TYPE
A1	404.98	A0	404.68	0.59%	30"	48	RCP
A2	405.83	A1	404.98	0.56%	30"	150	RCP
A2.1	410.43	A2	409.93	2.32%	18"	22	RCP
A3	406.42	A2	405.83	0.57%	30"	102	RCP
A3.1	411.50	A3	411.00	1.93%	18"	23	RCP
A4	413.12	A3	411.61	2.59%	18"	55	RCP
A4.1	413.78	A4	413.40	1.38%	18"	24	RCP
A5	414.40	A4	413.12	3.46%	18"	33	RCP
A6	415.50	A5	414.40	1.10%	18"	96	RCP
A6.1	418.00	A6	417.90	0.34%	18"	27	RCP
A7	425.65	A6	418.15	4.68%	15"	158	RCP
B0	407.01	A3	406.92	0.58%	24"	13	RCP
B1	407.18	B0	407.11	0.50%	12"	12	HDPE
B2	409.69	B1	409.68	0.29%	12"	3	HDPE
B2	409.69	B0	409.09	2.29%	24"	24	HDPE
B3	410.00	B2	409.69	0.20%	60"	154	RCP
D0	415.70	B3.1	415.30	1.64%	15"	23	RCP
D1	418.70	D0	417.23	12.26%	15"	9	HDPE
D2	419.25	D1	418.76	1.55%	15"	28	HDPE
D3	419.76	D2	419.25	1.26%	15"	37	HDPE
D4	420.04	D3	419.76	0.84%	15"	30	HDPE
D5	420.25	D4	420.04	0.75%	15"	25	HDPE

PIPE TABLE							
FROM CODE	FROM INV	TO CODE	TO INV	GRADE (%)	SIZE (INCHES)	LENGTH (L.F.)	TYPE
D6	421.09	D5	420.50	1.82%	12"	30	HDPE
D7	421.97	D6	421.13	4.82%	12"	15	HDPE
D8	422.08	D7	421.97	1.00%	12"	8	HDPE
D9	422.72	D8	422.41	0.93%	12"	30	HDPE
D10	423.00	D9	422.72	1.37%	12"	16	HDPE
D11	425.00	D8	422.00	115.56%	8"	2	HDPE
D12	423.49	D10	423.00	1.00%	12"	45	HDPE
D13	426.00	D10	423.00	9.21%	8"	30	HDPE
E1	420.03	E1c	419.42	7.47%	24"	4	RCP
E1a	417.69	B3	415.36	7.47%	24"	25	RCP
E1b	418.47	E1a	417.69	6.12%	24"	9	RCP
E1c	419.42	E1b	418.47	6.25%	24"	11	RCP
E2	420.95	E1	420.00	2.84%	24"	31	RCP
E3	421.50	E2	421.04	0.93%	24"	48	RCP
E4	422.20	E3	422.00	2.51%	18"	6	RCP
E5	439.50	E4	433.25	11.71%	18"	52	DIP
E6	441.30	E5	441.00	1.31%	12"	20	HDPE
E7	441.70	E6	441.30	1.37%	12"	26	HDPE
E8	442.20	E7	441.70	1.49%	12"	31	HDPE
E9	442.90	E8	442.20	0.91%	12"	74	DIP
E10	443.50	E9	443.23	0.53%	8"	48	HDPE
E11	443.70	E10	443.50	0.56%	8"	33	HDPE

PIPE TABLE							
FROM CODE	FROM INV	TO CODE	TO INV	GRADE (%)	SIZE (INCHES)	LENGTH (L.F.)	TYPE
F1	442.70	L4	442.40	1.37%	8"	18	HDPE
F2	443.00	F1	442.70	0.56%	8"	50	HDPE
G1	426.50	E1	420.78	4.07%	15"	137	RCP
G2	427.00	G1	426.75	3.30%	12"	6	RCP
G3	441.00	G2	435.50	14.50%	12"	36	DIP
G4	441.30	G3	441.10	1.04%	12"	16	HDPE
G5	441.85	G4	441.50	0.92%	12"	35	HDPE
G6	442.45	G5	442.05	1.60%	12"	22	HDPE
H1	422.50	D7	422.00	2.11%	12"	20	HDPE
H2	429.85	H1	429.60	0.53%	12"	44	HDPE
H3	430.00	H3.1	425.00	14.95%	12"	30	HDPE
H3.1	424.80	D12	423.50	7.79%	12"	14	HDPE
H4	429.10	H3.1	425.00	8.48%	12"	45	HDPE
H5	429.48	H4	429.10	0.48%	12"	76	HDPE
H5.1	429.53	H5	429.48	0.50%	12"	7	HDPE
H5.2	429.64	H5.1	429.53	0.74%	12"	11	HDPE
H6	429.57	H5.1	429.53	0.49%	12"	6	HDPE
H7	432.35	H6	429.53	9.72%	12"	29	HDPE
H8	433.00	H7	432.35	3.83%	12"	14	HDPE
J1	430.80	H1	429.60	7.18%	8"	13	HDPE
J2	431.10	J1	430.80	0.49%	8"	58	HDPE
J3	431.40	J2	431.10	0.62%	8"	45	HDPE

PIPE TABLE							
FROM CODE	FROM INV	TO CODE	TO INV	GRADE (%)	SIZE (INCHES)	LENGTH (L.F.)	TYPE
J4	431.80	J3	431.40	0.65%	8"	58	HDPE
K1	442.50	E8	442.20	1.34%	12"	19	HDPE
L1	440.25	E5	439.75	1.48%	15"	31	HDPE
L2	440.50	L1	440.25	1.44%	15"	14	HDPE
L3	440.75	L2	440.50	1.35%	15"	15	HDPE
L4	442.00	L3	441.00	1.28%	12"	75	DIP
L5	442.50	L4	442.00	2.58%	12"	16	HDPE
M1	441.40	L3	441.00	1.22%	12"	30	HDPE
M2	441.80	M1	441.40	1.11%	12"	35	HDPE
N2	407.50	N1	406.84	2.94%	18"	20	RCP
P1	416.12	D0	415.95	0.52%	12"	30	HDPE
P2	416.25	P1	416.12	0.64%	12"	17	HDPE
P3	416.42	P2	416.25	1.04%	12"	13	HDPE
P4	417.02	P3	416.75	3.60%	8"	3	HDPE
P5	418.22	P4	417.02	3.58%	8"	30	HDPE
P6	419.49	P5	418.22	3.59%	8"	31	HDPE
P7	420.73	P6	419.49	3.59%	8"	31	HDPE
P8	421.97	P7	420.73	3.59%	8"	31	HDPE
P9	423.25	P8	421.97	3.60%	8"	32	HDPE
Q1	410.00	B3	410.00	0.00%	42"	7	RCP



STRUCTURE TABLE		
CODE	DESCRIPTION	TOP GRATE
A0	EXISTING STORM TIE-IN STRUCTURE	415.30
A1	SINGLE CATCH BASIN	415.02
A2	SINGLE CURB INLET	416.31
A2.1	SINGLE CURB INLET	416.31
A3	SINGLE CURB INLET	417.11
A3.1	SINGLE CURB INLET	417.11
A4	SINGLE CURB INLET	418.62
A4.1	SINGLE CURB INLET	418.70
A5	SINGLE CURB INLET	419.90
A6	SINGLE CURB INLET	423.40
A6.1	SINGLE CURB INLET	423.50
A7	SINGLE CURB INLET	430.90
B0	JUNCTION BOX	418.10
B1	WATER QUALITY UNIT	419.00
B2	BYPASS WEIR STRUCTURE	419.63
B3	TRIPLE CATCH BASIN W/ SOLID MH COVER	425.00
B3.1	CONNECTION	N/A
B4	ACCESS MANHOLE	428.61
B5	ACCESS MANHOLE	420.96
C0	SINGLE CURB INLET	419.20


STRUCTURE TABLE		
CODE	DESCRIPTION	TOP GRATE
C1	SINGLE CURB INLET	423.70
D0	SINGLE CURB INLET	421.20
D1	12" HDPE INLET	423.00
D2	12" HDPE INLET	423.90
D3	12" HDPE INLET	424.00
D4	12" HDPE INLET	424.20
D5	12" HDPE INLET	424.00
D6	TRENCH DRAIN	424.10
D7	12" HDPE INLET (SOLID)	428.35
D8	12" HDPE INLET	428.20
D9	12" HDPE INLET	428.22
D10	12" HDPE INLET	430.05
D11	JUNCTION BOX	430.20
D12	12" HDPE INLET	431.55
D13	TRENCH DRAIN	429.70
E1	MANHOLE	426.00
E1a	JUNCTION BOX	425.25
E1b	JUNCTION BOX	425.25
E1c	JUNCTION BOX	N/A
E2	MANHOLE	435.00

STRUCTURE TABLE		
CODE	DESCRIPTION	TOP GRATE
E3	MANHOLE	435.00
E4	PLUMBING CONNECTION	435.46
E5	SINGLE CATCH BASIN	445.30
E6	12" HDPE INLET	445.00
E7	12" HDPE INLET	445.00
E8	SINGLE CATCH BASIN	446.08
E9	SINGLE CATCH BASIN	446.88
E10	12" HDPE INLET	445.50
E11	12" HDPE INLET	445.80
F1	12" HDPE INLET	445.50
F2	12" HDPE INLET	445.50
G1	MANHOLE	430.92
G2	PLUMBING CONNECTION	437.04
G3	MANHOLE W/ INLET GRATE	445.50
G4	12" HDPE INLET	445.40
G5	12" HDPE INLET	445.75
G6	12" HDPE INLET	445.50
H1	12" HDPE INLET	434.20
H2	12" HDPE INLET	434.10
H3	12" HDPE INLET	431.13


STRUCTURE TABLE		
CODE	DESCRIPTION	TOP GRATE
H3.1	12" HDPE INLET	432.75
H4	12" HDPE INLET	430.23
H5	12" HDPE INLET *	432.85
H5.1	CLEANOUT	432.50
H5.2	12" HDPE INLET	432.90
H6	SINGLE CURB INLET	434.15
H7	12" HDPE INLET	435.90
H8	12" HDPE INLET	435.55
J1	12" HDPE INLET	434.55
J2	12" HDPE INLET	435.35
J3	12" HDPE INLET	435.20
J4	12" HDPE INLET	434.70
K1	12" HDPE INLET	445.25
L1	12" HDPE INLET	445.30
L2	12" HDPE INLET	445.35
L3	SINGLE CATCH BASIN	445.00
L4	JUNCTION MANHOLE	446.40
L5	SINGLE CURB INLET	446.50
M1	12" HDPE INLET	445.00
M2	12" HDPE INLET	445.00

STRUCTURE TABLE		
CODE	DESCRIPTION	TOP GRATE
N1	EXIST INLET	414.84
N2	SINGLE CURB INLET	415.60
P1	12" HDPE INLET	424.10
P2	12" HDPE INLET	424.10
P3	12" HDPE INLET (SOLID)	419.79
P4	ROOF DRAIN CONNECTION	420.06
P5	ROOF DRAIN CONNECTION	421.27
P6	ROOF DRAIN CONNECTION	422.54
P7	ROOF DRAIN CONNECTION	423.78
P8	ROOF DRAIN CONNECTION	425.02
P9	ROOF DRAIN CONNECTION	426.29
Q1	STORMTRAP BOXES	414.32

* NOTE: 12" HDPE INLETS WITHIN PATIOPAYER AREAS SHALL BE PEDESTRIAN/ADA COMPLIANT MODEL NDS #1214 MANGANESE BRONZE



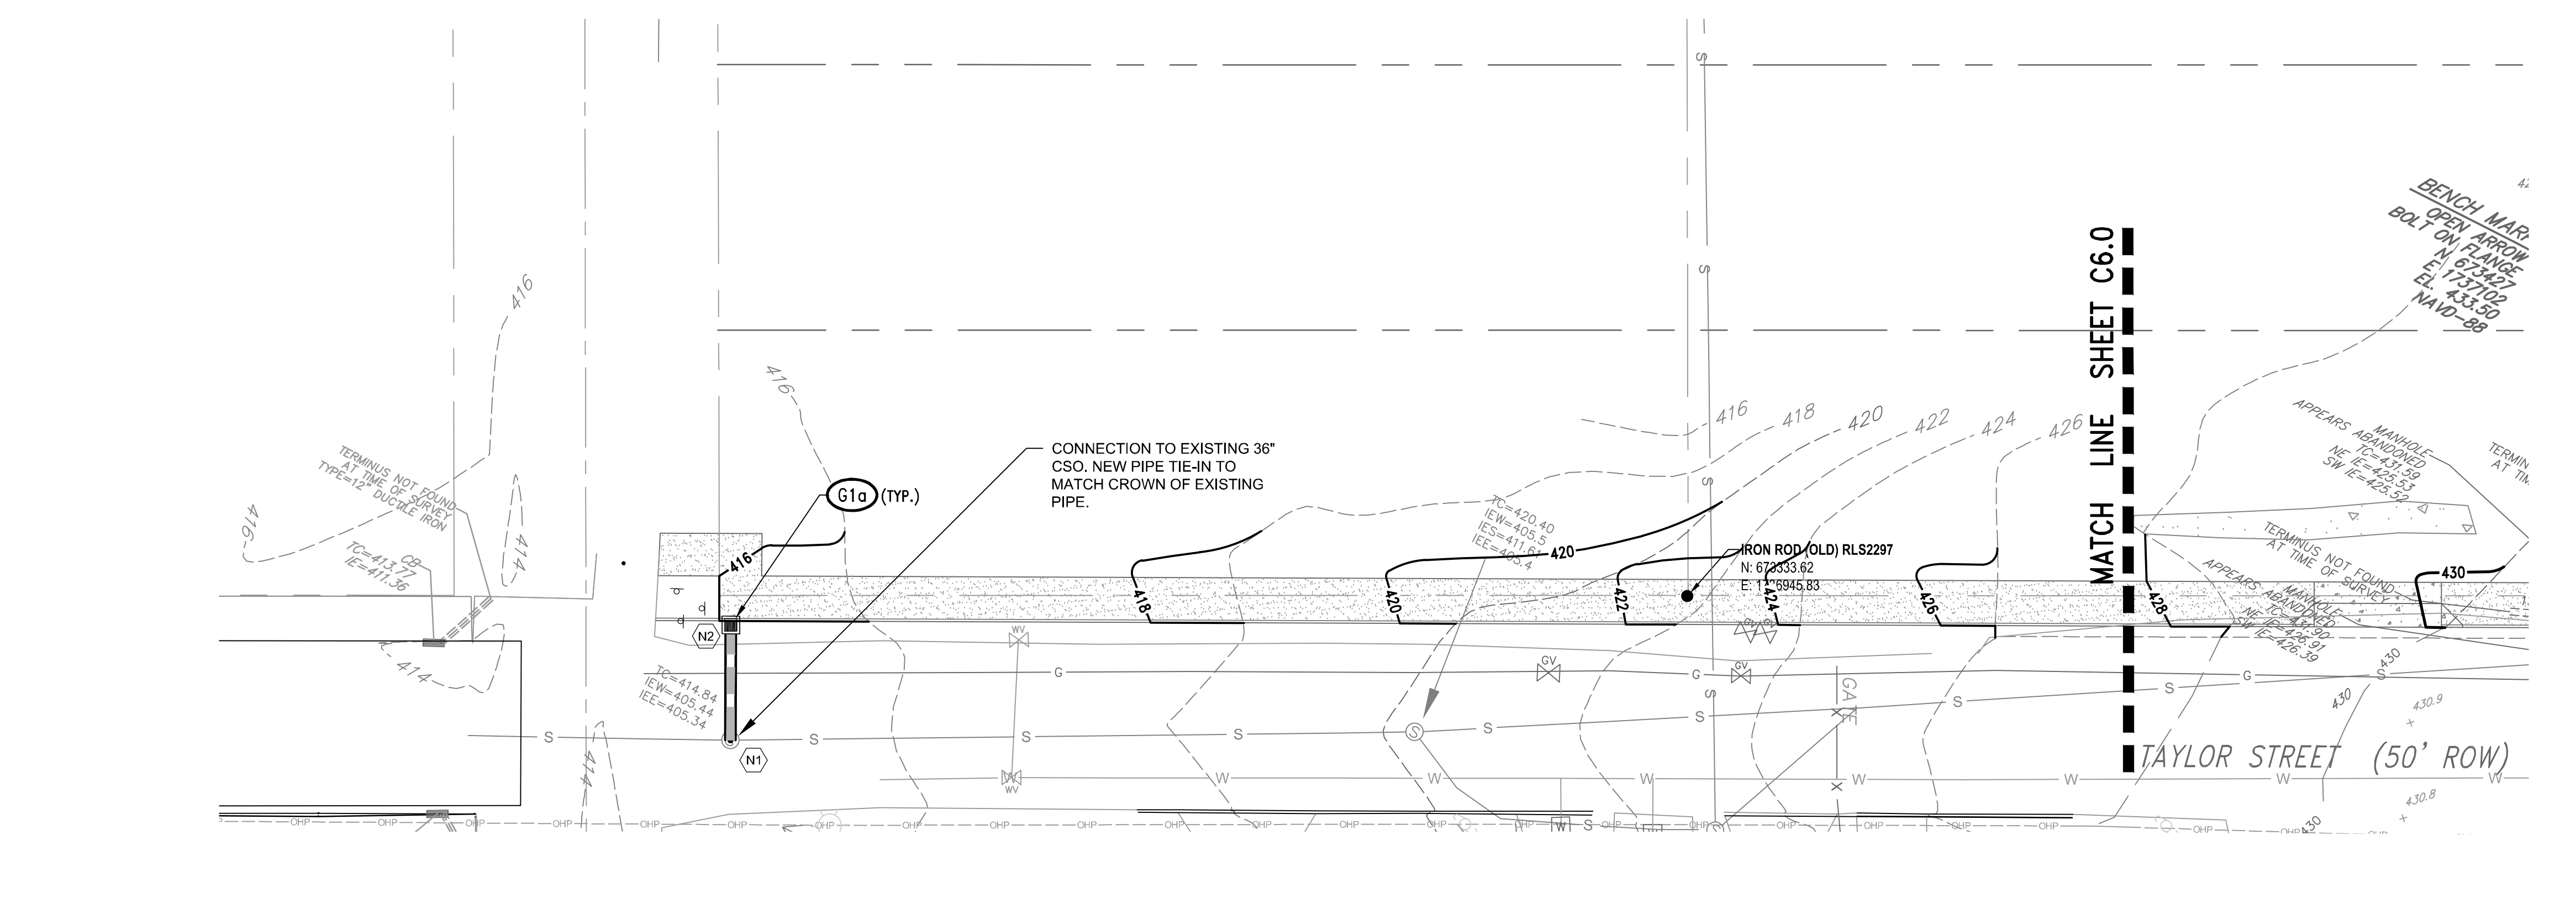


GRADING & DRAINAGE KEY NOTE		
CODE	DESCRIPTION	DTL #/SHT #
G10	SINGLE CURB INLET	3/CB.1
G20	SINGLE CATCH BASIN	2/CB.4
G30	TRIPLE CATCH BASIN	4/CB.1
G40	JUNCTION MANHOLE	5/CB.1
G50	NYLOPLAST DRAIN MANHOLE	8/CB.1
G60	NYLOPLAST DRAIN INLET W/ STANDARD GRATE	9/CB.1
G70	MANHOLE W/ INLET GRATE	11/CB.1
G80	MANHOLE W/ INLET GRATE	5/CB.1
G90	BUILDING DOWNSPOUT CONNECTION	3/CB.4
G100	UNDERGROUND DETENTION STRUCTURE	1/CB.2
G110	BYPASS WEIR STRUCTURE	3/CB.2
G120	WATER QUALITY STRUCTURE	2/CB.2
G130	TRENCH DRAIN	7/CB.1
G140	TRANSITION FROM FLUSH CONDITIONS TO 6" CURB OVER 5' FEET	.
G150	BUFFER SIGN	2/CB.1
G160	STORM SEWER CONNECTION TO EX. SYSTEM	9/CB.3

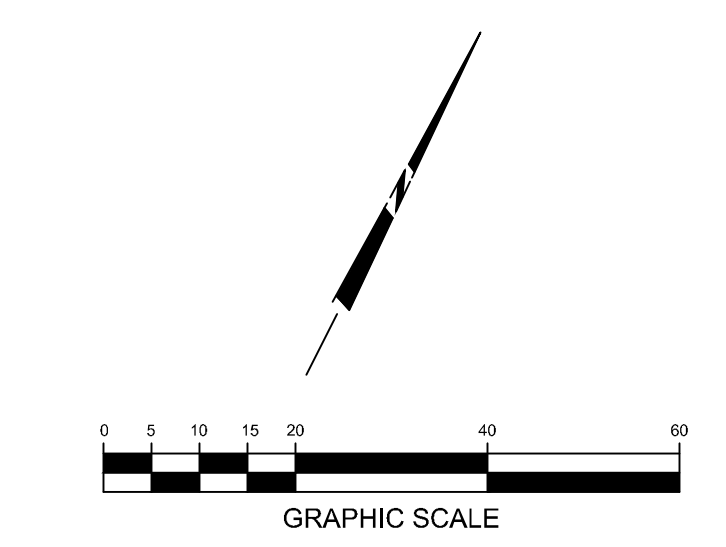

DATE	REVISIONS
2017.10.20	REVISION 5
2017.09.28	20150950



G:\Projects\2015\20150950\Final SP Amendment\20150950 A-FSP C6.0 GRA.dwg-11_20150950 A-FSP C6.1 GRA Nov. 06, 2017 - 2:29pm alegg

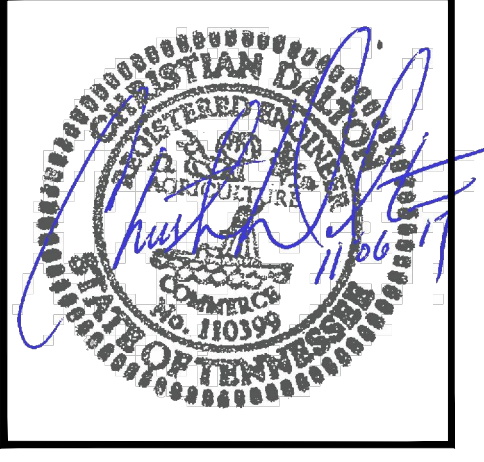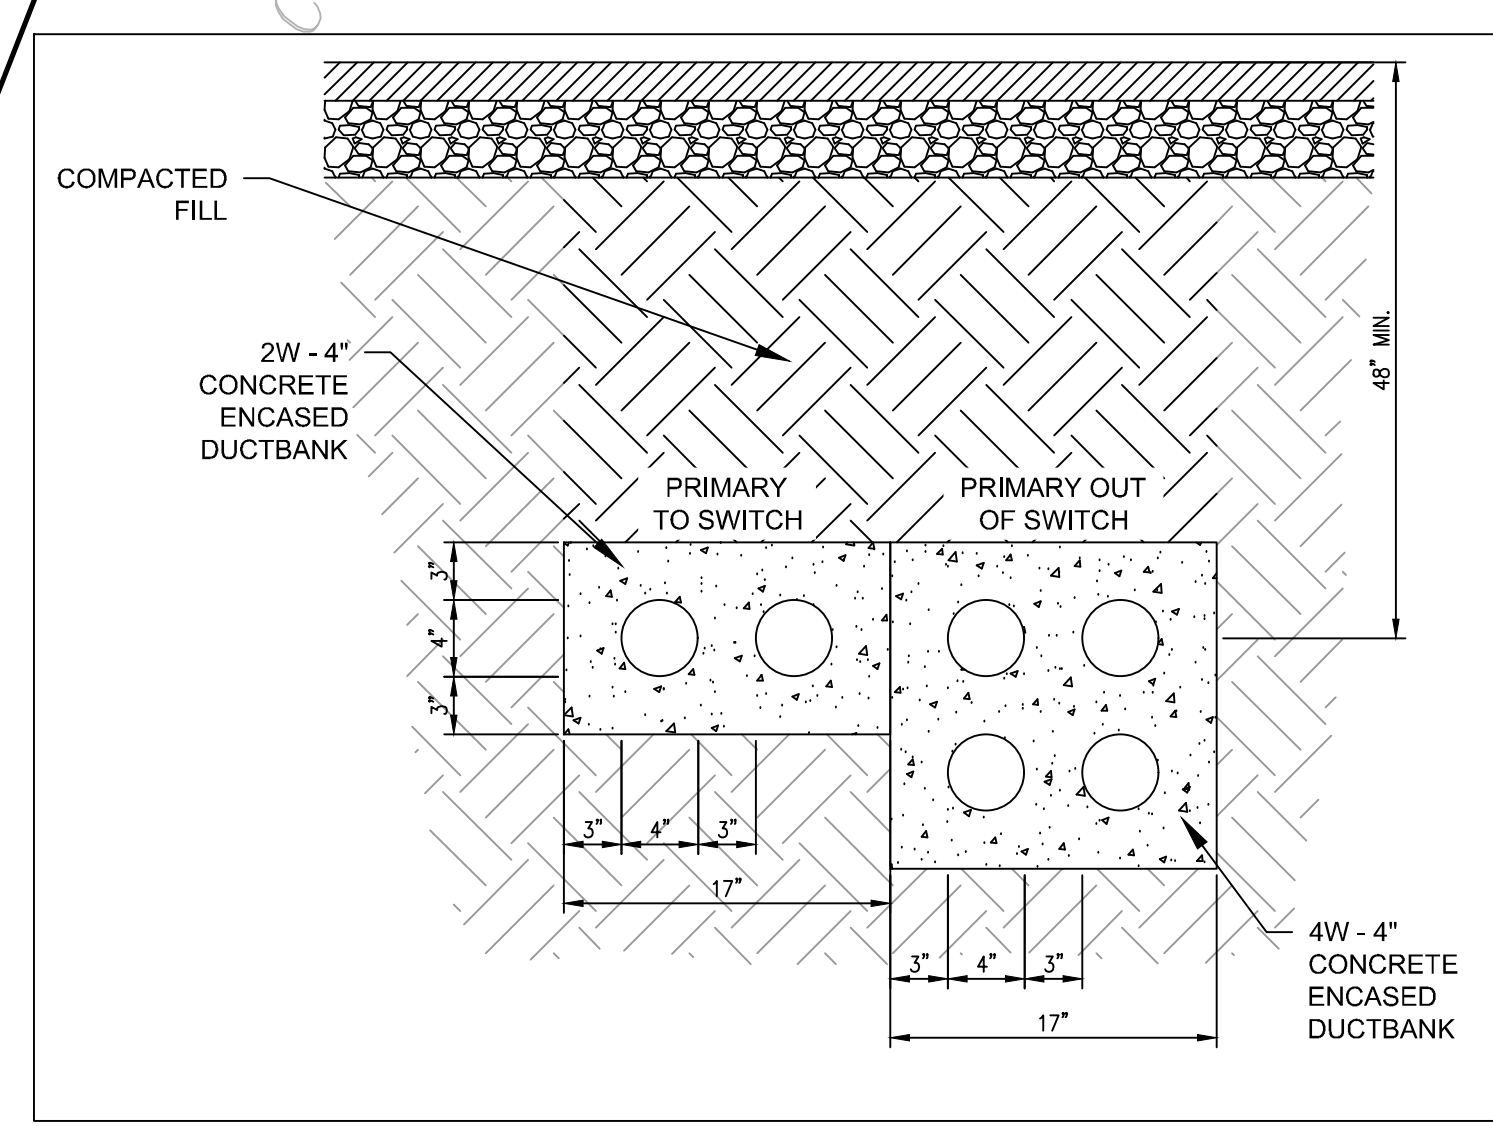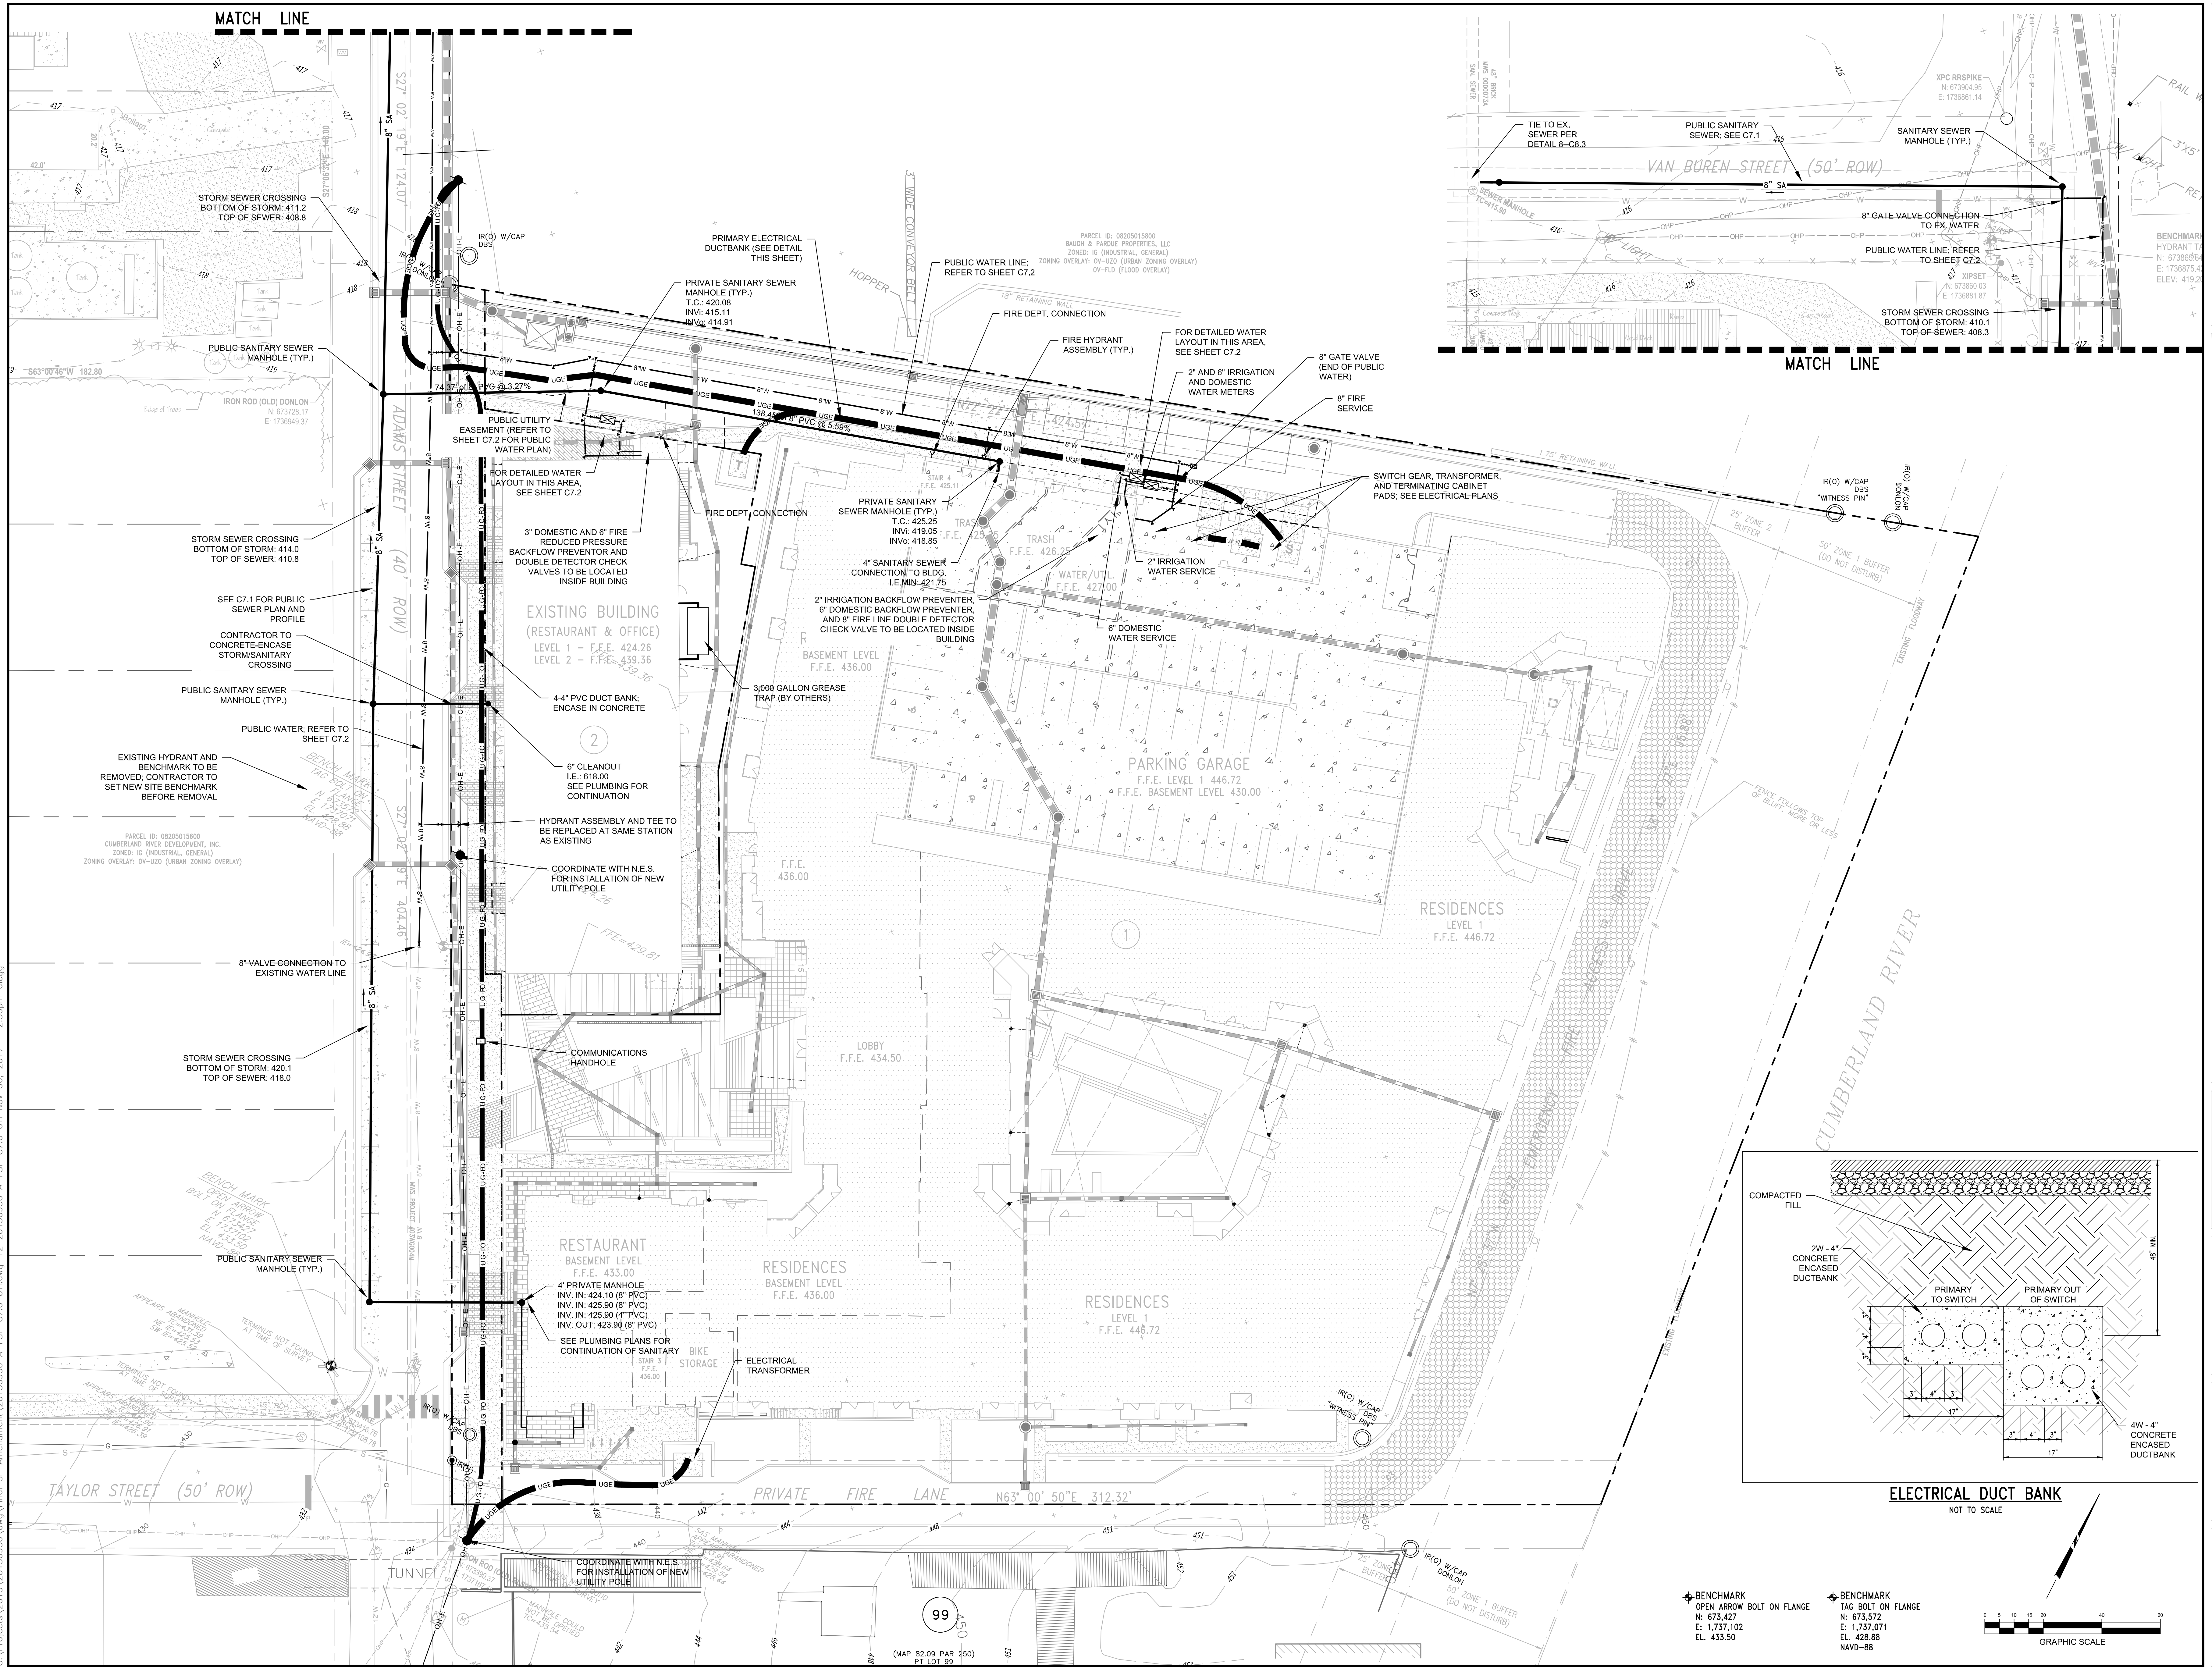

DATE	REVISIONS
2017.09.28	20150950

G:\Projects\2015\20150950\dwg\Final SP Amendment\20150950 A-FSP C7.0 UT.dwg--12 20150950 A-FSP C7.0 UT Nov 06, 2017 - 2:30pm aleg

G:\Projects\2015\20150950\wg\Final SP Amendment\20150950 A-FSP C7.2 UTI.dwg - 14 20150950 A-FSP C7.2 PUBLIC WATER Nov. 06, 2017 - 2:33pm alleg

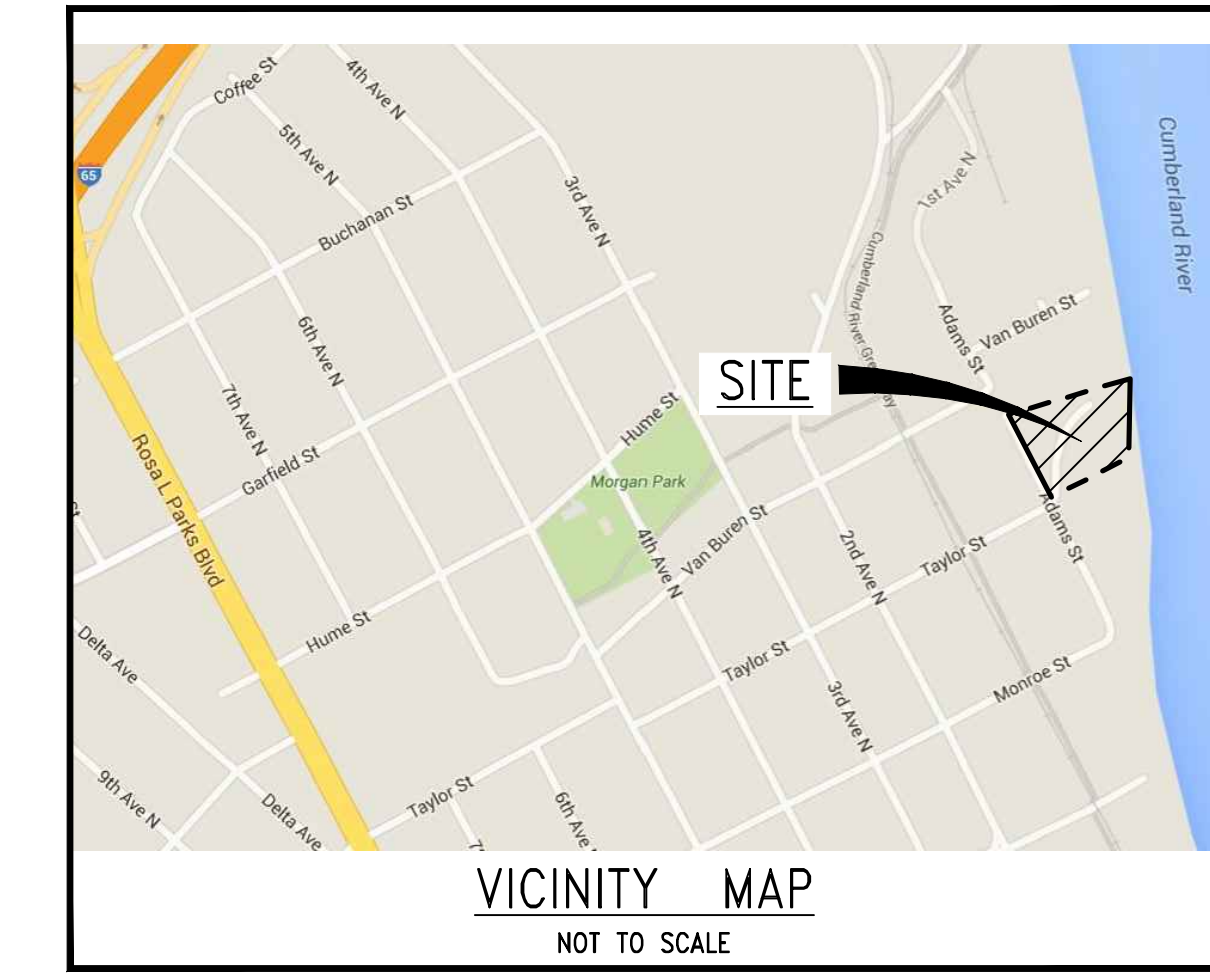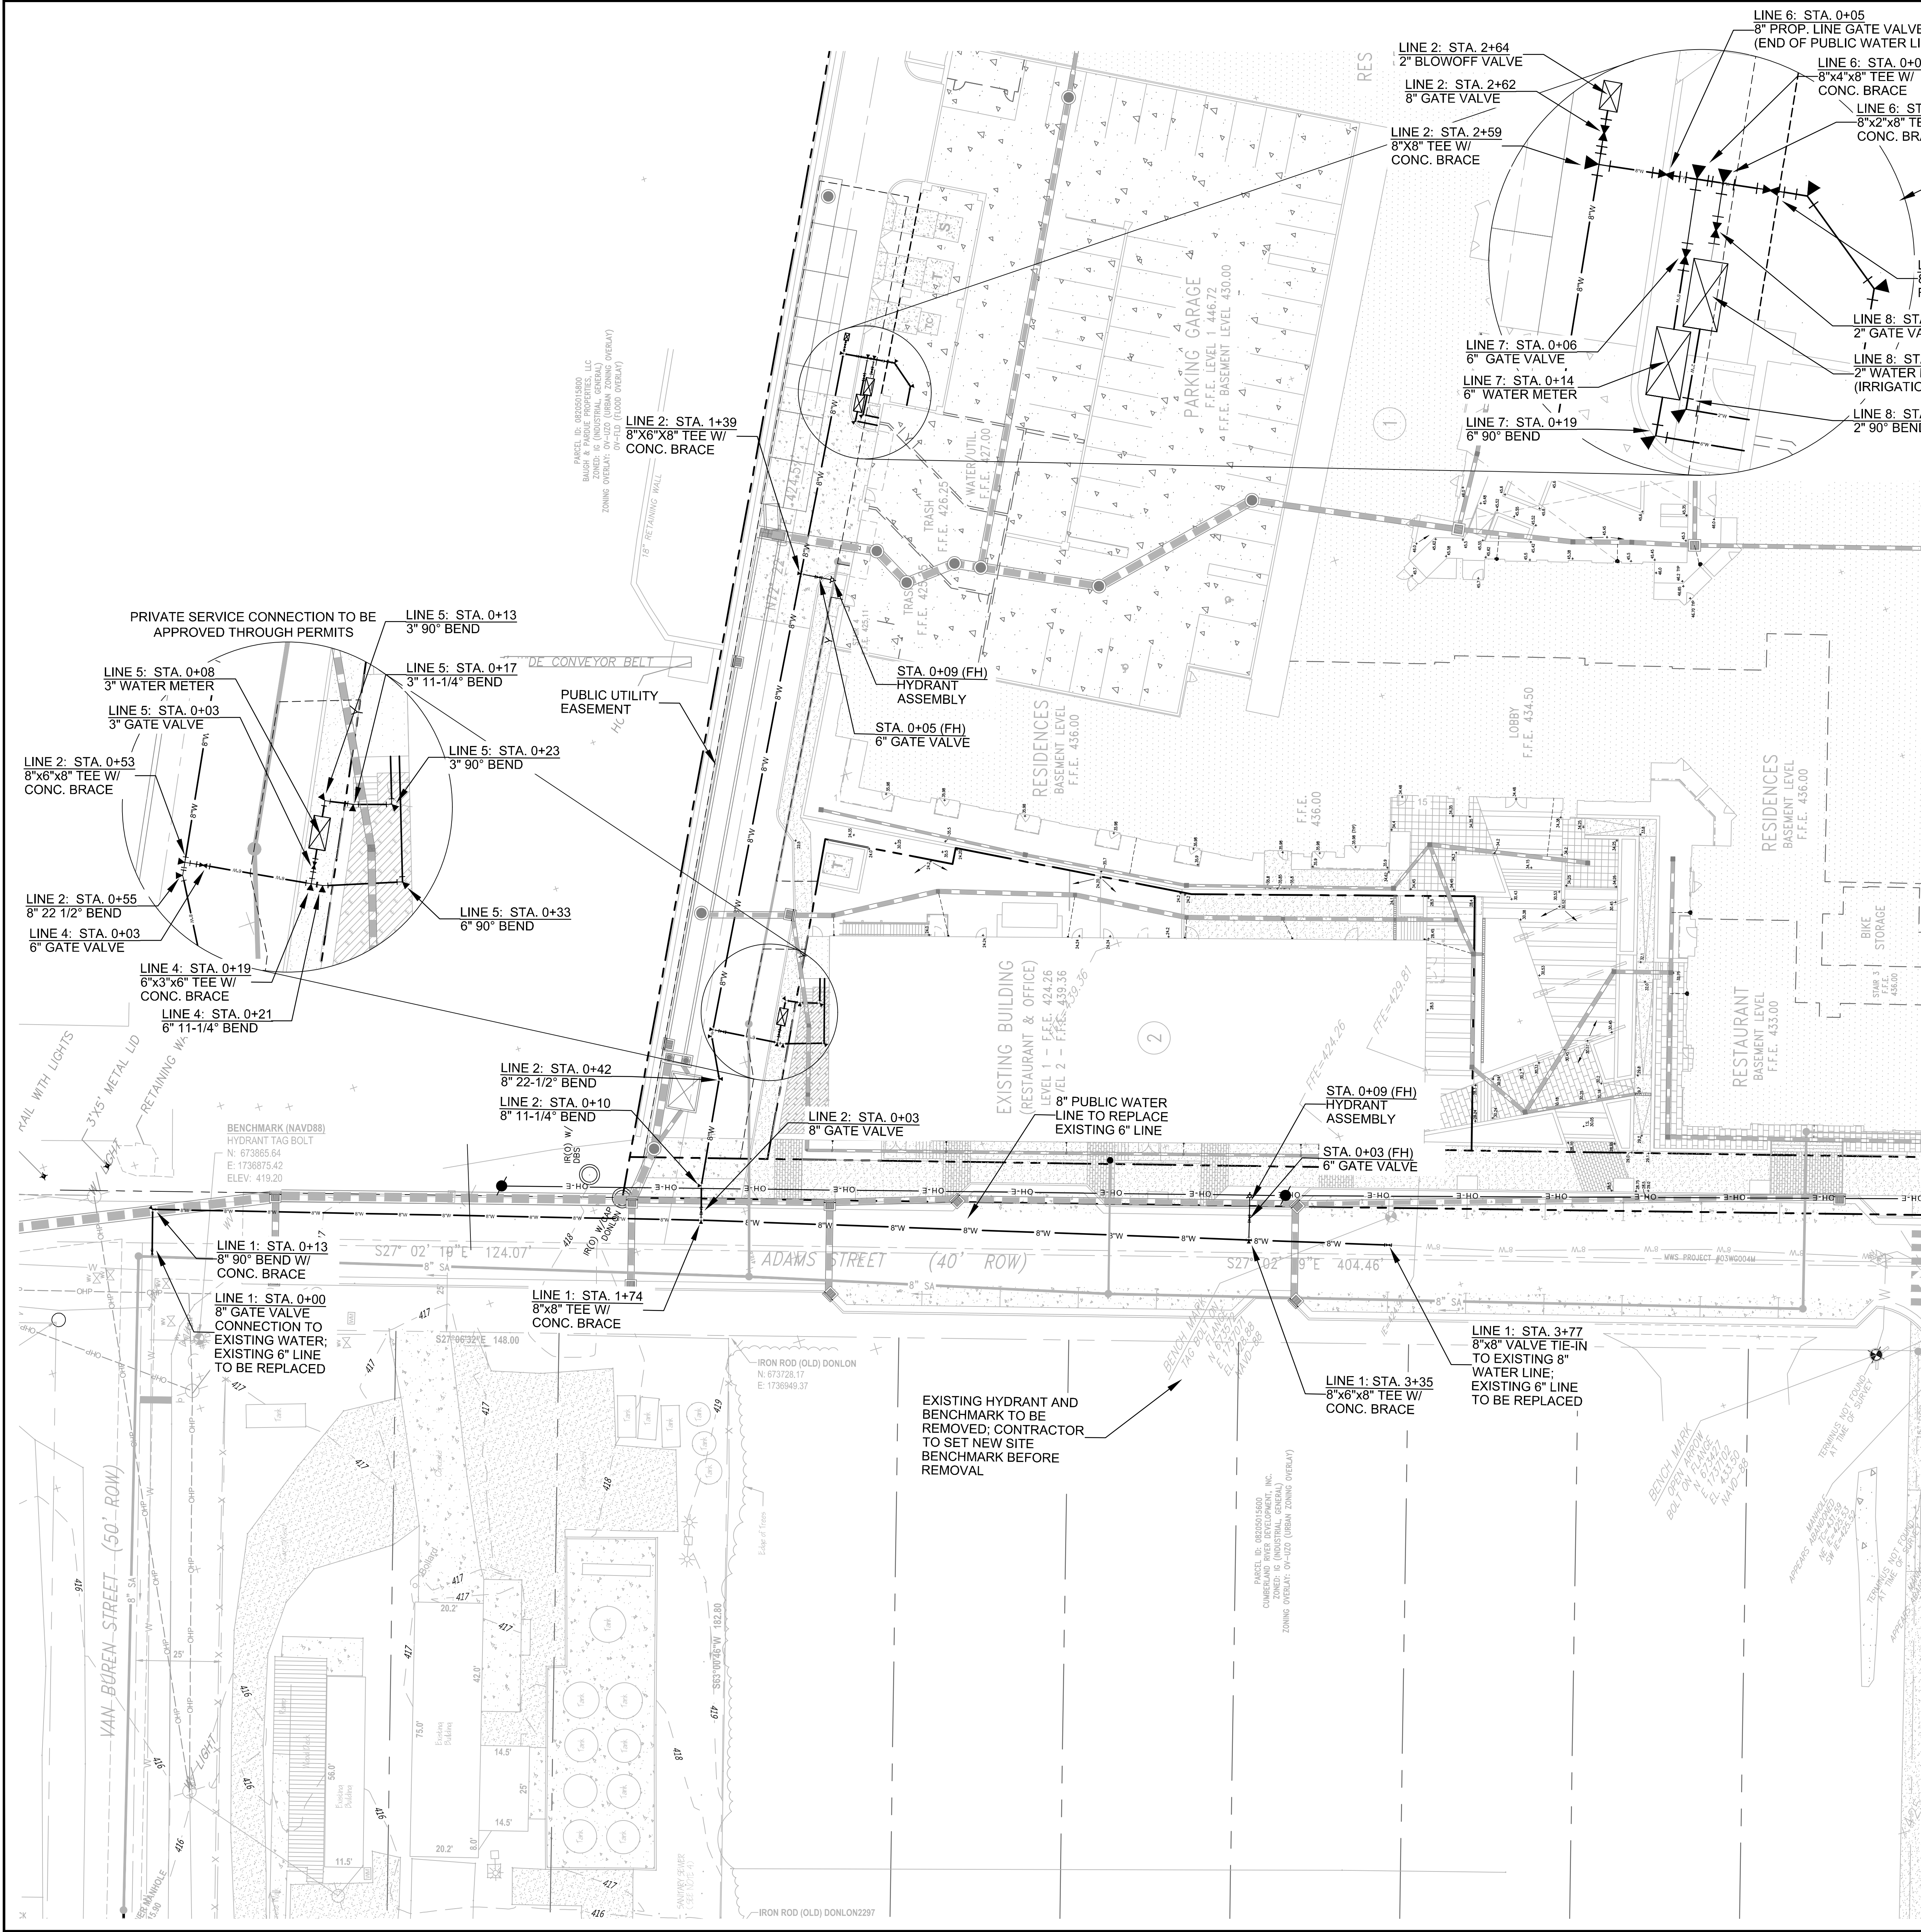



- SITE BM 1: TAG BOLT ON FLANGE OF HYDRANT ON EASTERN SIDE OF ADAMS STREET ROW ELEV: 428.88
- SITE BM 2: OPEN ARROW BOLT ON FLANGE OF HYDRANT ON WESTERN SIDE OF ADAMS STREET ROW ELEV: 433.50

Littlejohn
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1935 21st Avenue South, NASHVILLE, TENNESSEE 37217
T: 615.385.9144 F: 615.385.4020 www.littlejohn.com

Case No: 2016SP-005-003
SP PLAN AMENDMENT
HAMMER MILL MULTIFAMILY
NASHVILLE, DAVIDSON COUNTY, TENNESSEE

Gateway TBR
Hammer Mill, GP
1575 NORTHSIDE DRIVE
BUILDING 100, SUITE 200
ATLANTA, GA 30318

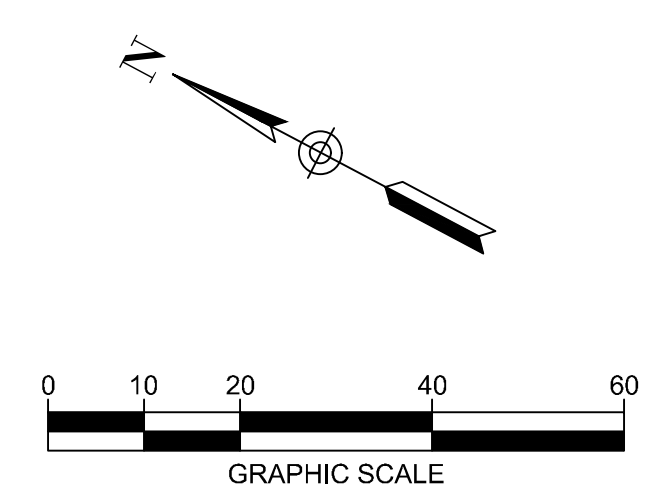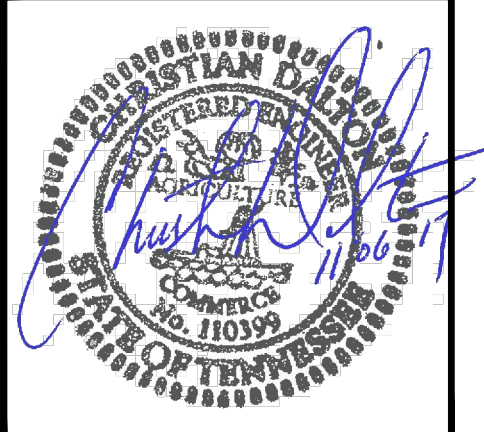


- NOTES:
- REFER TO SHEET C7.1 FOR SANITARY SEWER PLAN AND PROFILE.
 - REFER TO SHEET C7.1 FOR METRO WATER AND SEWER NOTES.



DATE	REVISIONS
2017.09.28	20150950

C7.2
PUBLIC WATER PLAN


MWS No. 16-WL-148 & 16-SL-169

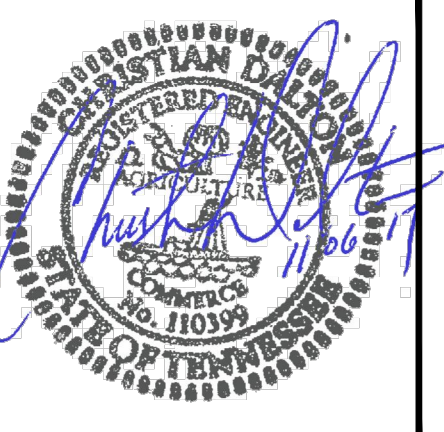




DATE	REVISIONS
2017.09.28	20150950

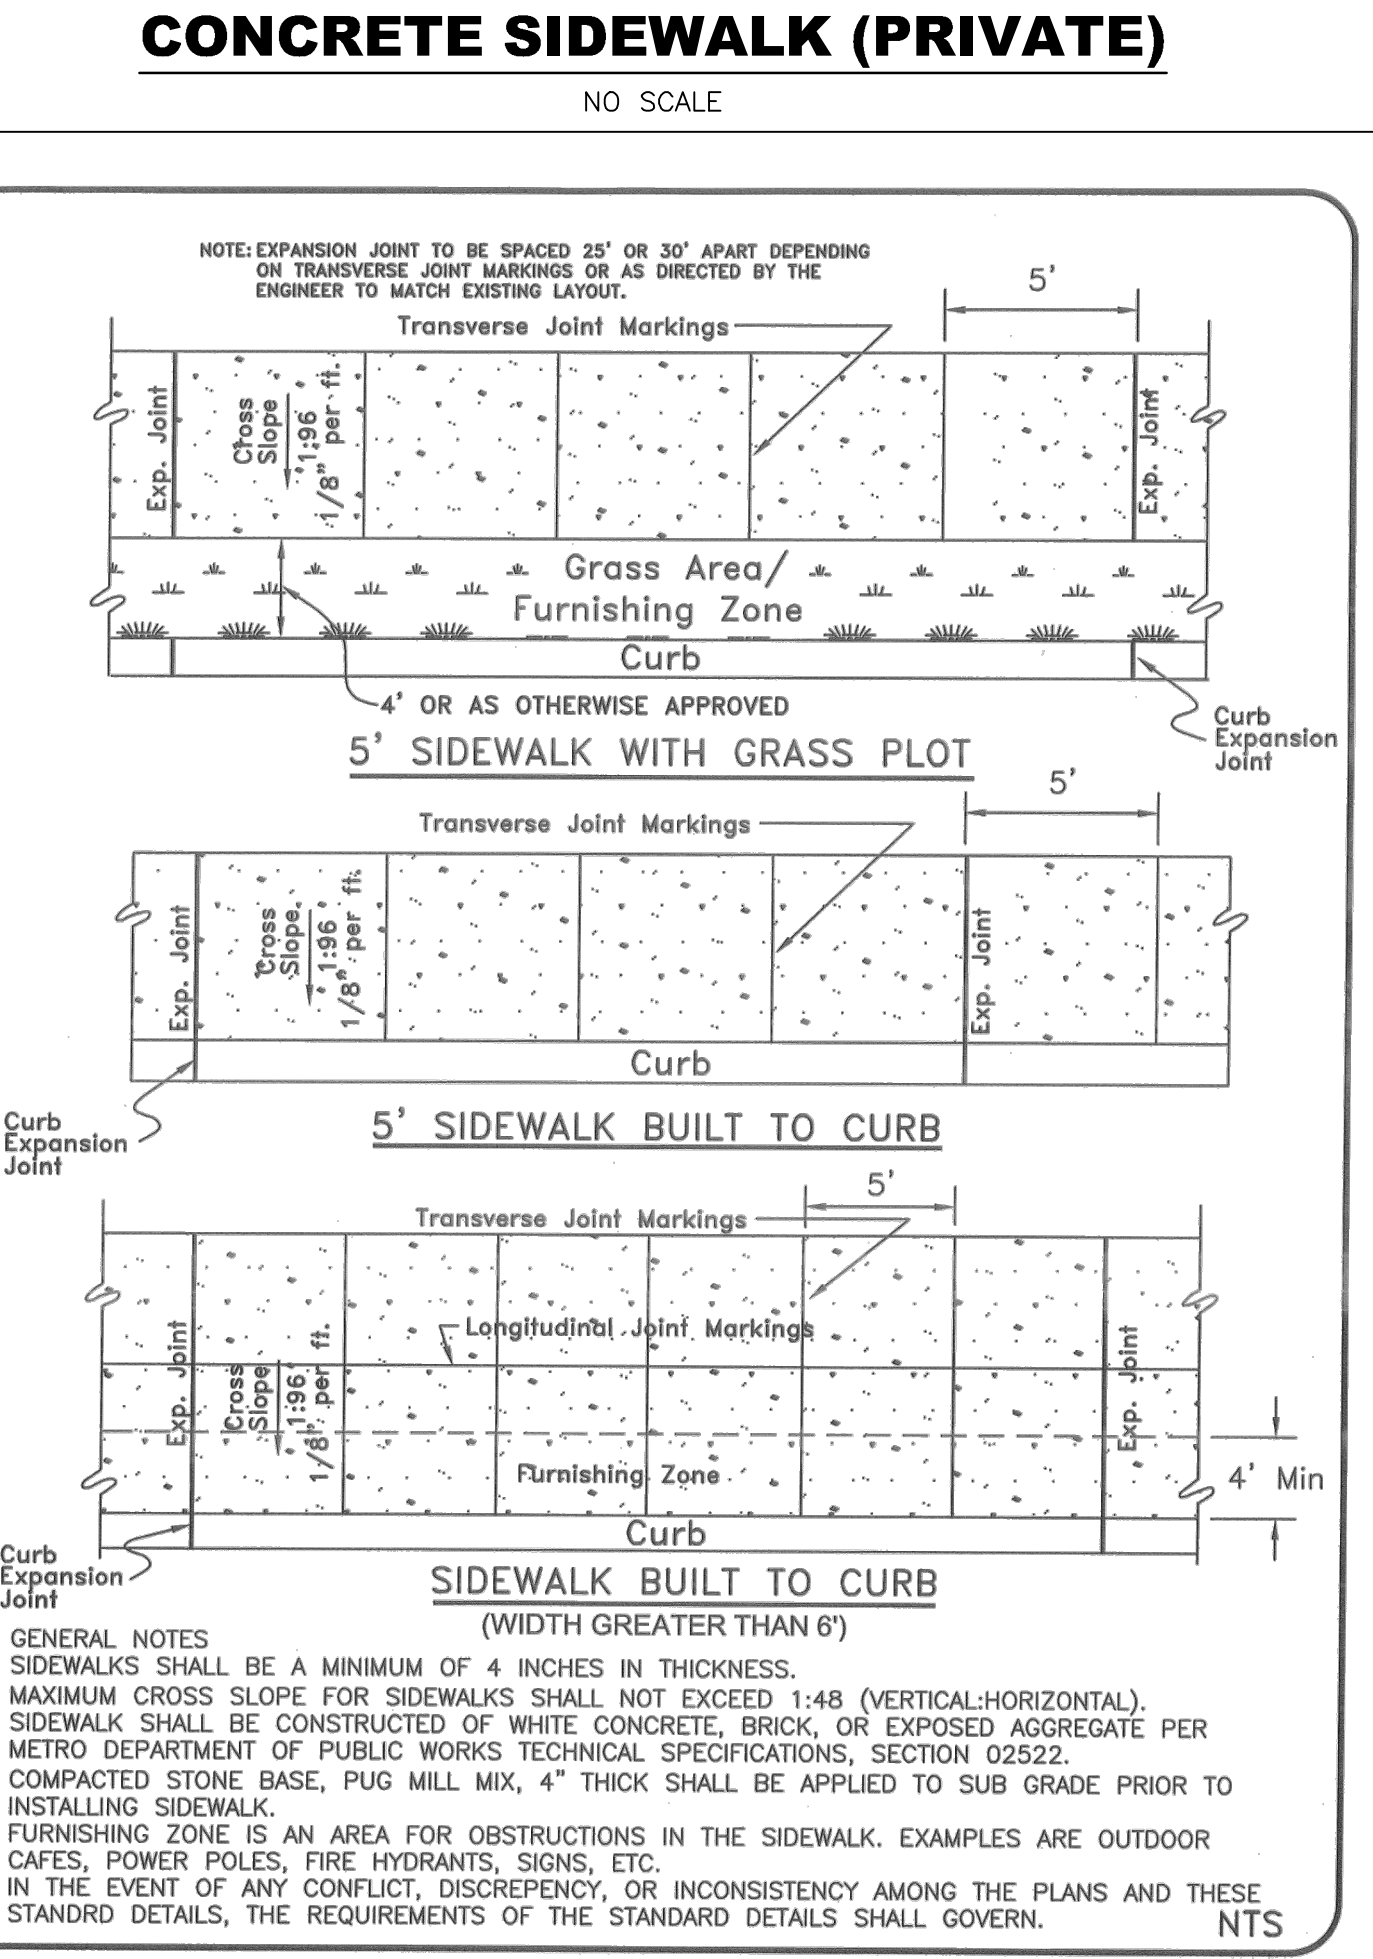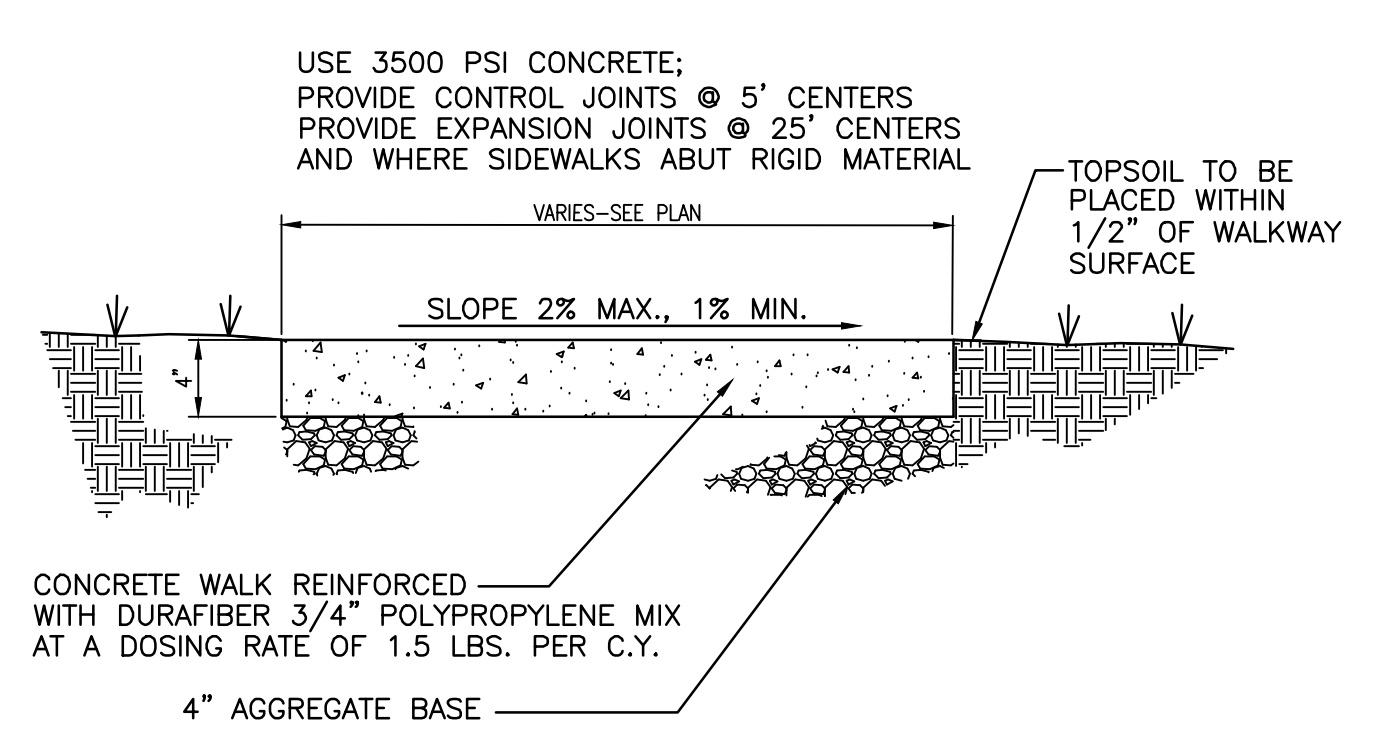


METROPOLITAN GOVERNMENT OF NASHVILLE AND DAVIDSON COUNTY DEPARTMENT OF PUBLIC WORKS	SIDEWALK CONSTRUCTION	DWG. NO. ST-110
DIR. OF ENG.: <i>Mark May</i>	DATE: 7/15/06	REVIS: 05/02/03 REVIS: 11/24/03 REVIS: 06/23/04

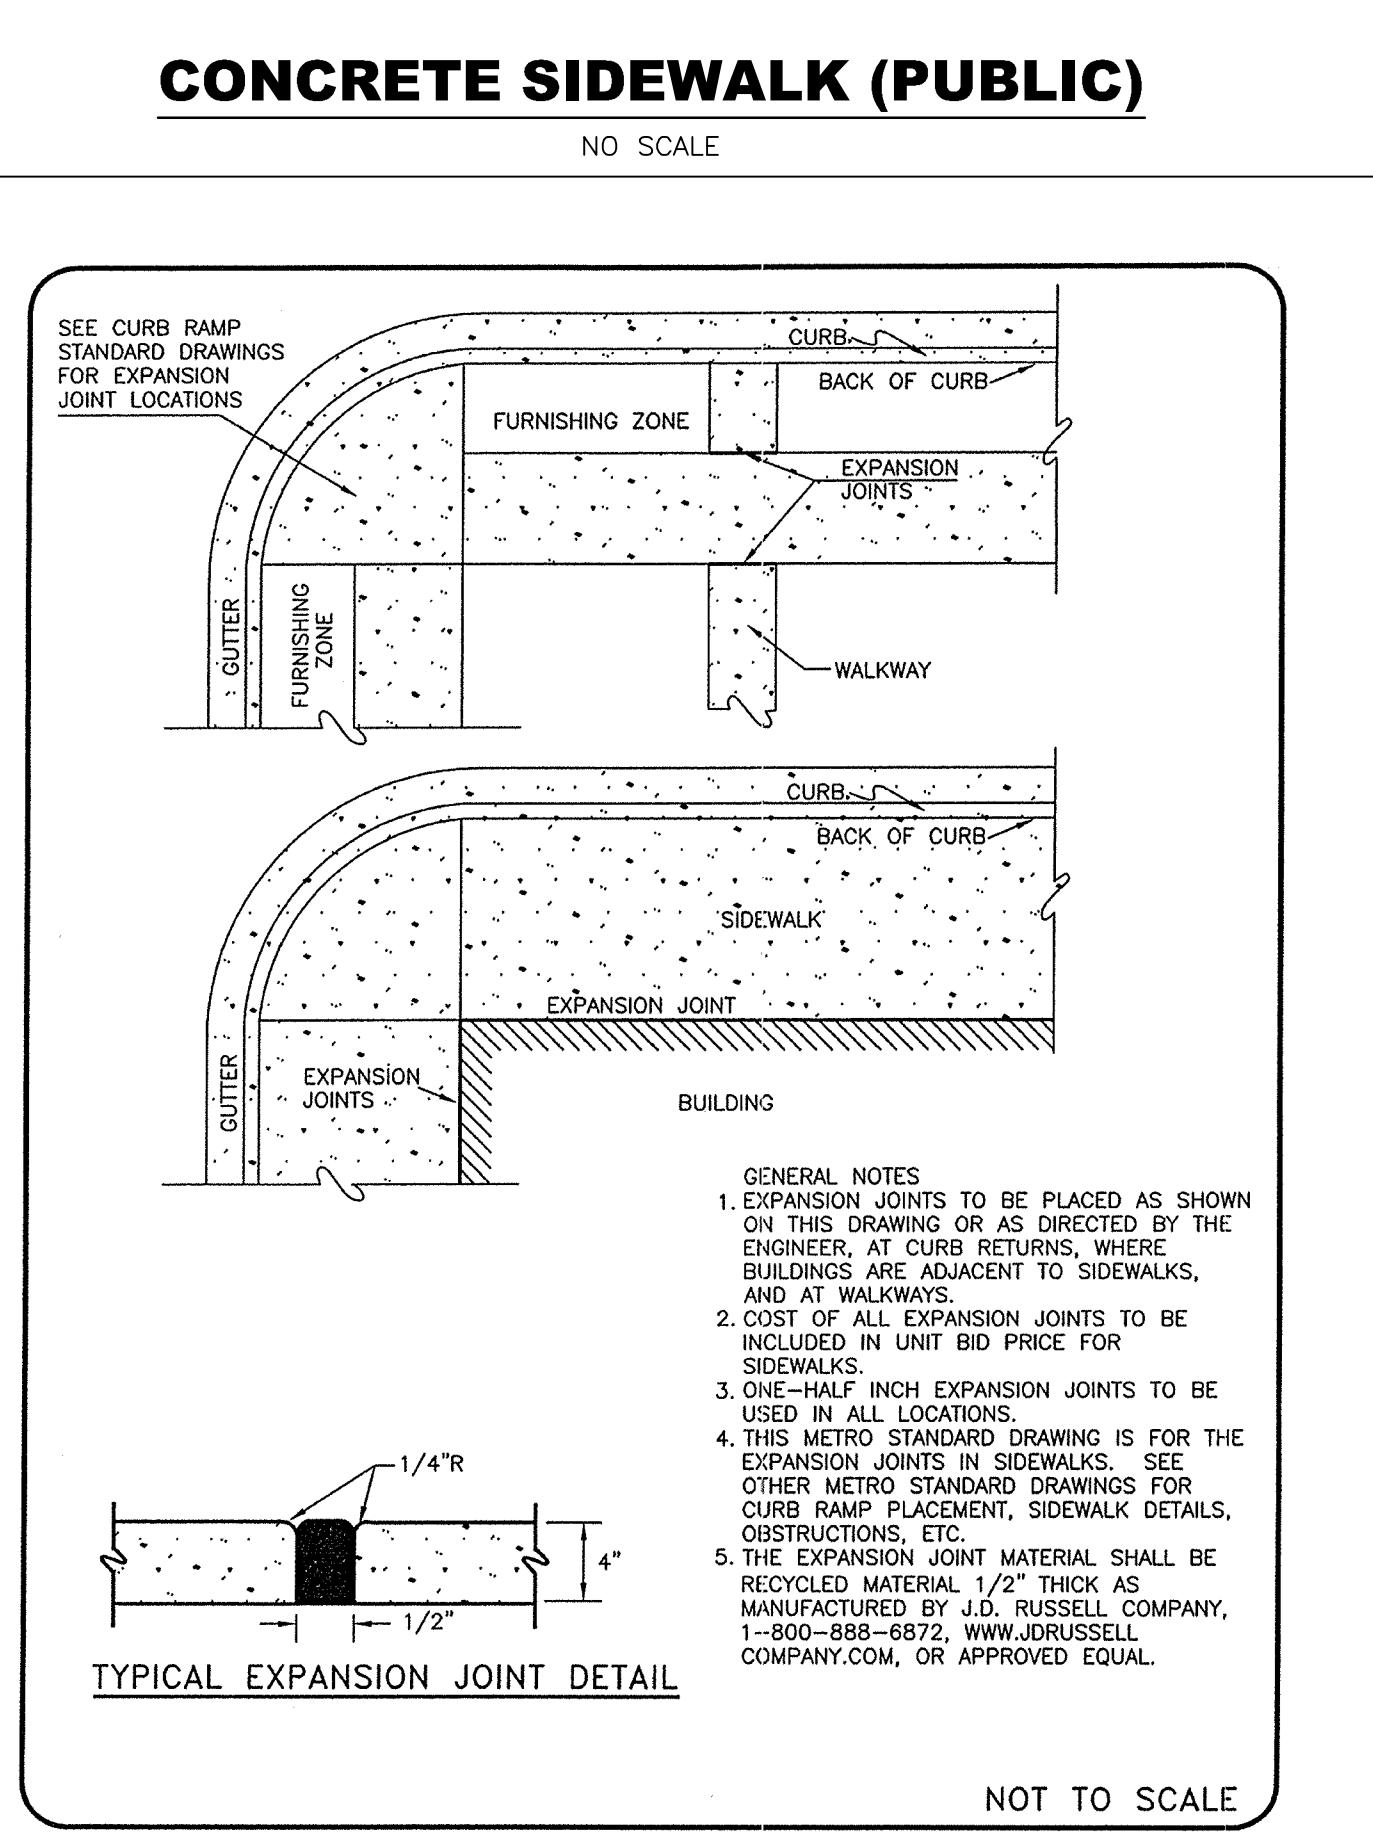


METROPOLITAN GOVERNMENT OF NASHVILLE AND DAVIDSON COUNTY DEPARTMENT OF PUBLIC WORKS	STANDARD EXPANSION JOINT FOR CONCRETE SIDEWALK	DWG. NO. ST-209
DIR. OF ENG.: <i>Mark May</i>	DATE: 5/12/03	REVIS: 03/01/02 REVIS: 05/02/03

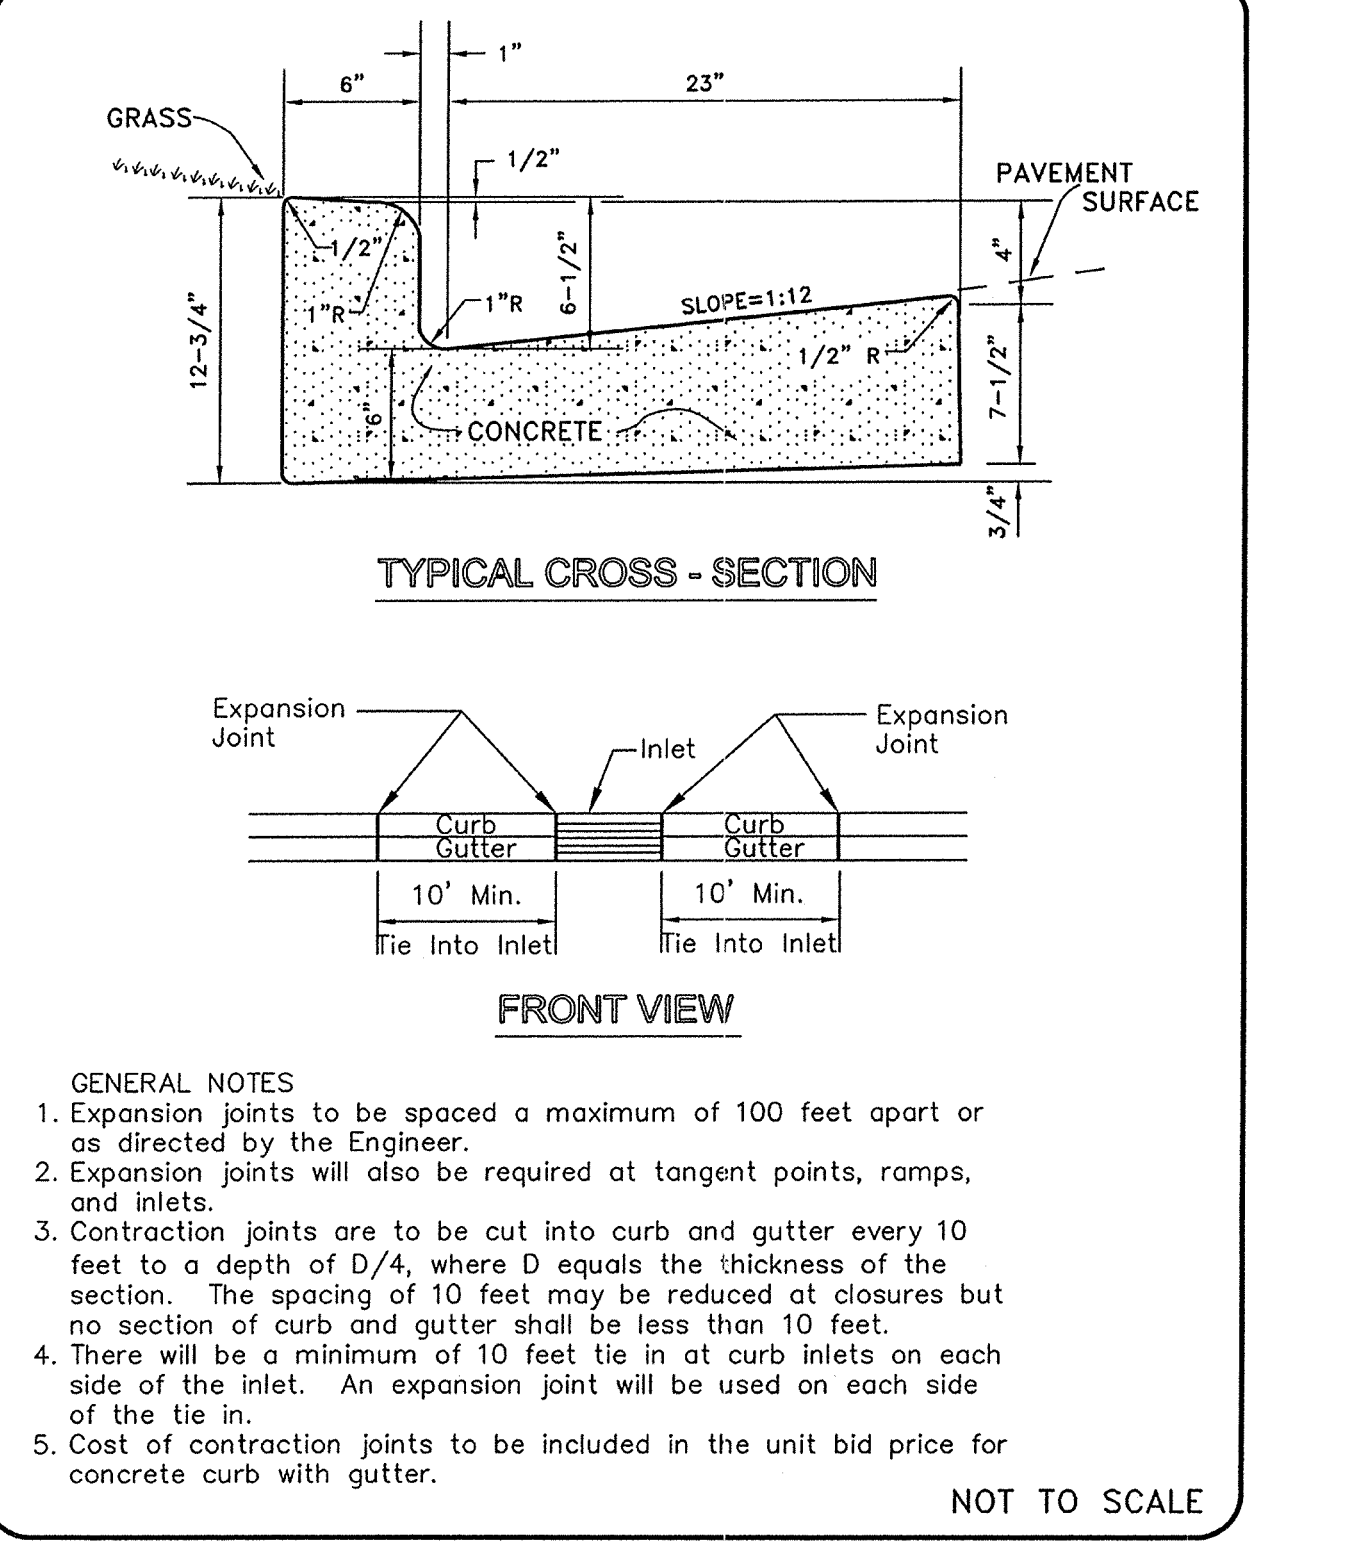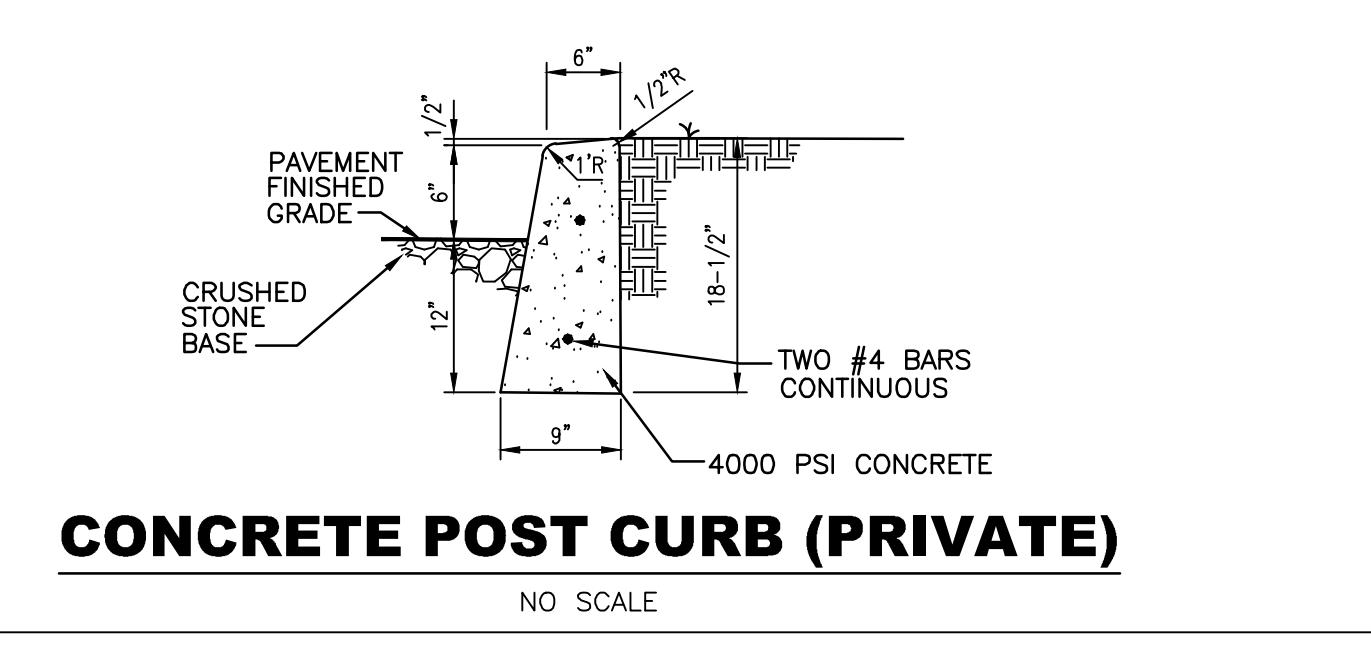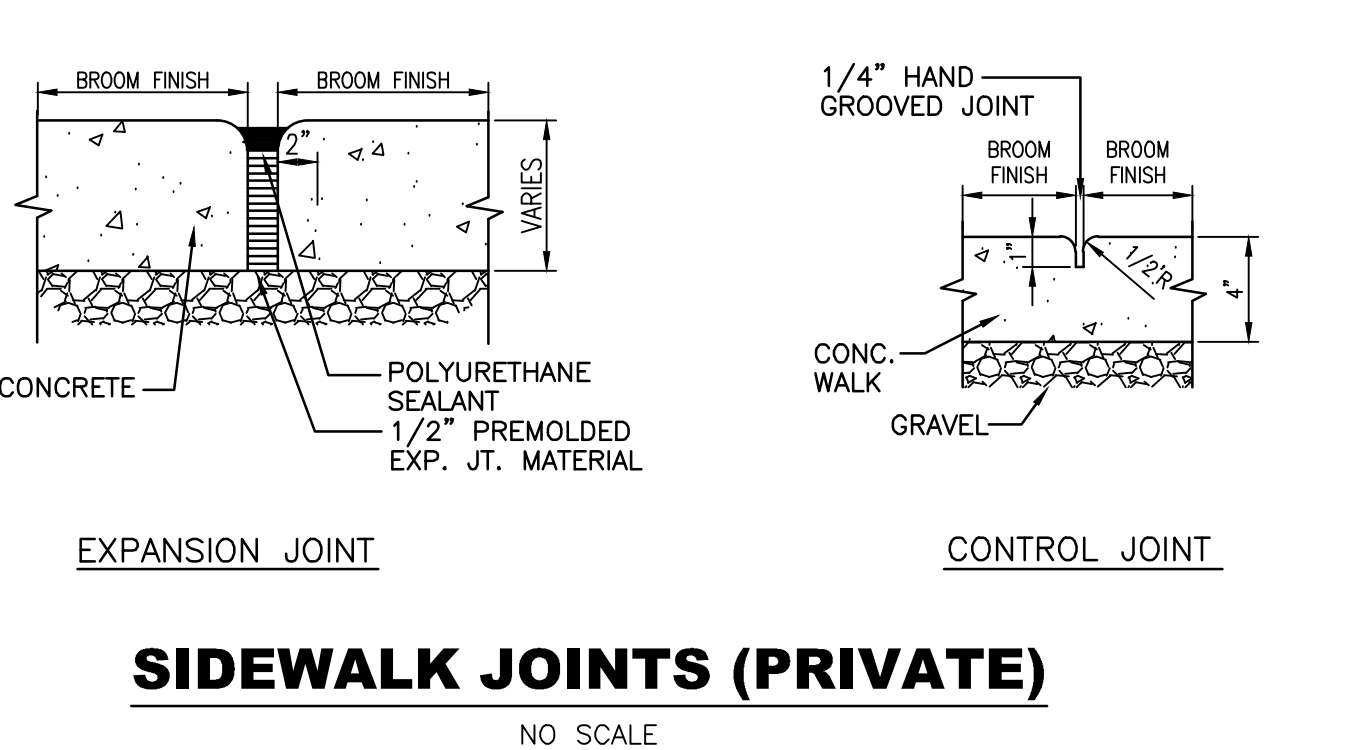



METROPOLITAN GOVERNMENT OF NASHVILLE AND DAVIDSON COUNTY DEPARTMENT OF PUBLIC WORKS	STANDARD CURB WITH GUTTER	DWG. NO. ST-200
DIR. OF ENG.: <i>Mark May</i>	DATE: 5/12/03	REVIS: 07/21/00 REVIS: 05/02/03

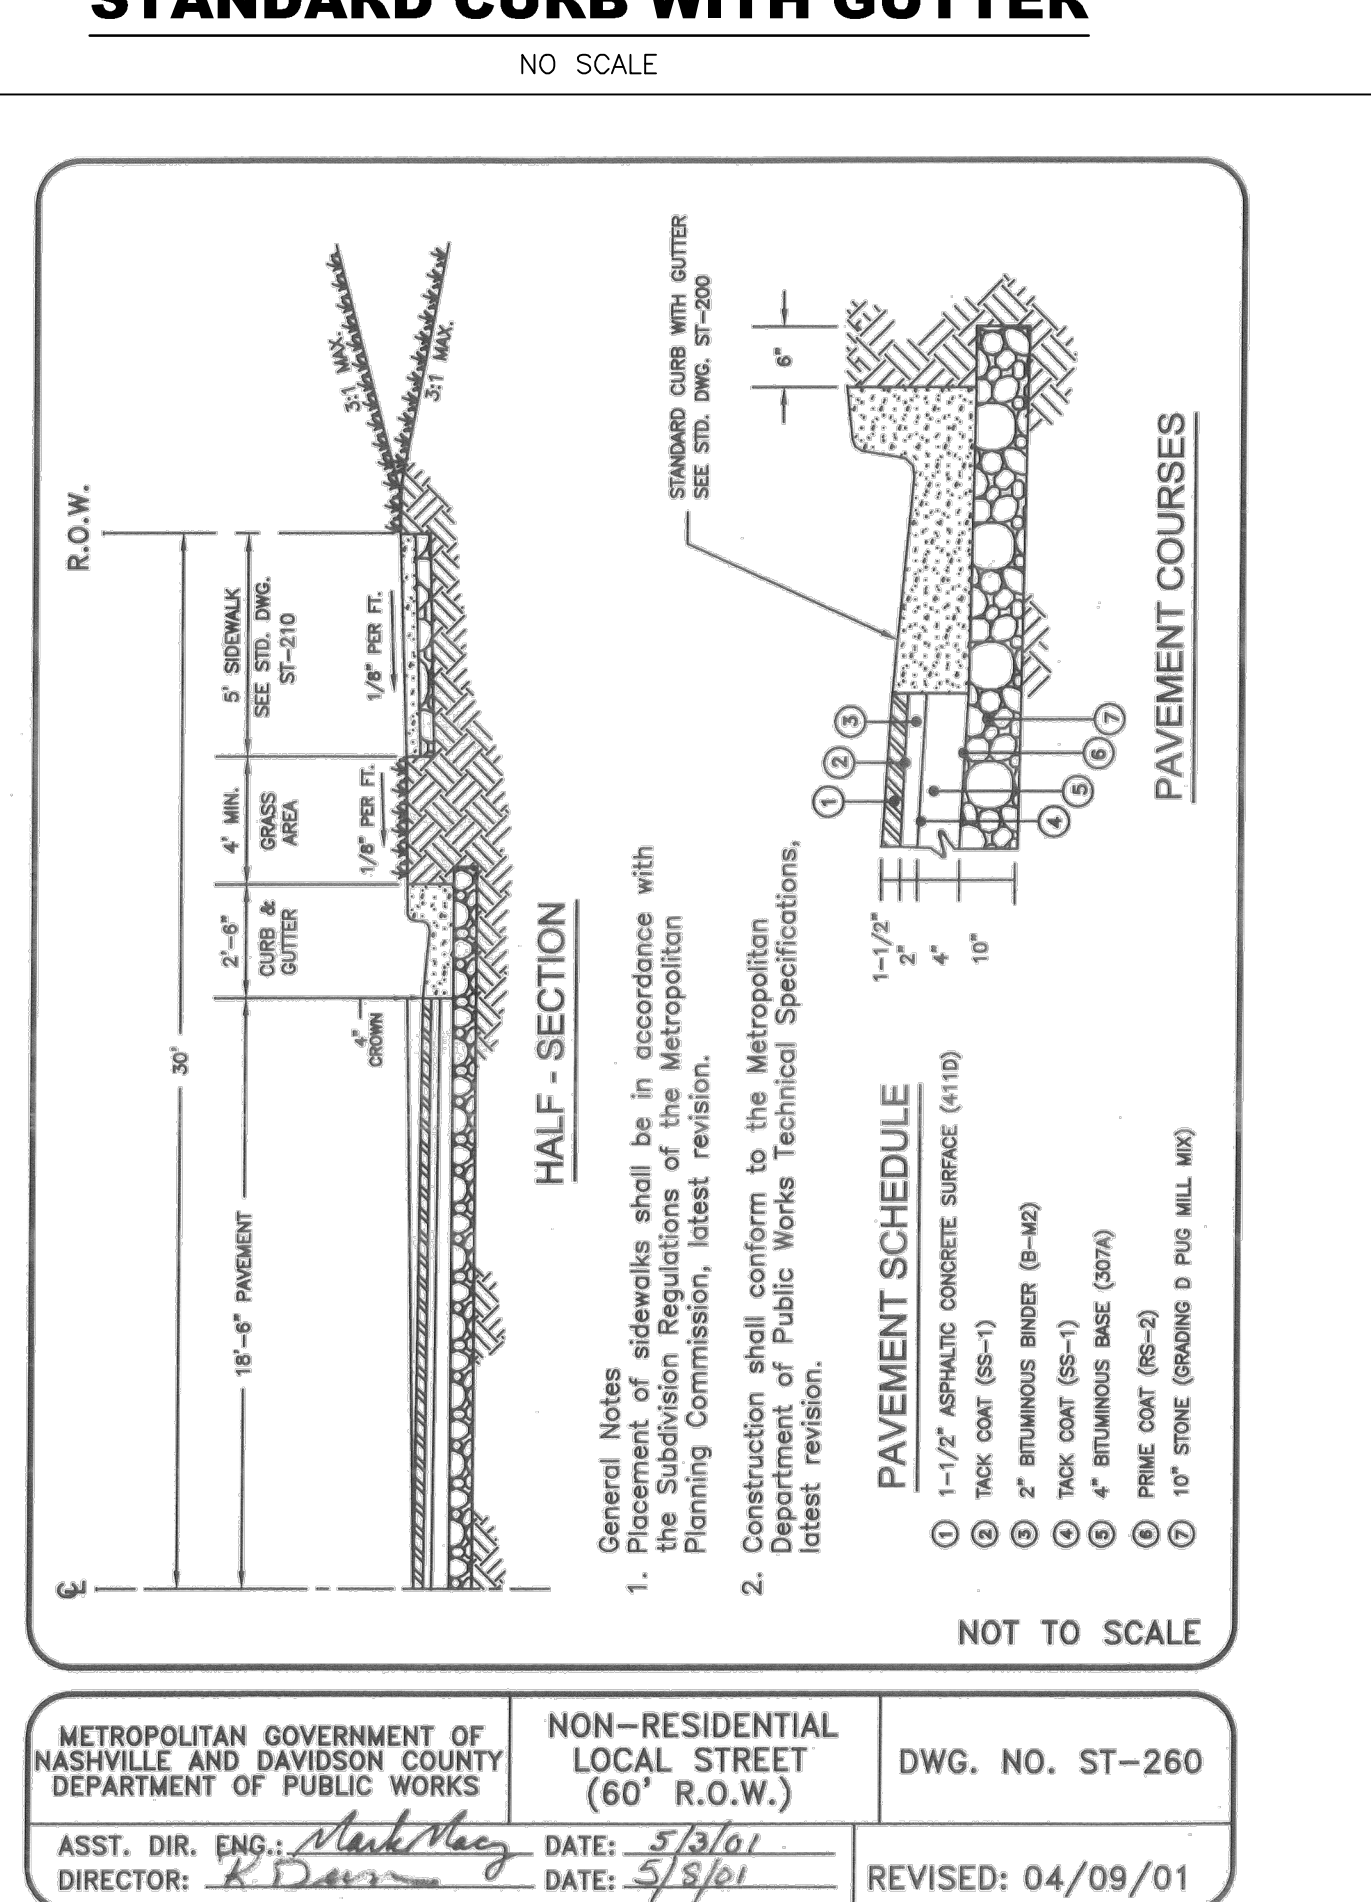


METROPOLITAN GOVERNMENT OF NASHVILLE AND DAVIDSON COUNTY DEPARTMENT OF PUBLIC WORKS	NON-RESIDENTIAL LOCAL STREET (60' R.O.W.)	DWG. NO. ST-260
ASST. DIR. ENG.: <i>Mark May</i>	DATE: 5/3/01	REVIS: 04/09/01

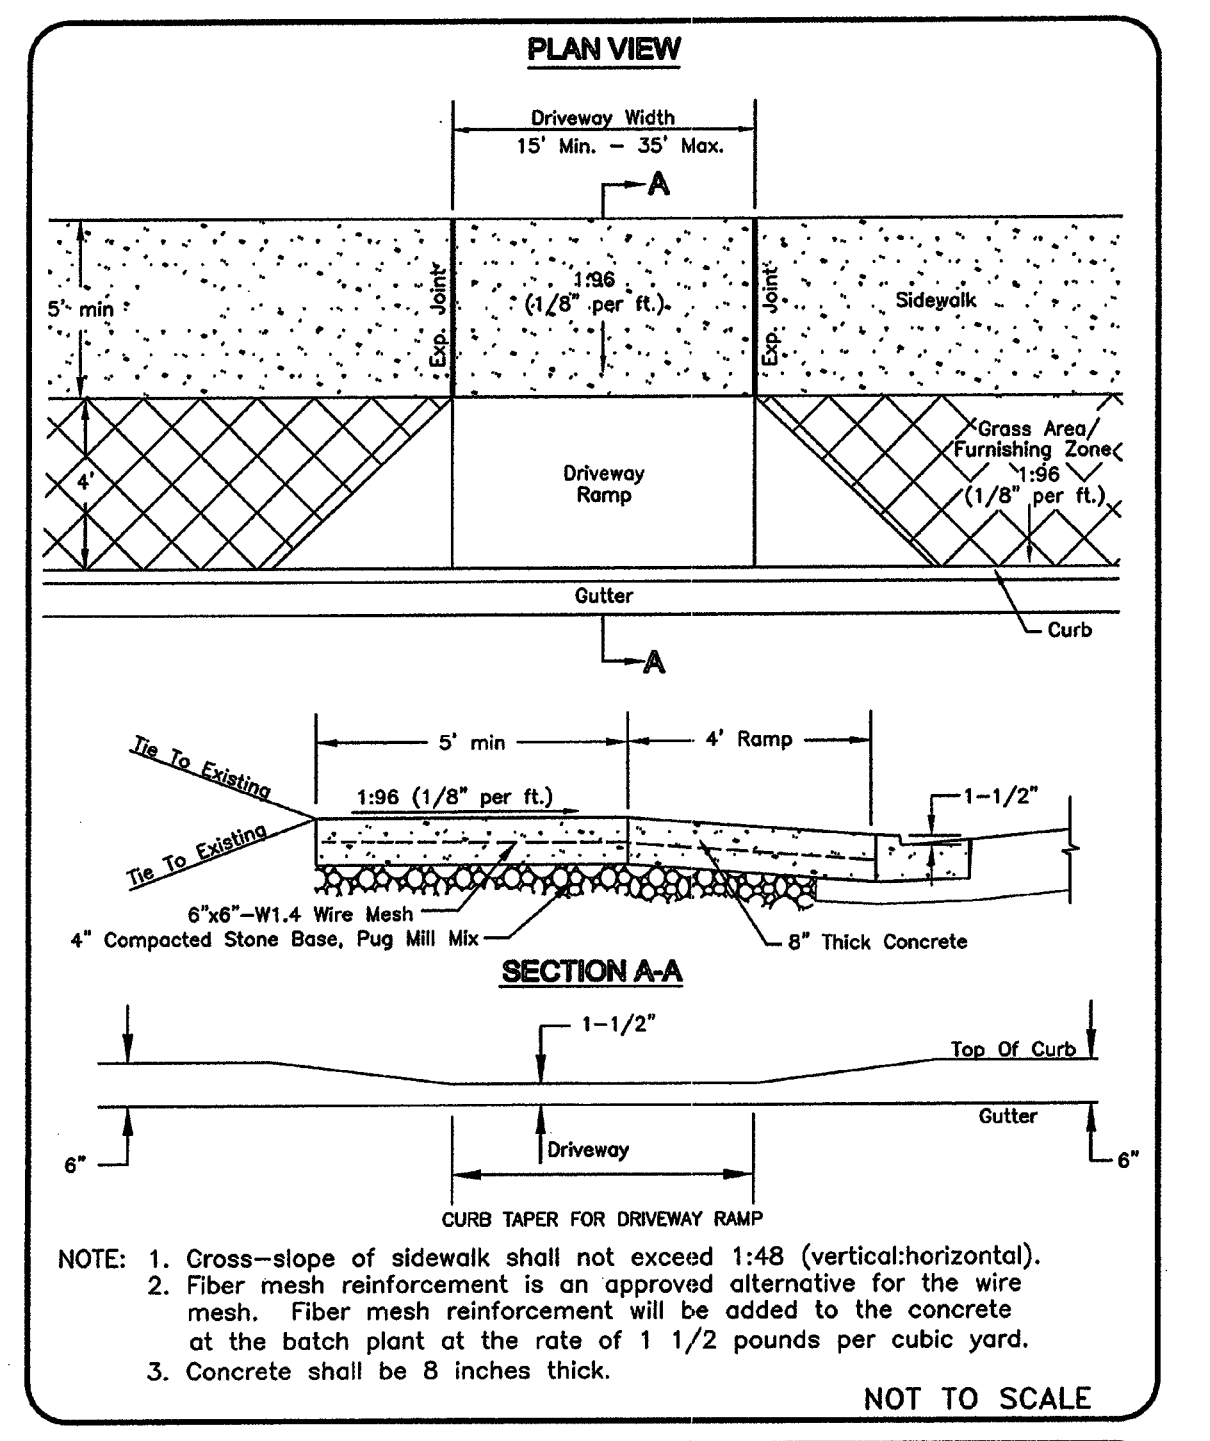


METROPOLITAN GOVERNMENT OF NASHVILLE AND DAVIDSON COUNTY DEPARTMENT OF PUBLIC WORKS	NEW CONSTRUCTION COMMERCIAL DRIVEWAY RAMP	DWG. NO. ST-324
DIR. OF ENG.: <i>Mark May</i>	DATE: 5/12/03	REVIS: 07/27/02 REVIS: 05/06/03

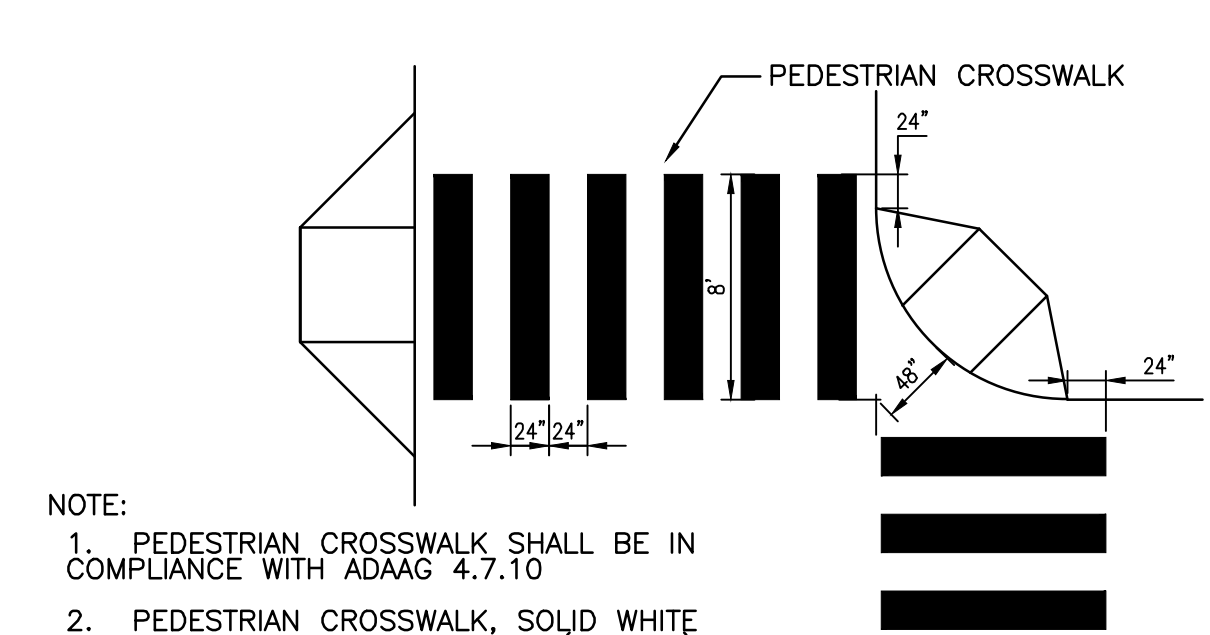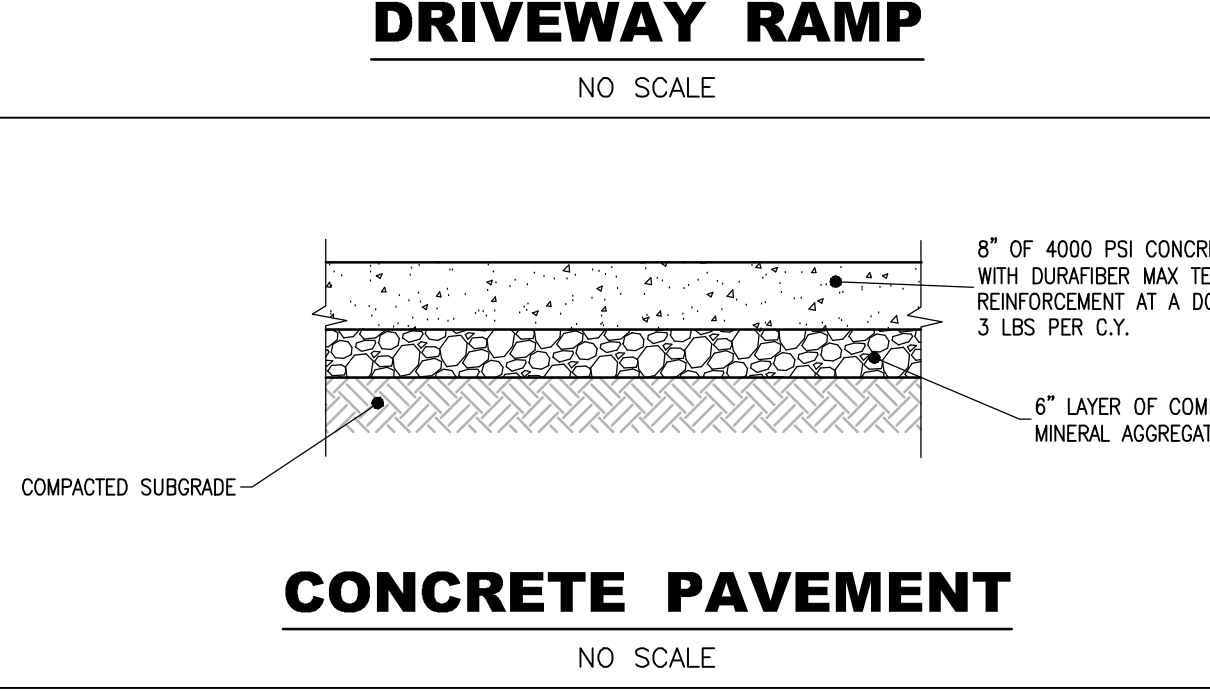




METROPOLITAN GOVERNMENT OF NASHVILLE AND DAVIDSON COUNTY DEPARTMENT OF PUBLIC WORKS	STANDARD CURB RAMP NOTES	DWG. NO. ST-215
ASST. DIR. ENG.: <i>Mark May</i>	DATE: 11/01/02	REVIS: 11/10/00

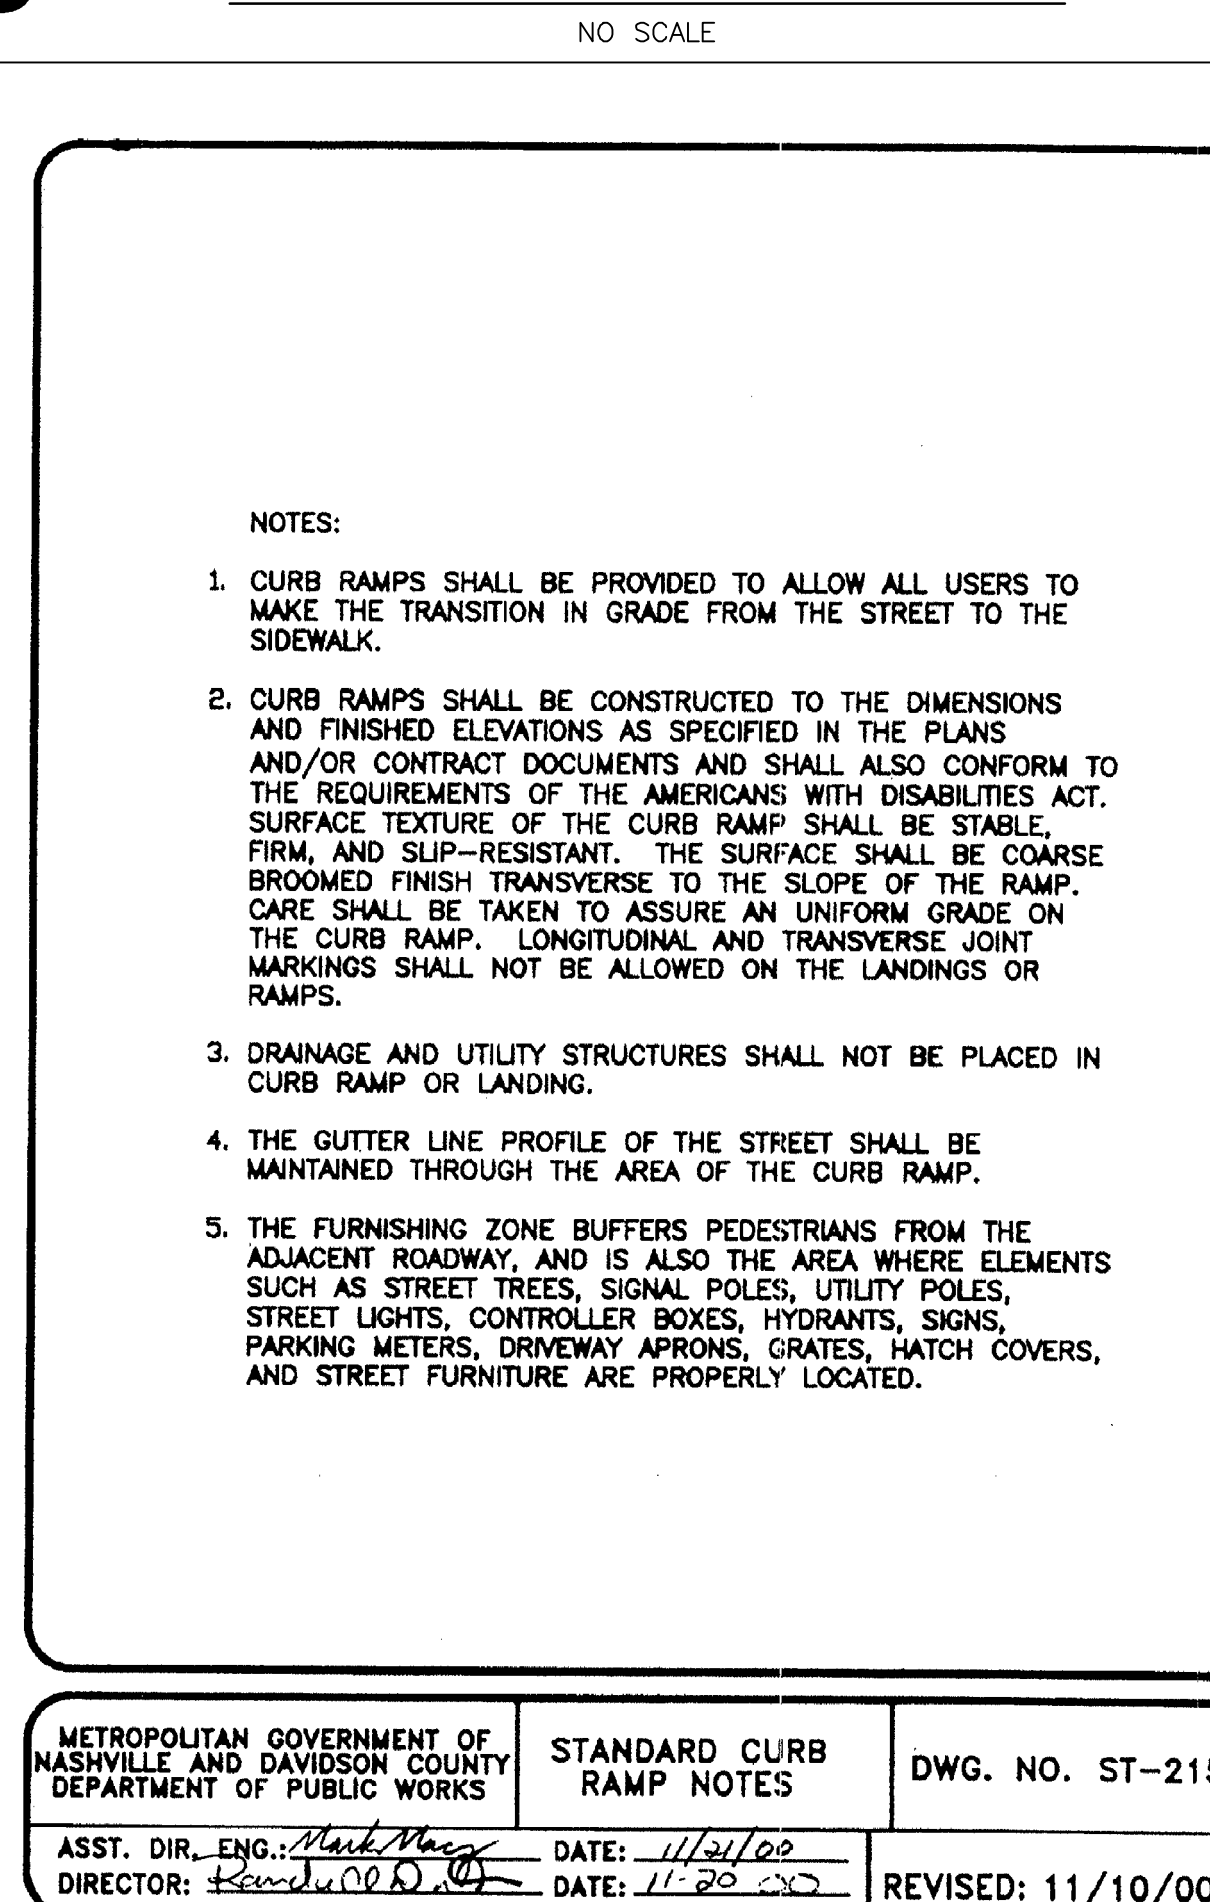

METROPOLITAN GOVERNMENT OF NASHVILLE AND DAVIDSON COUNTY DEPARTMENT OF PUBLIC WORKS	STANDARD CURB RAMP NOTES	DWG. NO. ST-215
ASST. DIR. ENG.: <i>Mark May</i>	DATE: 11/01/02	REVIS: 11/10/00

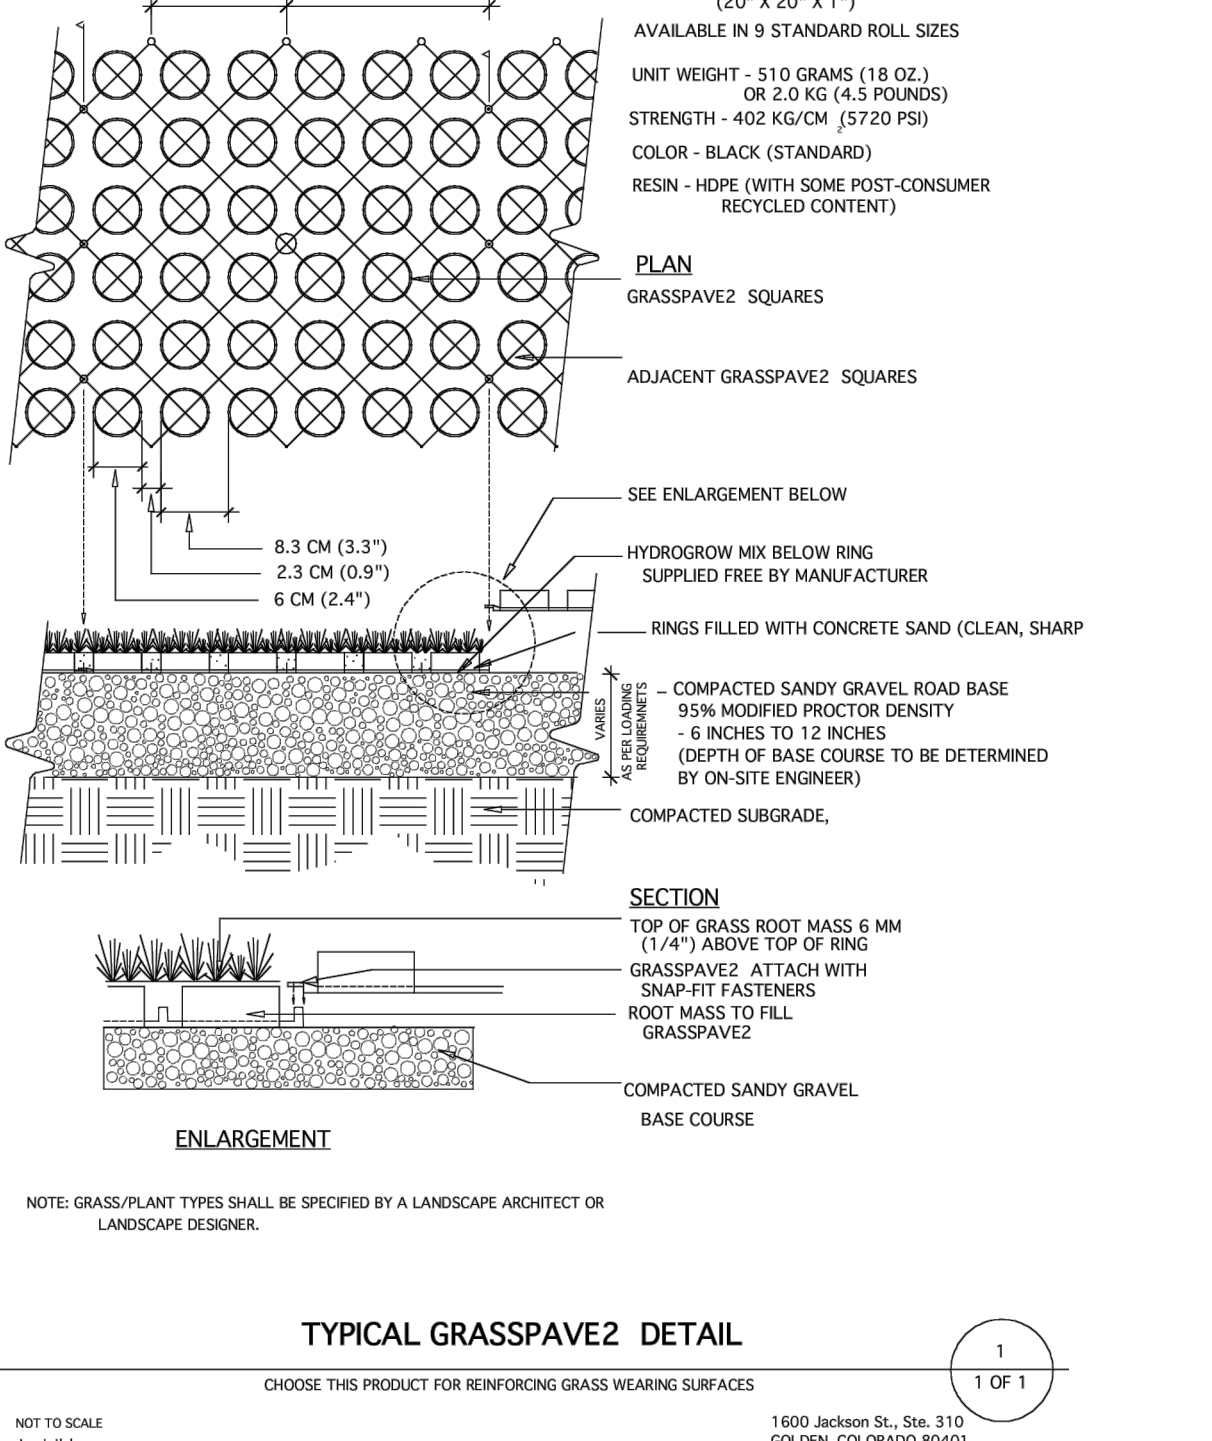

METROPOLITAN GOVERNMENT OF NASHVILLE AND DAVIDSON COUNTY DEPARTMENT OF PUBLIC WORKS	GRASS PAVERS	DWG. NO. ST-323
DIR. OF ENG.: <i>Mark May</i>	DATE: 5/12/03	REVIS: 07/27/02 REVIS: 05/06/03

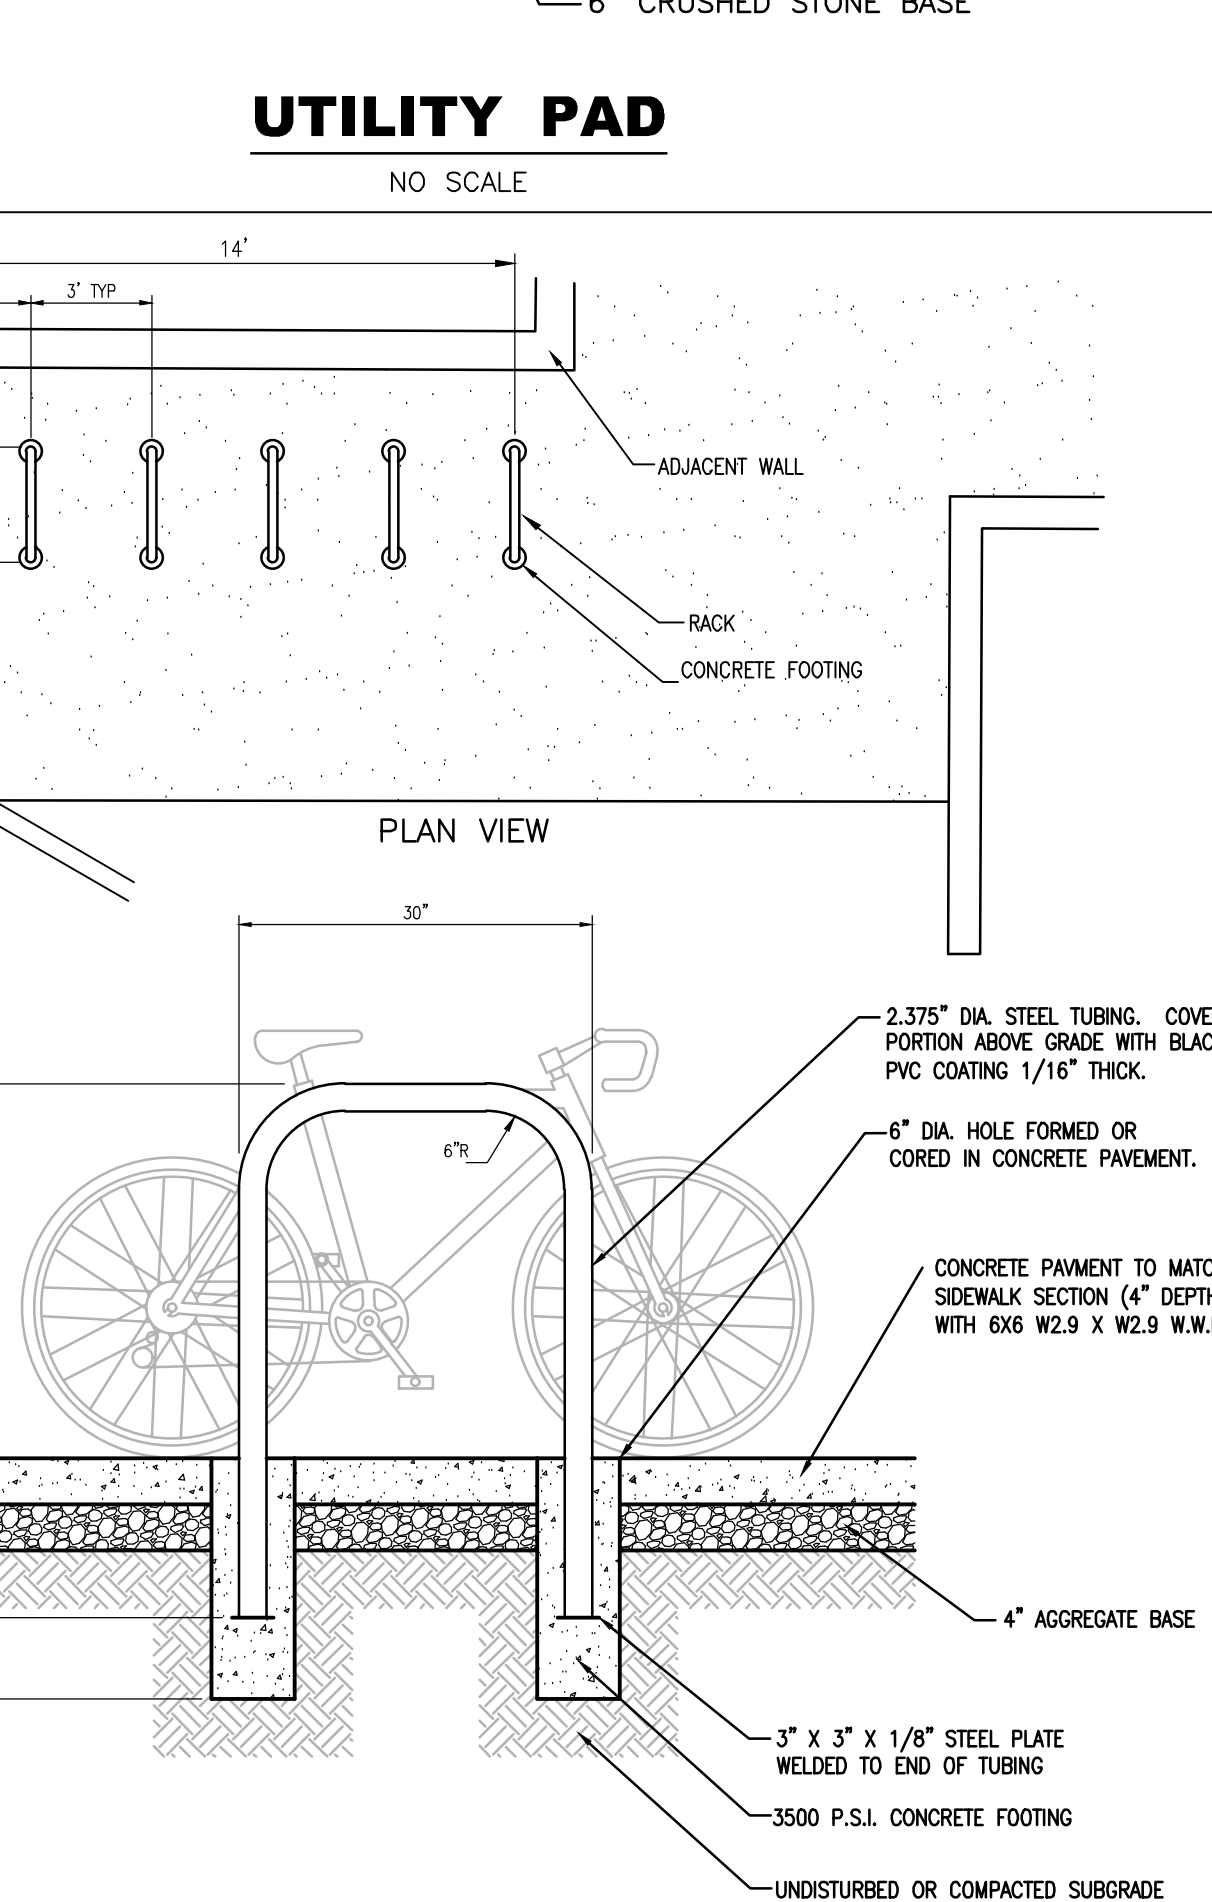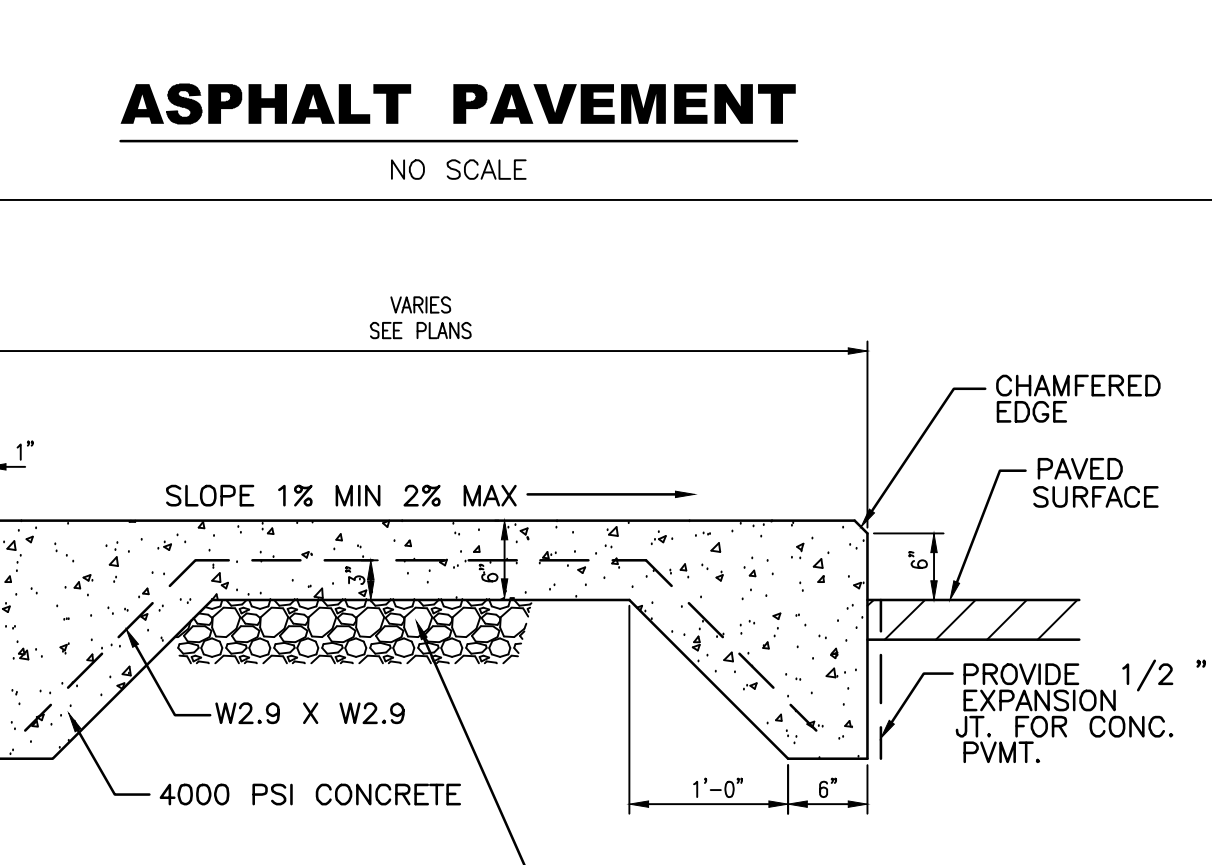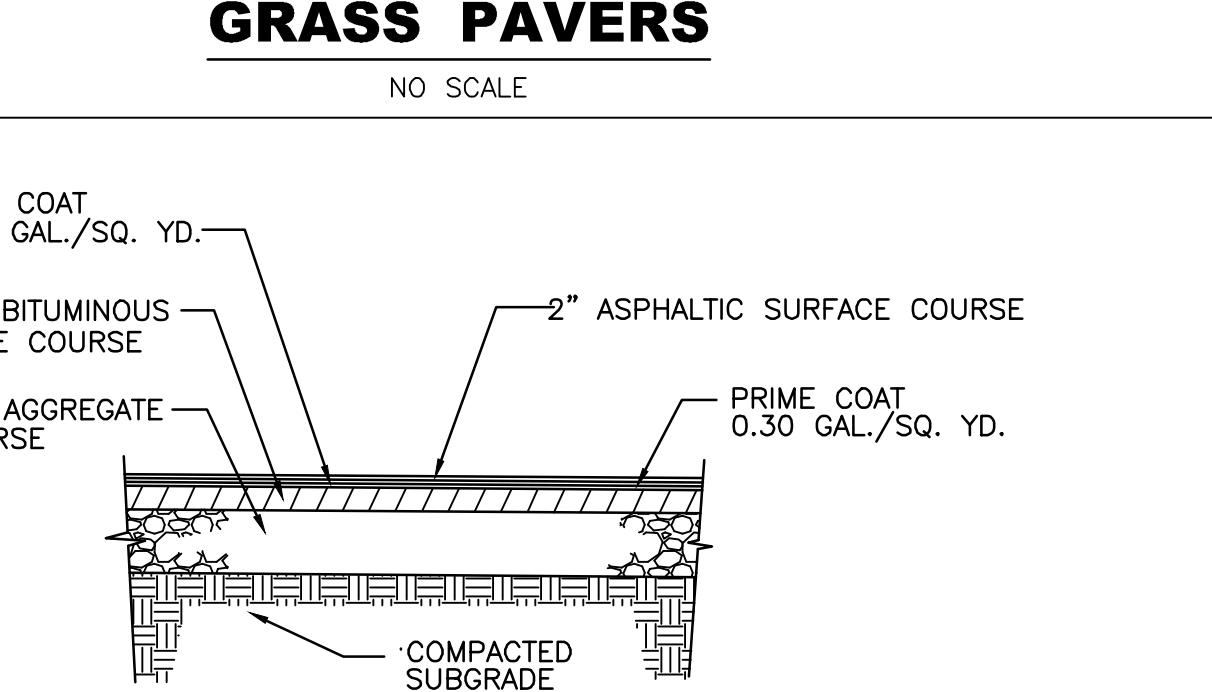

METROPOLITAN GOVERNMENT OF NASHVILLE AND DAVIDSON COUNTY DEPARTMENT OF PUBLIC WORKS	BICYCLE RACK AND PAD	DWG. NO. ST-216
ASST. DIR. ENG.: <i>Mark May</i>	DATE: 11/01/02	REVIS: 11/10/00

12


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14

15

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K1-E-ECP GALV



SPECIFICATION CLAUSE

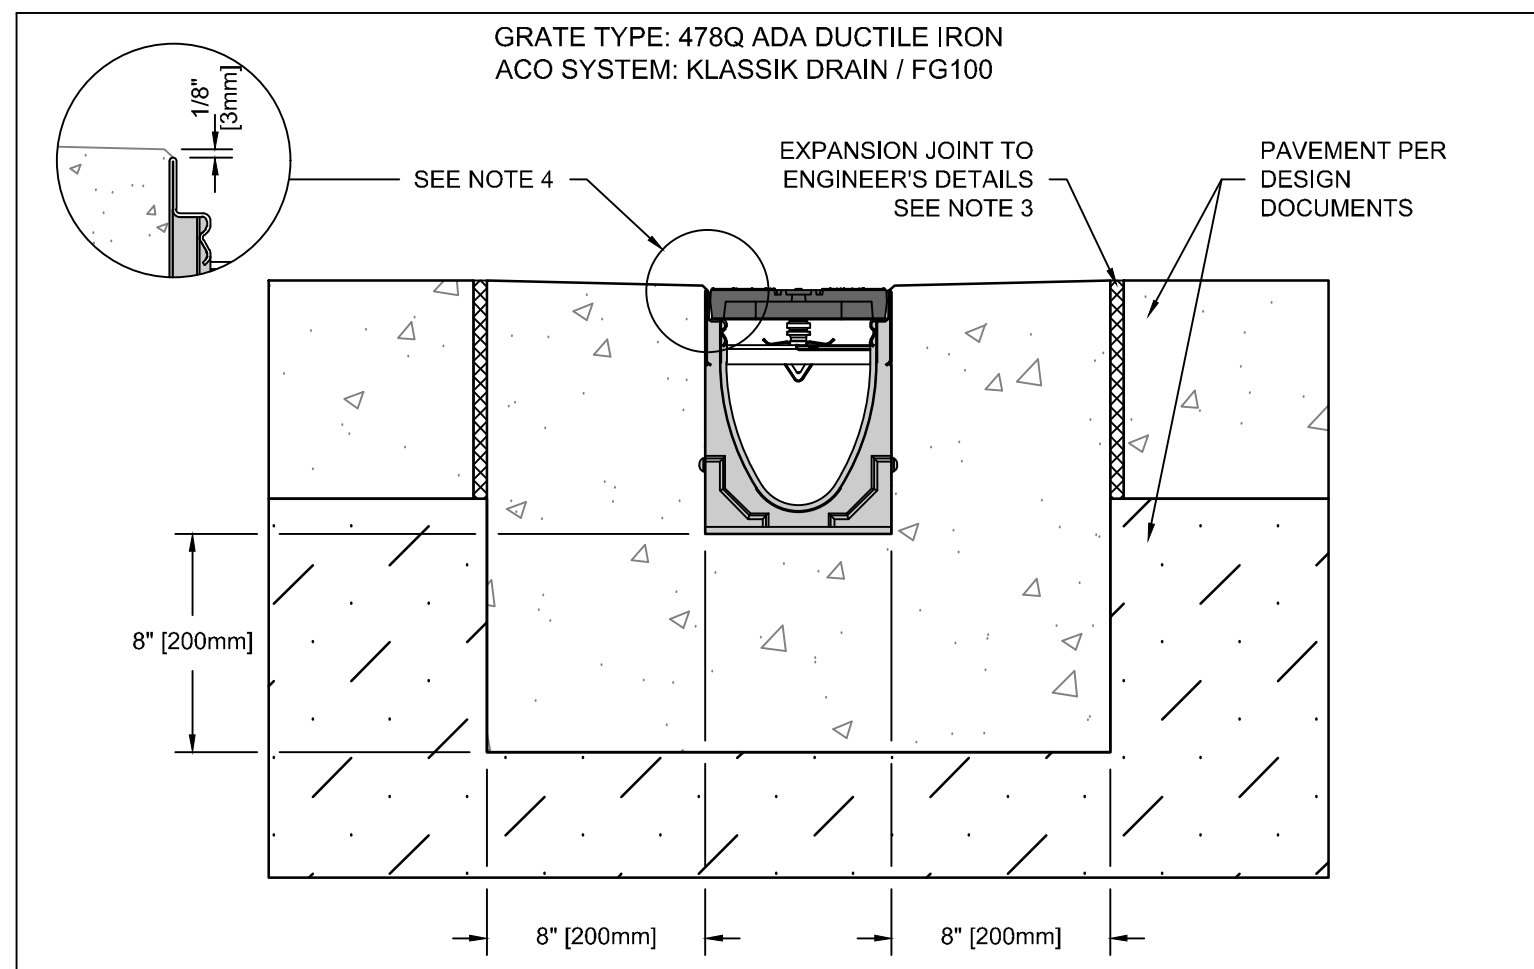K100 KLASSIKDRAIN - LOAD CLASS E

GENERAL
THE SURFACE DRAINAGE SYSTEM SHALL BE POLYMER CONCRETE K100 CHANNEL SYSTEM WITH GALVANIZED STEEL EDGE RAILS AS MANUFACTURED BY ACO POLYMER PRODUCTS, INC.

MATERIALS
CHANNELS SHALL BE MANUFACTURED FROM POLYESTER RESIN POLYMER CONCRETE WITH AN INTEGRALLY CAST-IN GALVANIZED STEEL EDGE RAIL. MINIMUM PROPERTIES OF POLYMER CONCRETE WILL BE AS FOLLOWS:
COMPRESSIVE STRENGTH: 14,000 PSI
FLEXURAL STRENGTH: 4,000 PSI
TENSILE STRENGTH: 1,500 PSI
WATER ABSORPTION: 0.07%
FROST PROOF: YES
DILUTE ACID AND ALKALI RESISTANT: YES
B117 SALT SPRAY TEST COMPLIANT: YES

THE SYSTEM SHALL BE 4" (100mm) NOMINAL INTERNAL WIDTH WITH A 5.1" (130mm) OVERALL WIDTH AND A BUILT-IN SLOPE OF 0.5%. CHANNEL INVERT SHALL HAVE DEVELOPED "V" SHAPE. ALL CHANNELS SHALL BE INTERLOCKING WITH A MALE/FEMALE JOINT.

THE COMPLETE DRAINAGE SYSTEM SHALL BE BY ACO POLYMER PRODUCTS, INC. ANY DEVIATION OR PARTIAL SYSTEM DESIGN AND/OR IMPROPER INSTALLATION WILL VOID ANY AND ALL WARRANTIES PROVIDED BY ACO POLYMER PRODUCTS, INC.


CHANNEL SHALL WITHSTAND LOADING TO PROPER LOAD CLASS AS OUTLINED BY EN 1433. GRATE TYPE SHALL BE APPROPRIATE TO MEET THE SYSTEM LOAD CLASS SPECIFIED AND INTENDED APPLICATION. GRATES SHALL BE SECURED USING "QUICK-LOCK" BOLTLESS LOCKING SYSTEM. CHANNEL AND GRATE SHALL BE CERTIFIED TO MEET THE SPECIFIED EN 1433 LOAD CLASS. THE SYSTEM SHALL BE INSTALLED IN ACCORDANCE WITH THE MANUFACTURER'S INSTRUCTIONS AND REQUIREMENTS.

- NOTES:**
- IT IS NECESSARY TO ENSURE MINIMUM DIMENSIONS SHOWN ARE SUITABLE FOR EXISTING GROUND CONDITIONS.
 - ENGINEERING ADVICE MAY BE REQUIRED.
 - MINIMUM CONCRETE STRENGTH OF 4,000 PSI IS RECOMMENDED. CONCRETE SHOULD BE VIBRATED TO ELIMINATE AIR POCKETS.
 - EXPANSION AND CONTRACTION CONTROL JOINTS AND REINFORCEMENT ARE RECOMMENDED TO PROTECT CHANNEL AND CONCRETE SURROUND. ENGINEERING ADVICE MAY BE REQUIRED.
 - THE FINISHED LEVEL OF THE CONCRETE SURROUND MUST BE APPROX. 1/8" (3mm) ABOVE THE TOP OF THE CHANNEL EDGE.
 - CONCRETE BASE THICKNESS SHOULD MATCH SLAB THICKNESS. ENGINEERING ADVICE MAY BE REQUIRED TO DETERMINE PROPER LOAD CLASS.
 - REFER TO ACO'S LATEST INSTALLATION INSTRUCTIONS FOR FURTHER DETAILS.

TRENCH DRAIN

NO SCALE

7

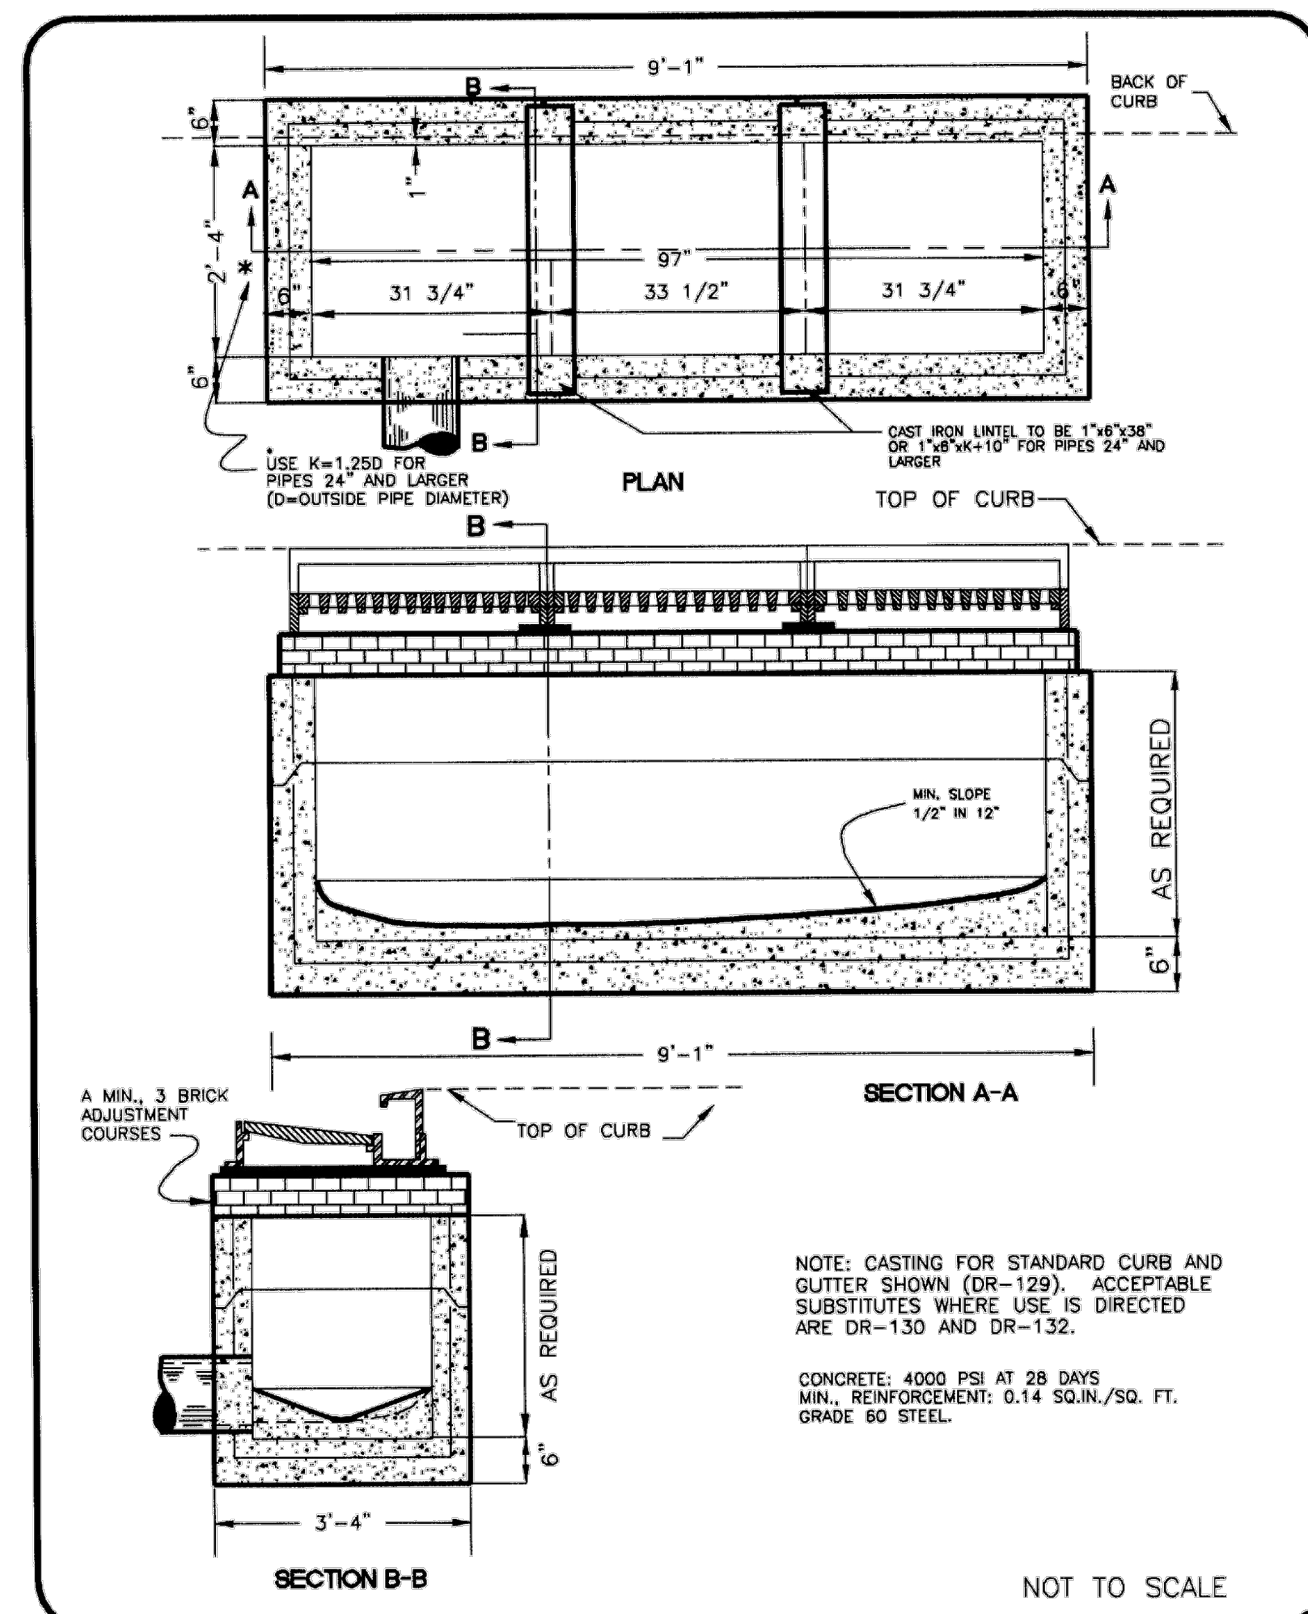


METROPOLITAN GOVERNMENT OF NASHVILLE AND DAVIDSON COUNTY DEPARTMENT OF PUBLIC WORKS
TRIPLE INLET (PRECAST)
DWG. NO. DR-115
ASST. DIR. ENG. DATE: 3/14/00
DIRECTOR: DATE: 3/14/00
REVISED: 03/02/00

4

TRIPLE CATCH BASIN


NO SCALE

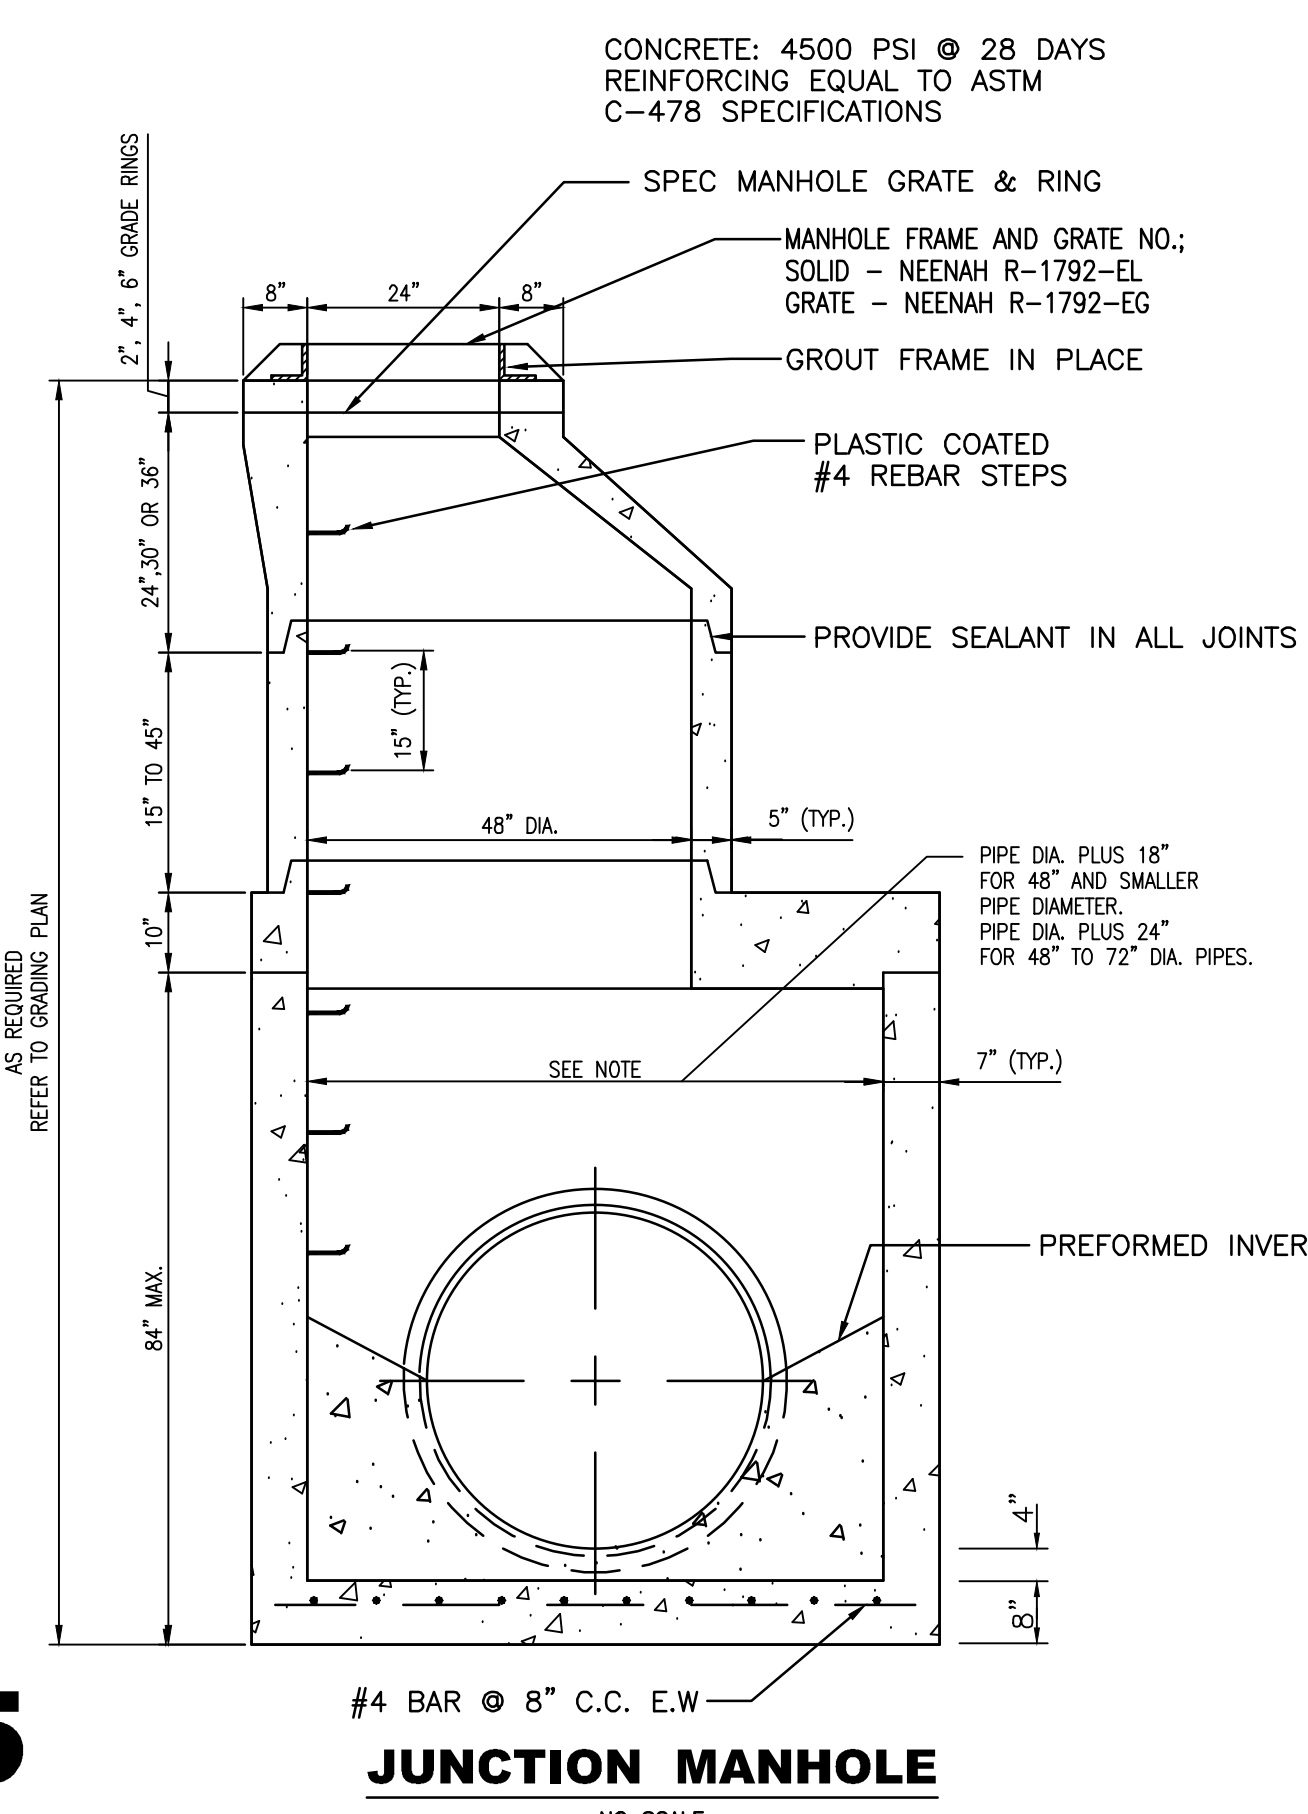

5

JUNCTION MANHOLE

NO SCALE

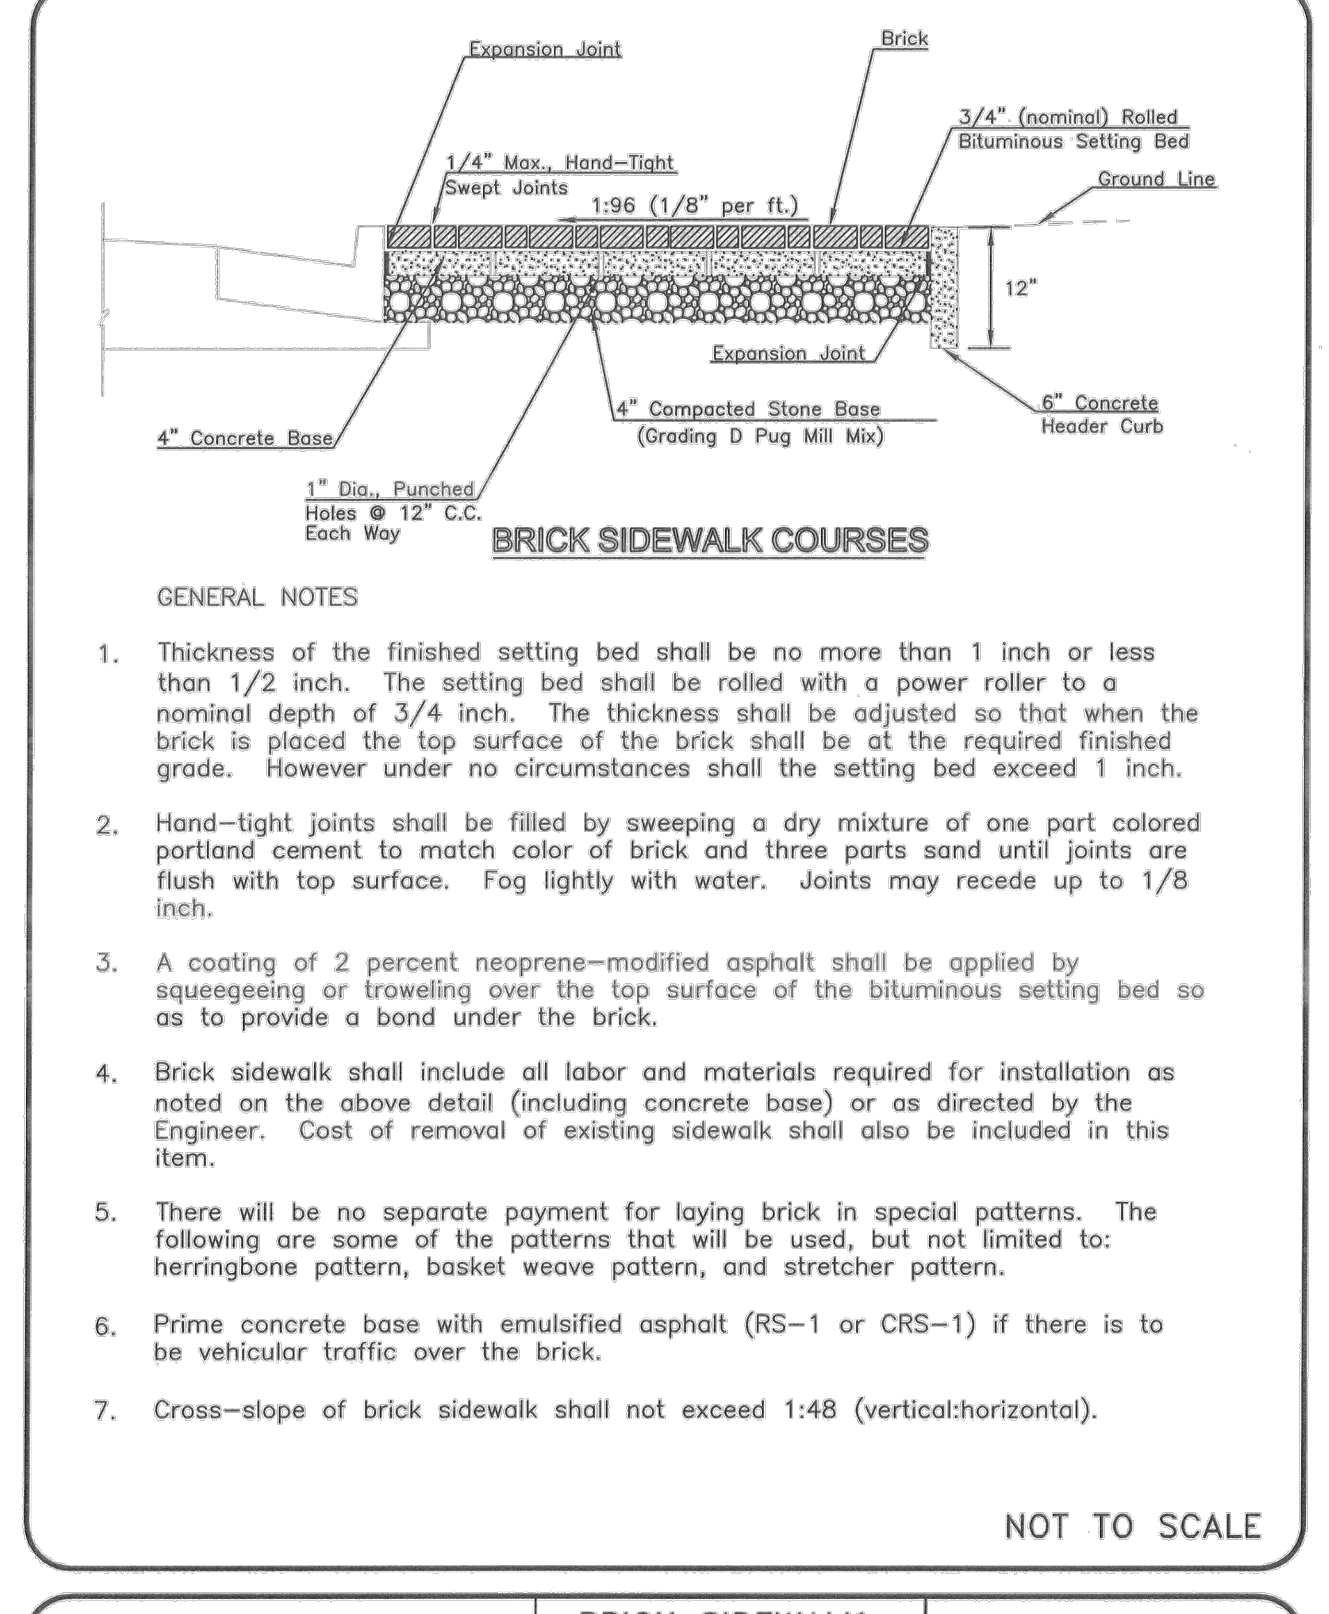


METROPOLITAN GOVERNMENT OF NASHVILLE AND DAVIDSON COUNTY DEPARTMENT OF PUBLIC WORKS
BRICK SIDEWALK WITH CONCRETE BASE
DWG. NO. ST-500
DIR. OF ENG. DATE: 5/12/03
REVISED: 04/13/01
REVISED: 05/08/03
REVISED:

1

BRICK SIDEWALK DETAIL


NO SCALE

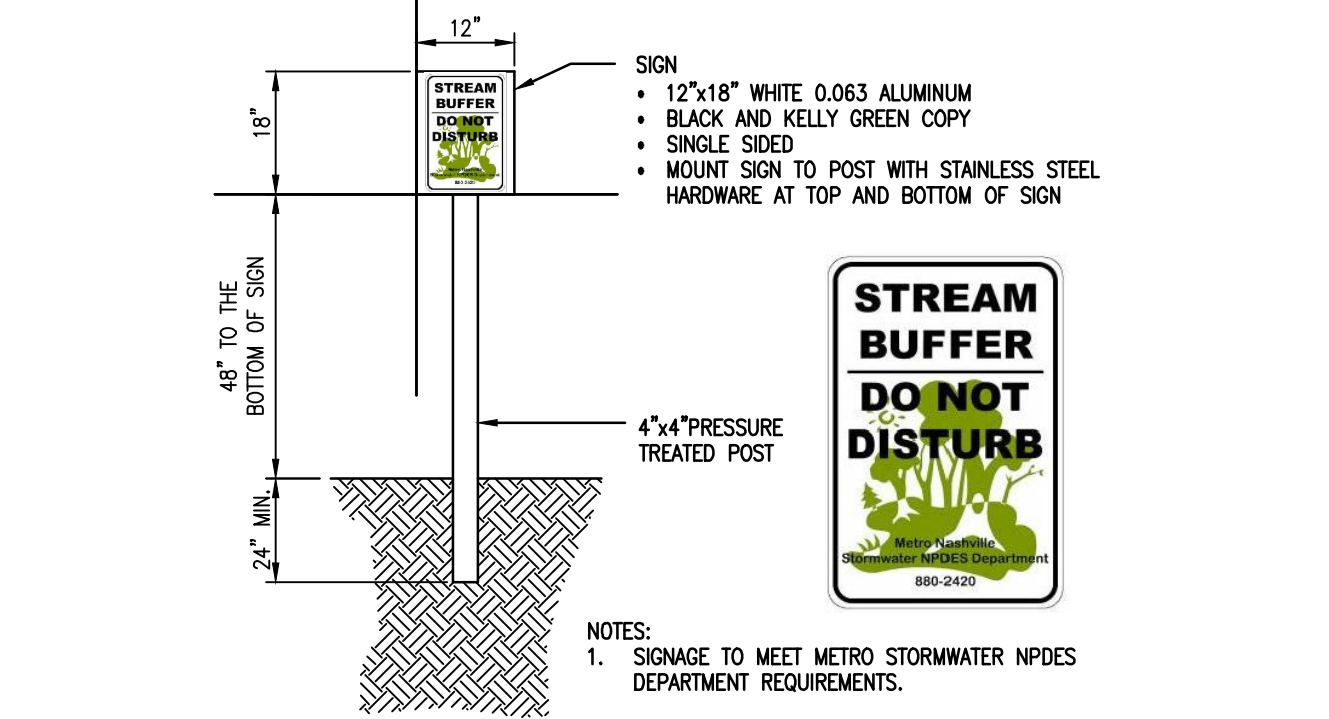

2

METRO BUFFER SIGN

NO SCALE

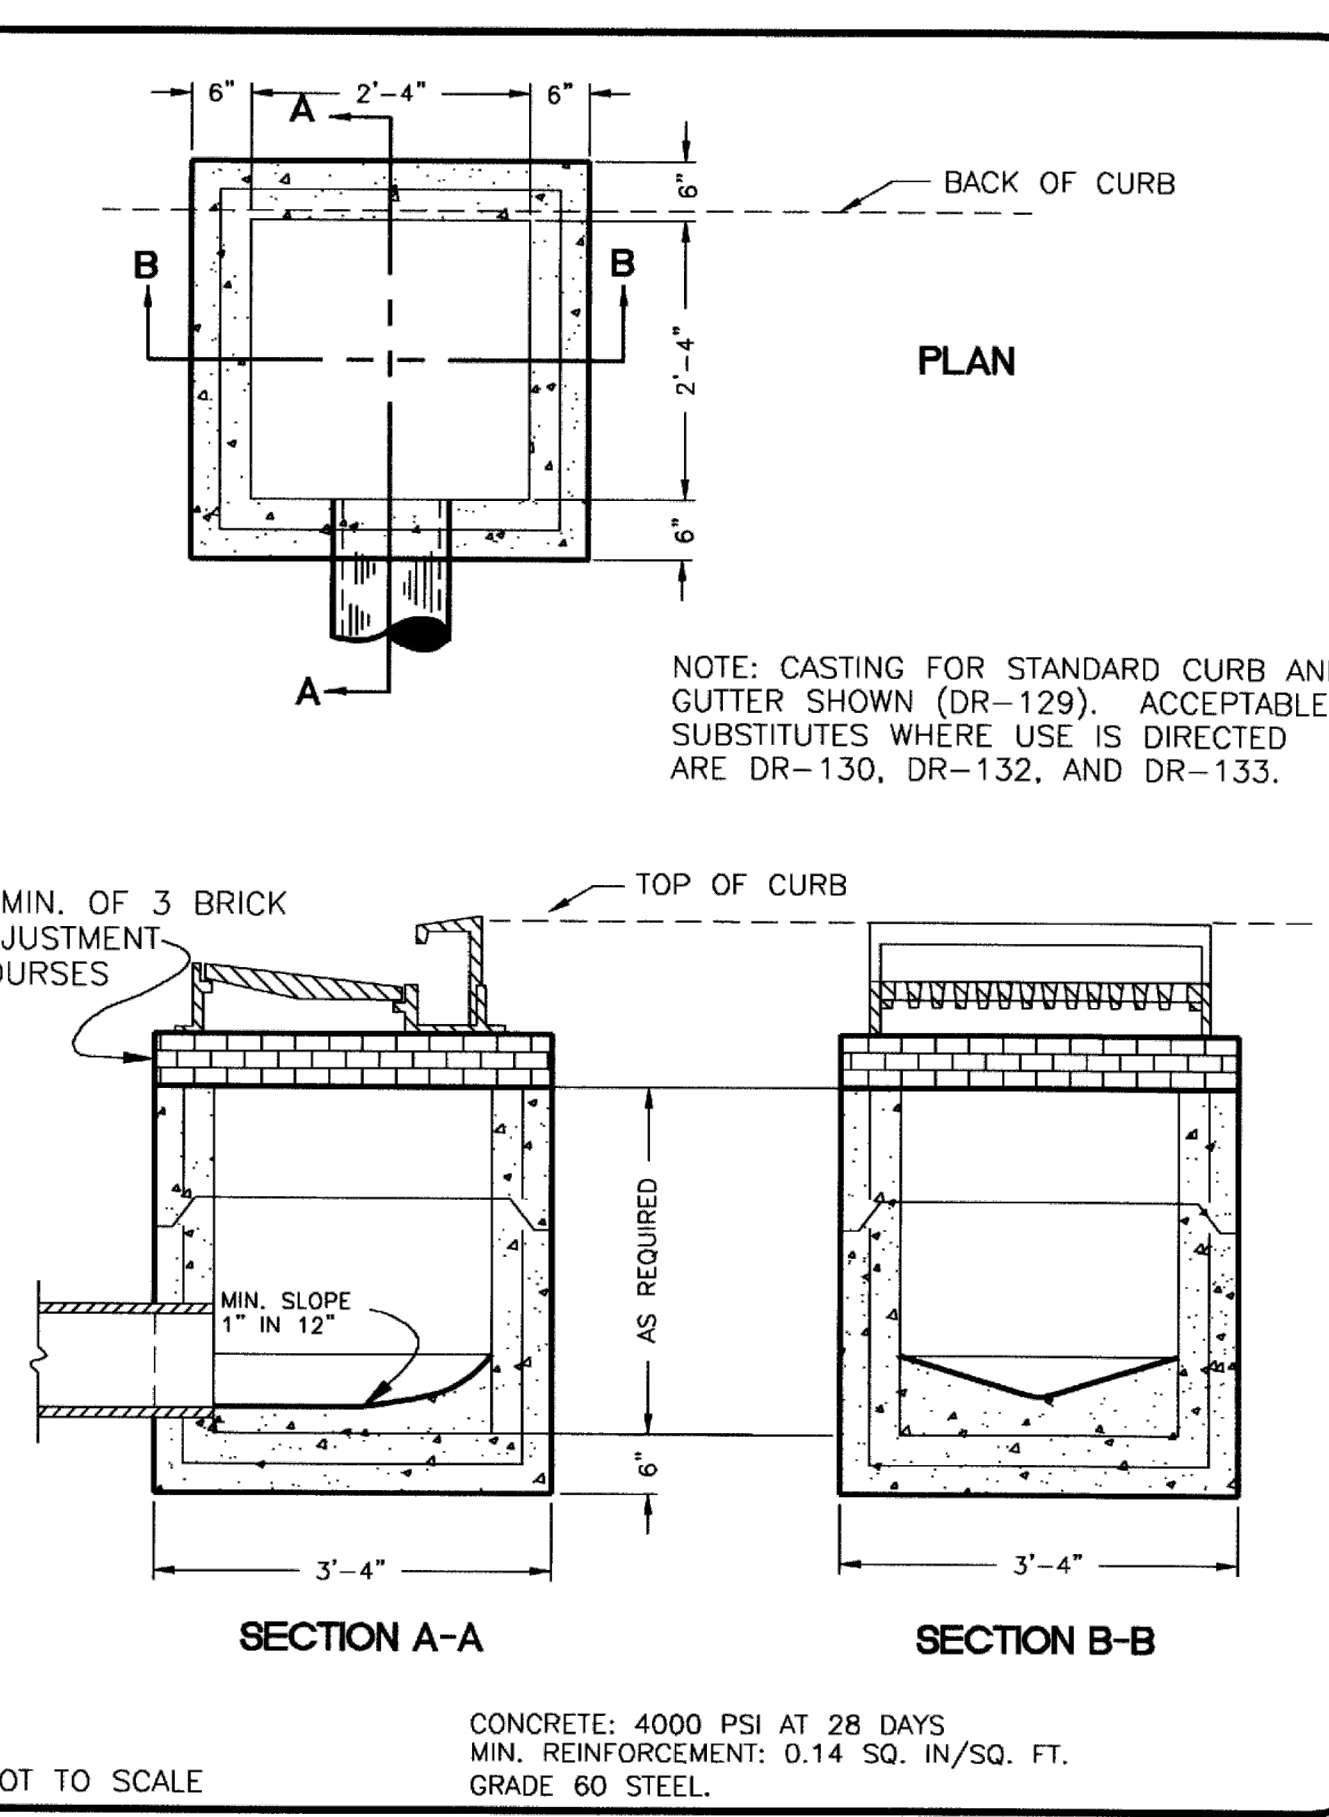

3

SINGLE CURB INLET


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METROPOLITAN GOVERNMENT OF NASHVILLE AND DAVIDSON COUNTY DEPARTMENT OF PUBLIC WORKS
SINGLE INLET (PRECAST)
DWG. NO. DR-105
ASST. DIR. ENG. DATE: 3/14/00
DIRECTOR: DATE: 3/14/00
REVISED: 02/08/00

10

RESERVED


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11

NYLOPLAST DRAIN W/PEDESTRIAN GRATE

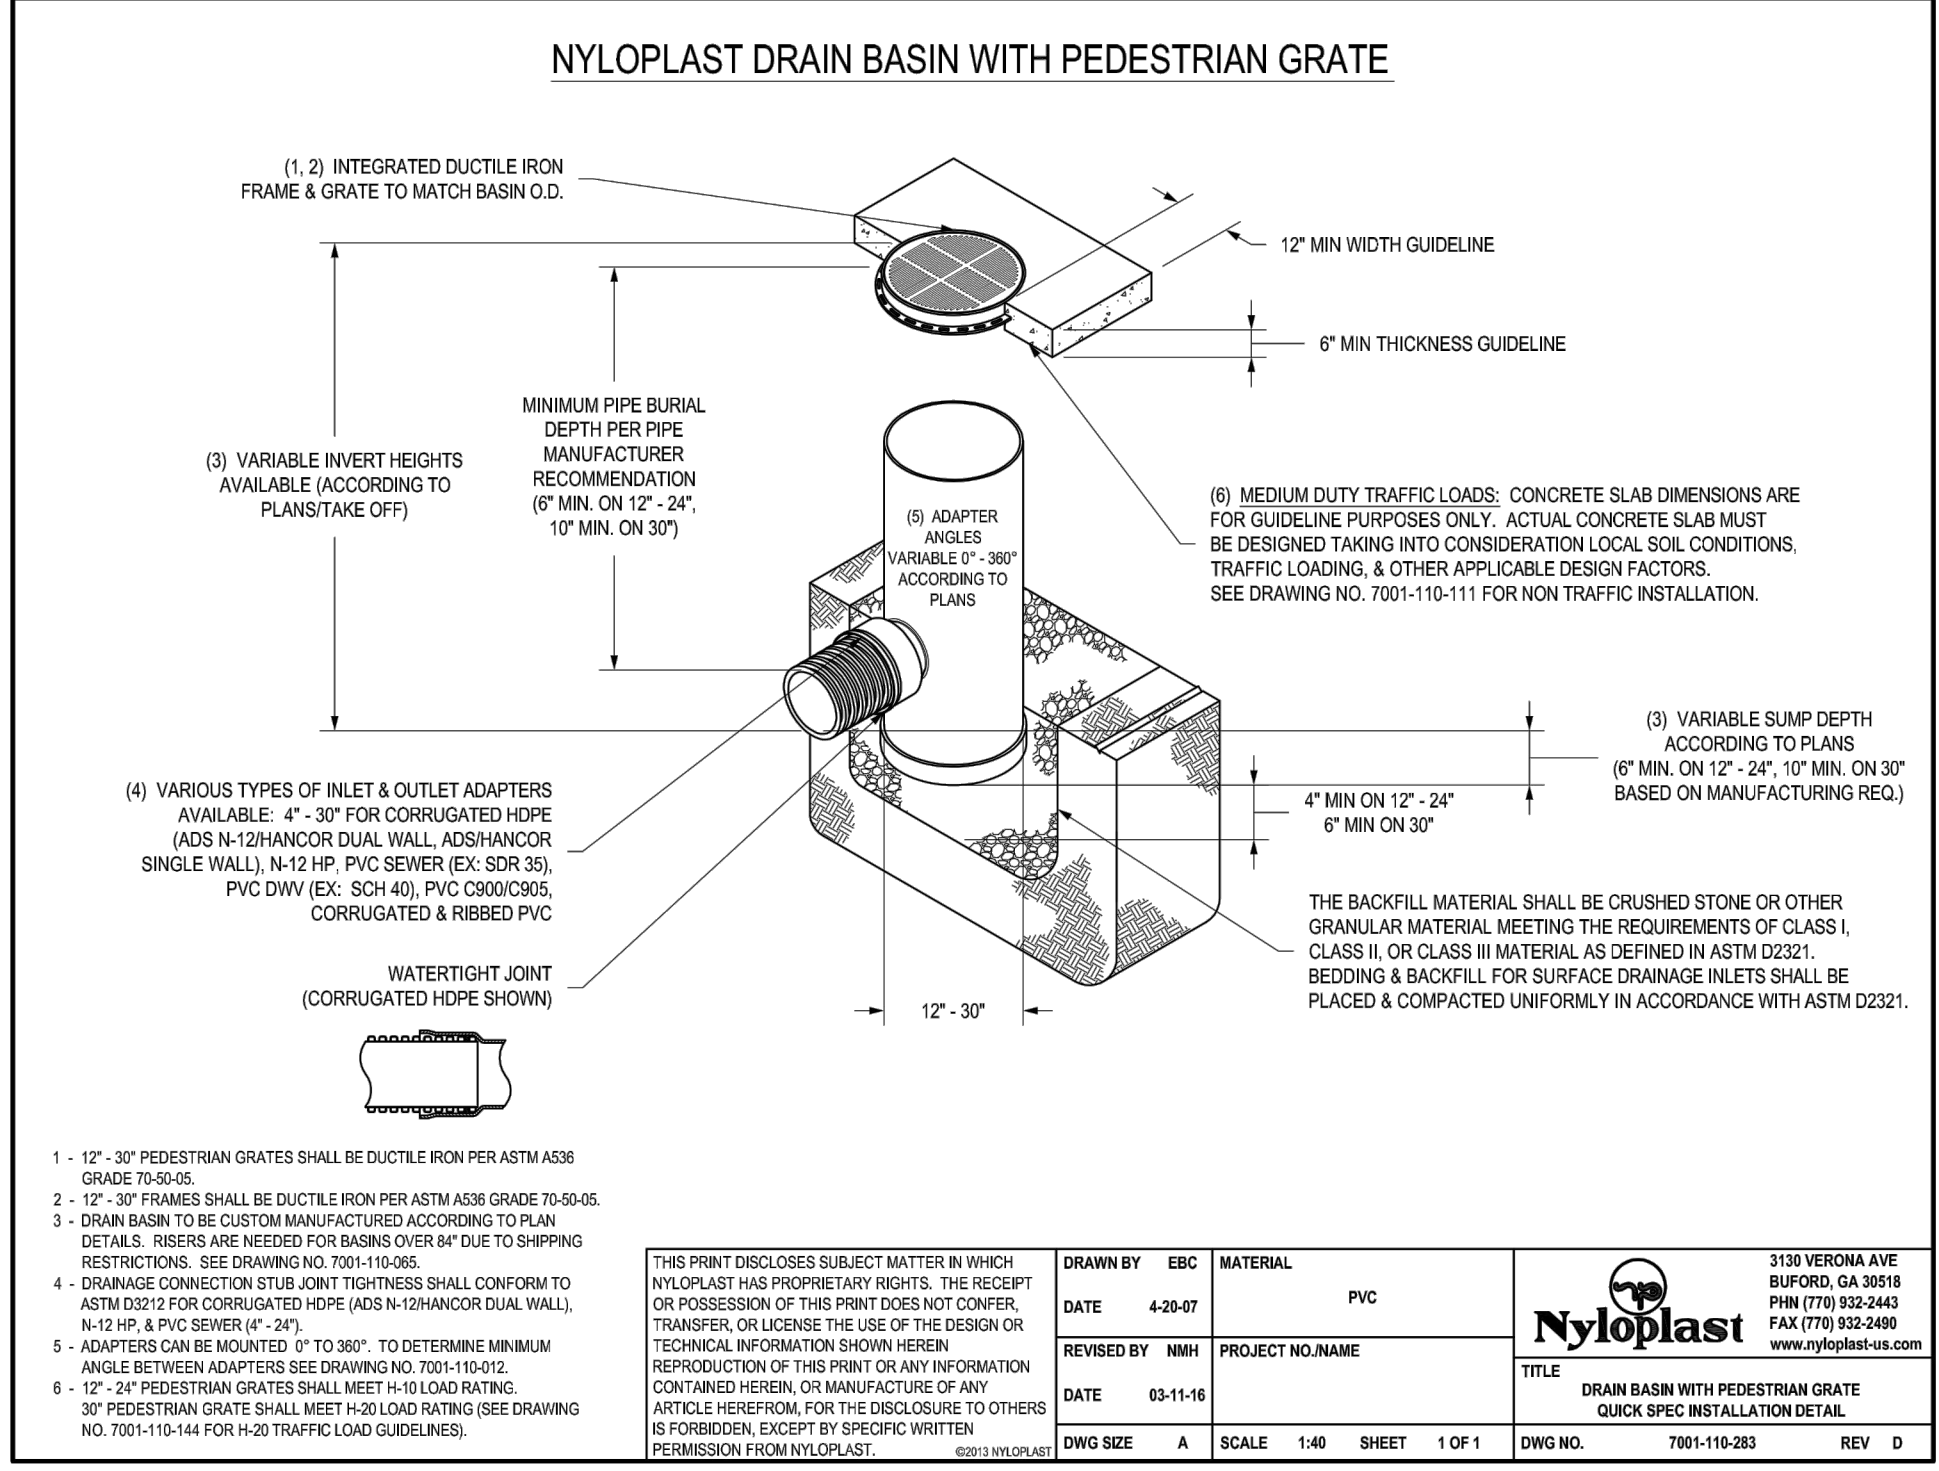
NO SCALE



8

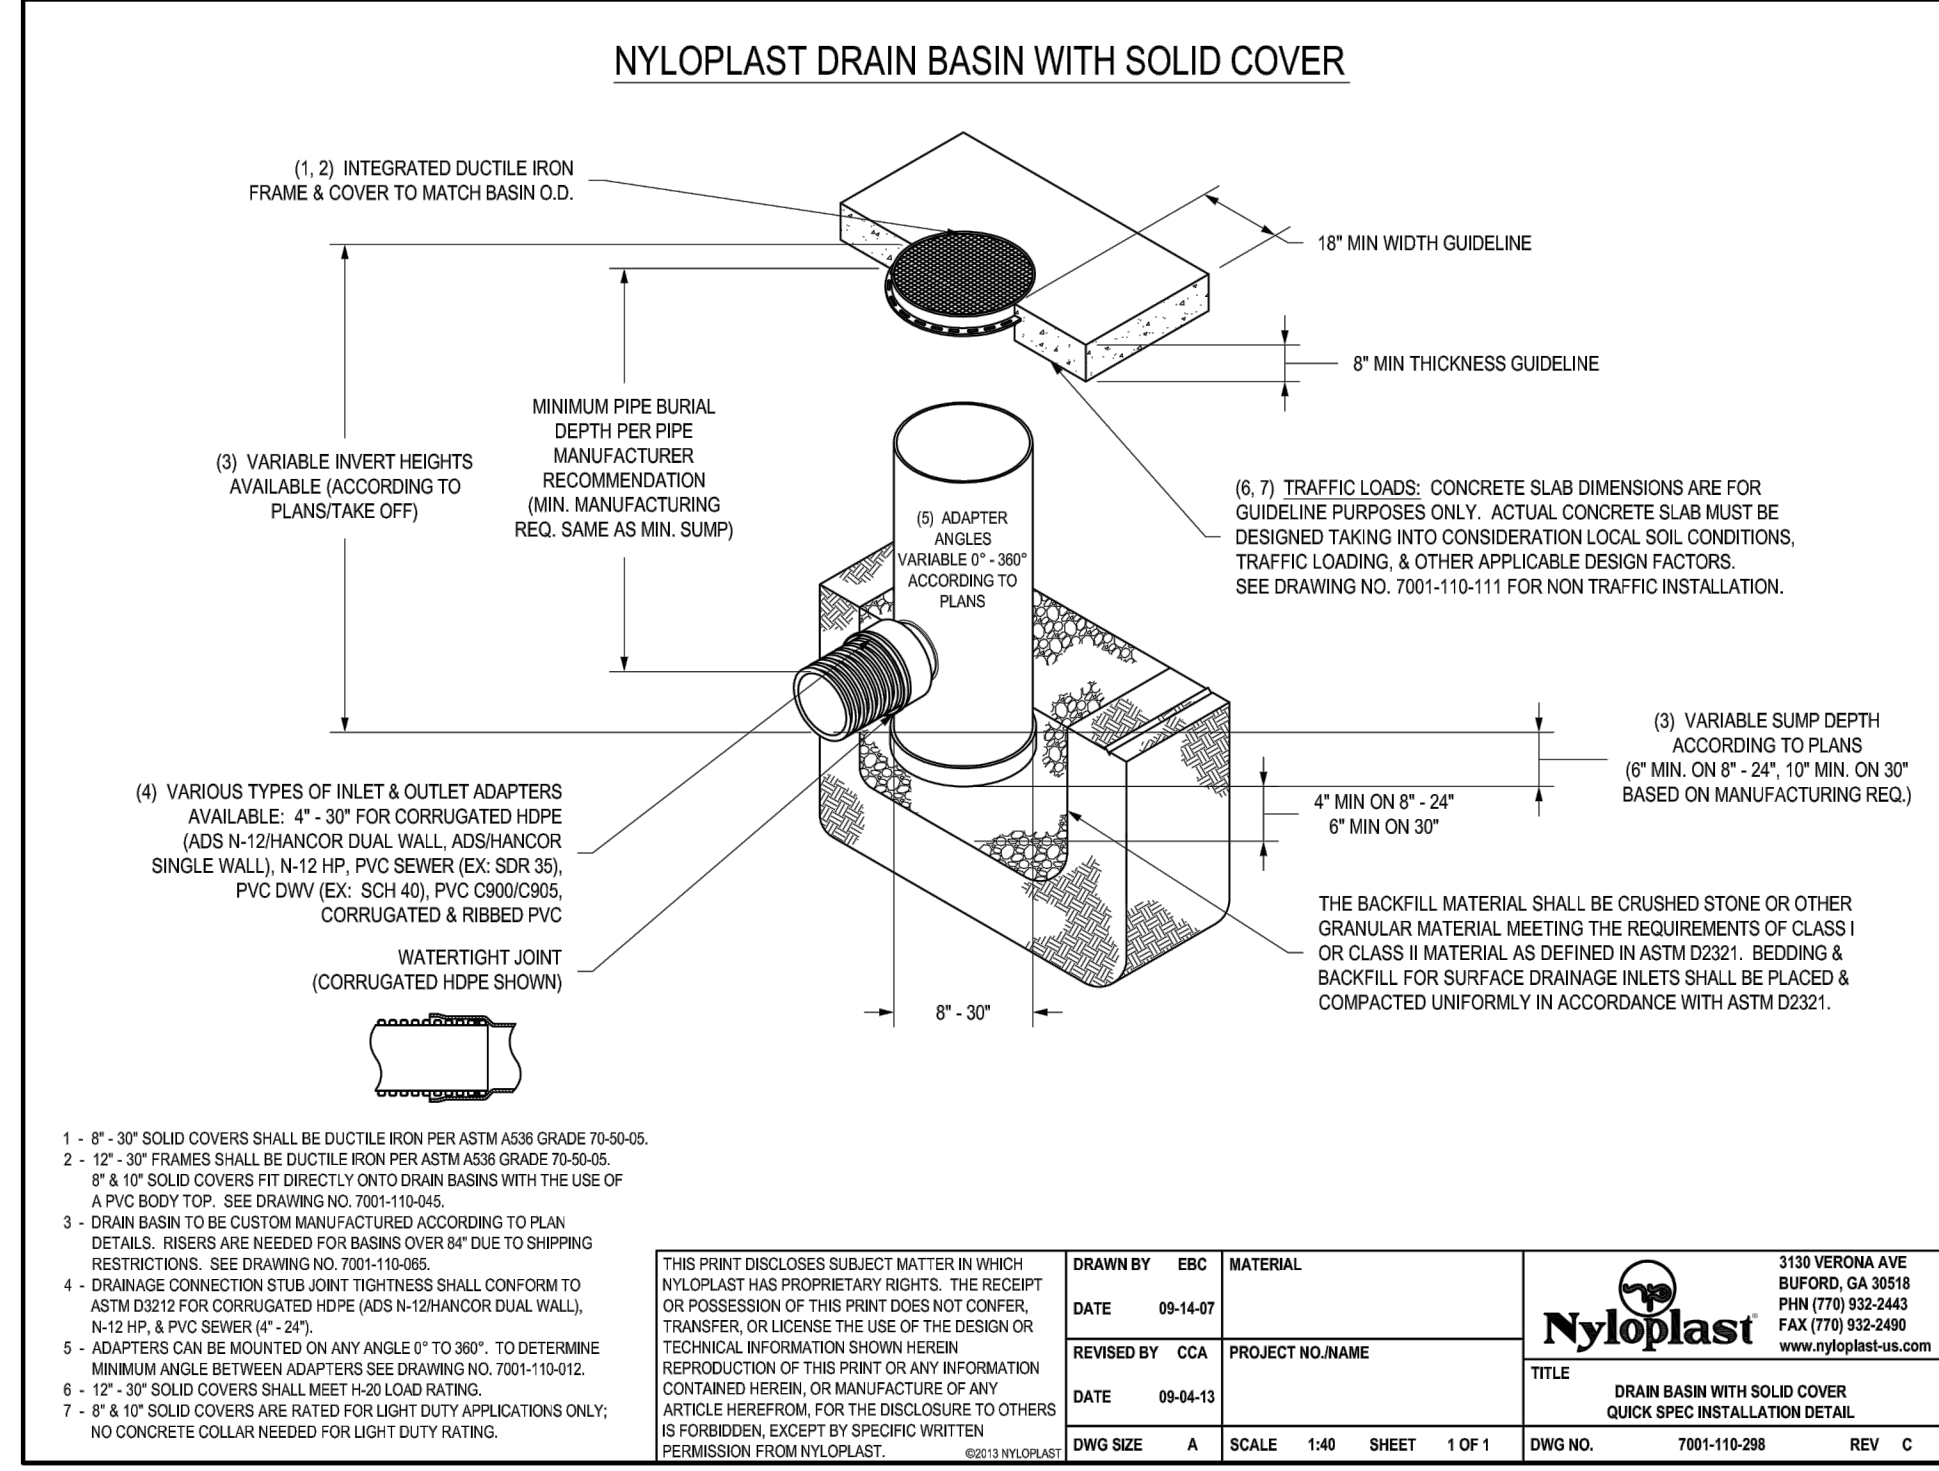NYLOPLAST DRAIN MANHOLE

NO SCALE

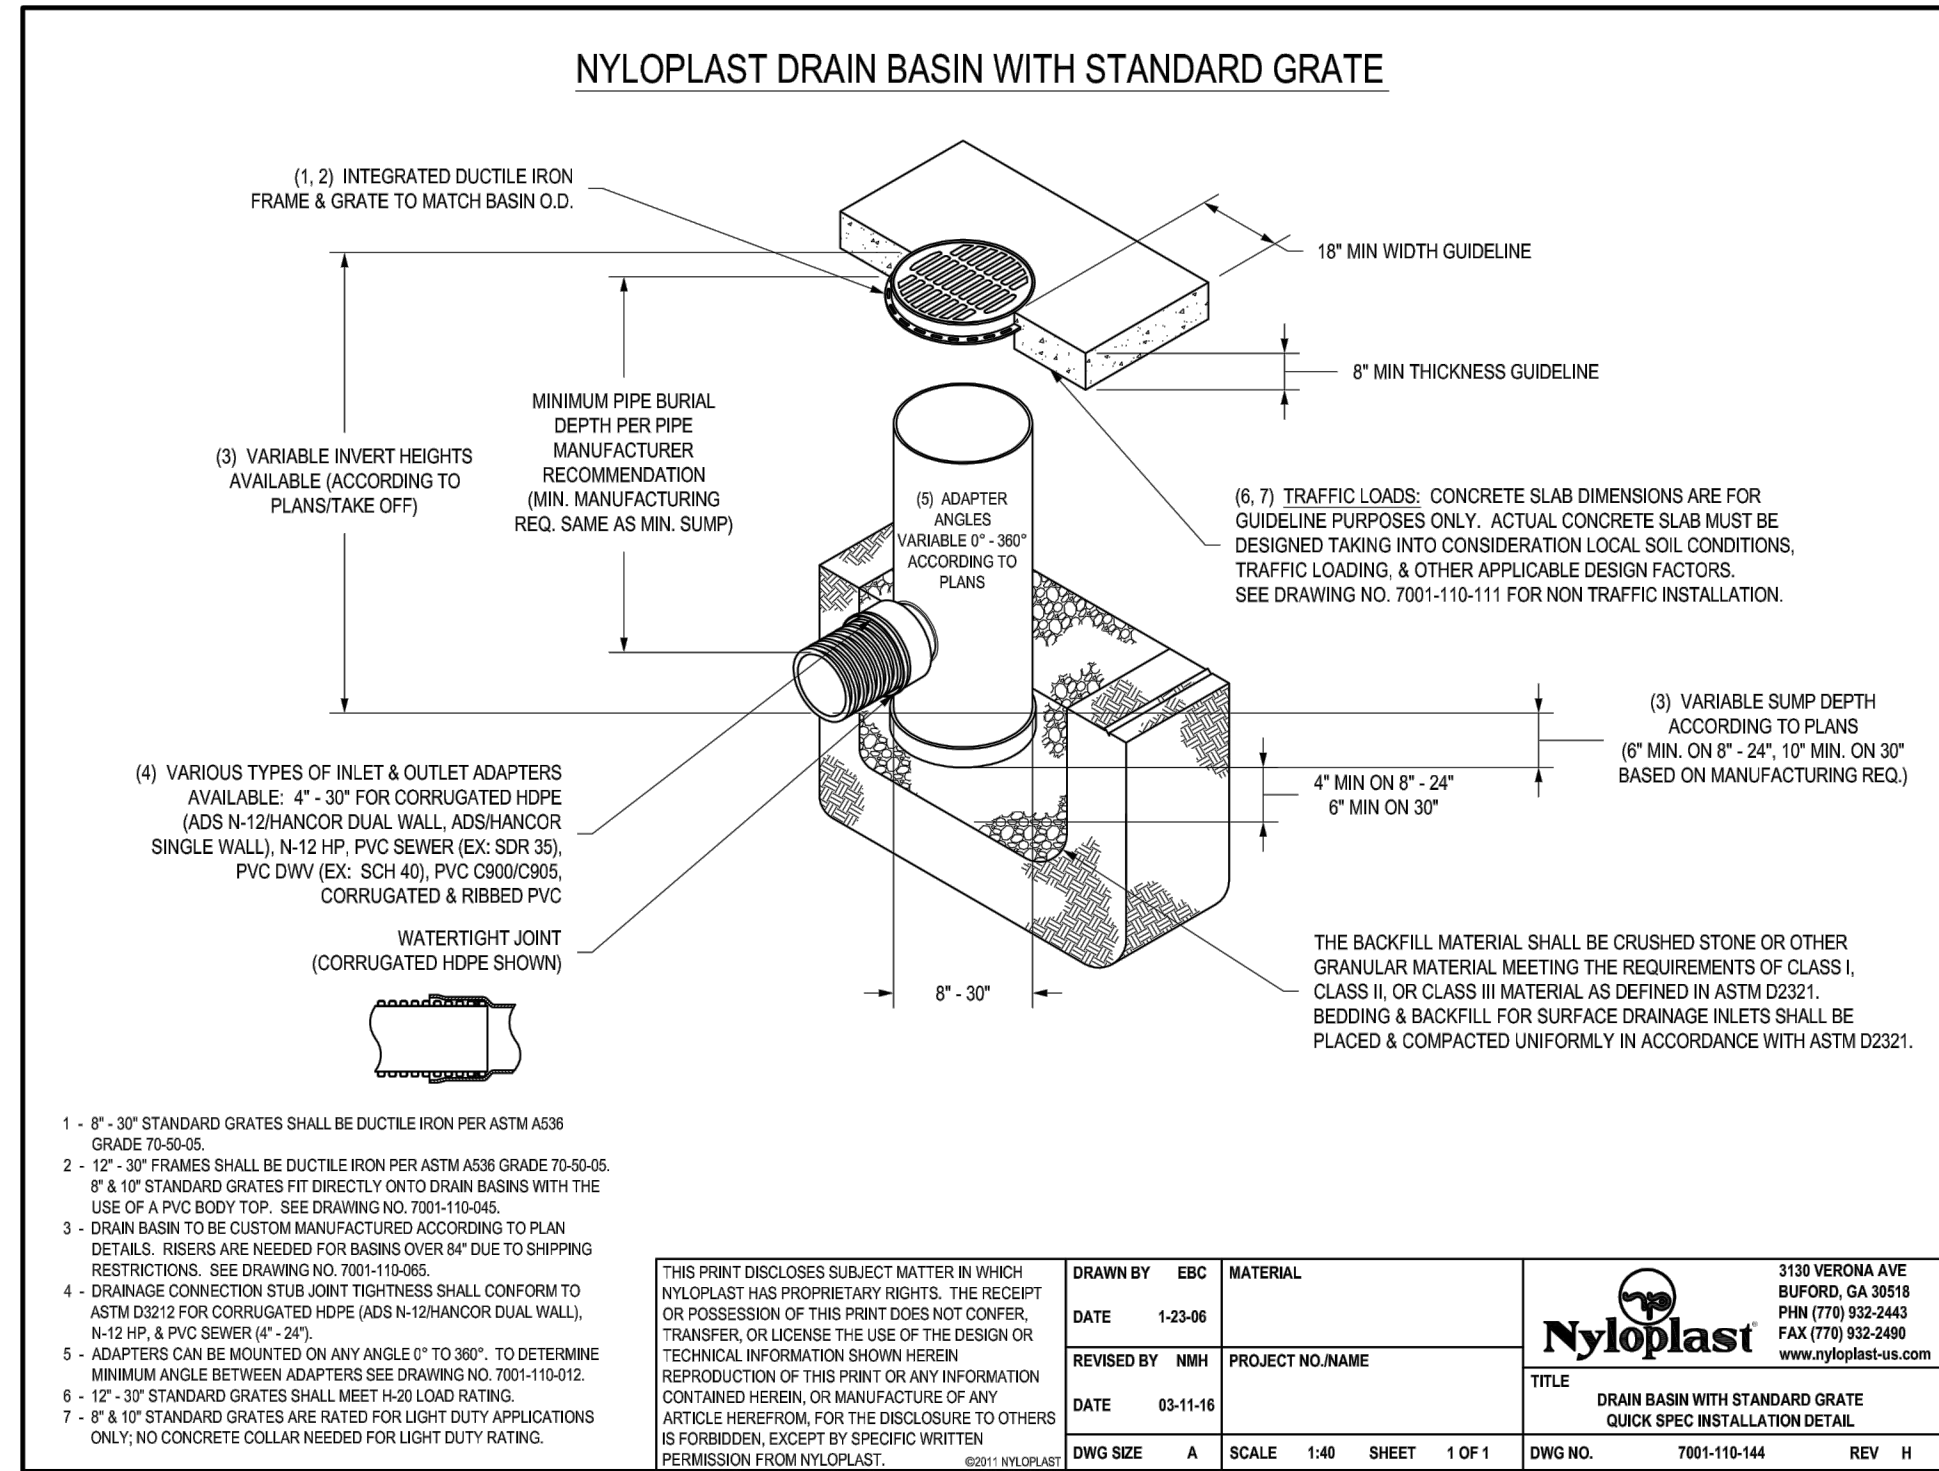

9

NYLOPLAST DRAIN W/ STANDARD GRATE

NO SCALE

6


RESERVED

NO SCALE

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Case No: 2016SP-005-003
SP PLAN AMENDMENT
HAMMER MILL MULTIFAMILY
NASHVILLE, DAVIDSON COUNTY, TENNESSEE

Gateway TBR
Hammer Mill, GP
1575 NORTHSIDE DRIVE
BUILDING 100, SUITE 200
ATLANTA, GA 30318

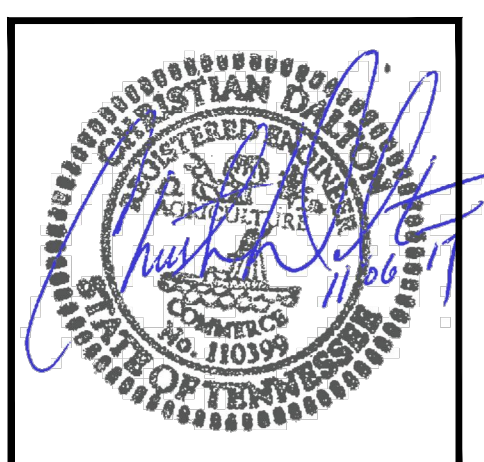

DATE	REVISIONS
2017.09.28	20150950

C8.1
SITE DETAILS

G:\Projects\2015\20150950\Drawings\Final_SP_Amendment\20150950_A-FSP_CB.2_DTL Nov. 06. 2017 - 2:35pm.dwg

ACCESS OPENING SPECIFICATION

- A TYPICAL ACCESS OPENING FOR THE STORMTRAP SYSTEM AND 2.0 IN. DIAMETER ACCESS OPENINGS SHOULD BE PROVIDED TO THE STORMTRAP SYSTEM. ALL OPENINGS MUST BE AT LEAST 1 FT. OF CLEARANCE IN ALL DIRECTIONS FROM THE EDGE OF THE STORMTRAP UNIT.
- ALL ACCESS OPENINGS SHALL BE PROVIDED WITH A 1.5 IN. DIA. CONCRETE COLLAR (1.5" DIA. CONCRETE COLLAR) AND A 1.5 IN. DIA. CONCRETE COLLAR (1.5" DIA. CONCRETE COLLAR) SHALL BE PROVIDED TO THE STORMTRAP UNIT. ALL COLLARS SHALL BE FINISHED TO MATCH THE FINISH OF THE SURROUNDING CONCRETE.
- STORMTRAP UP/INLET RESISTS MAY BE RELOCATED TO CONDUIT WITH THE ACCESS OPENING ON THE CENTER OF GRAVITY OF THE PIPE AS NEEDED.
- STORMTRAP ACCESS OPENINGS MAY BE RELOCATED TO AVOID INTERFERENCE WITH PALET AND/OR OUTLET PIPE OPENINGS BY PLACEMENT OF STAIRS OR RAMPWALKS.
- ACCESS OPENINGS SHOULD BE LOCATED IN ORDER TO MEET THE APPROPRIATE DESIGN AND CONSTRUCTION REQUIREMENTS AT LEAST ONE ACCESS OPENING ON EACH SIDE ACCESSIBLE BY THE USER.
- USE PRECAST ADJUSTING BRINGS AS NEEDED TO MEET GRADE. STORMTRAP RECOMMENDS FOR CONCRETE TO USE PRECAST BRINGS (OPTIONAL SECTION BY OTHER).

PIPE OPENING SPECIFICATION

- MINIMUM PIPE OVERLAP FOR PIPE OPENING ON THE OUTSIDE WALL SHALL BE NO LESS THAN 10".
- MINIMUM OVERLAP SHALL BE DETERMINED BY UNIT WEIGHT. REFERENCED OPENING SIZE SHOULD BE TO THE ATTENTION OF STORMTRAP FOR DETAILS.
- CONCRETE PIPE SHALL BE FINISHED TO MATCH THE FINISH OF THE COLLAR AND AROUND THE COLLAR WITH AT LEAST ONE PIPE LENGTH. A 1.5 IN. DIA. CONCRETE COLLAR SHALL BE USED WITH A MINIMUM OF 4" OVERLAP FROM THE END OF THE PIPE TO THE COLLAR.
- THE ANNUAL SPACE BETWEEN THE PIPE AND THE HOLE SHALL BE FILLED WITH NON-SHRINK GROUT.

RECOMMENDED PIPE INSTALLATION INSTRUCTIONS

- CLEAN AND LIGHTLY OIL OR TANK TO ALLOW NO SHARP EDGES, SEVEL AND LUBRICATE LAYOUT OF PIPE.
- ALIGN CENTER OF PIPE TO CONNECTION LOCATION AND INSERT INTO OPENING.

STORMTRAP INSTALLATION SPECIFICATION

- STORMTRAP MODULES SHALL BE MANUFACTURED ACCORDING TO SHOP DRAWINGS APPROVED BY THE DESIGN PROFESSIONAL AND INSURED. THE SHOP DRAWINGS SHALL INDICATE SIZE AND LOCATION OF HOOR OPENINGS AND PALET OUTLET PIPE OPENINGS.
- STORMTRAP SHALL BE INSTALLED IN ACCORDANCE WITH THE PRECAST CONCRETE INSTALLATION SPECIFICATION AND THE FOLLOWING ADDITIONAL REQUIREMENTS SHALL APPLY:
 - INSTALLATION ON THE ENGINEER'S DRAWINGS SHALL TAKE PRECEDENCE.
 - STORMTRAP SHALL BE PLACED ON A LEVEL SURFACE OR A CONCRETE SLAB. THE SURFACE SHALL BE FINISHED TO MATCH THE FINISH OF THE SURROUNDING CONCRETE.
 - THE STORMTRAP MODULES SHALL BE PLACED SUCH THAT THE MAXIMUM SPACE BETWEEN THE MODULES IS 8" (SEE NOTE 1).
 - THE ENGINEER'S HORIZONTAL JOINT OF THE STORMTRAP MODULES SHALL BE SEATED TO THE FOUNDATION WITH PRECAST BRINGS, JOINT SEALER AND/OR WITH ANOTHER APPROVED METHOD. STORMTRAP SHALL BE INSTALLED TO PROVIDE PROPER DRAINAGE AND TO PROTECT THE STORMTRAP FROM EXCESSIVE WATER INFLUX.
 - A WEIR LANE SHALL BE PROVIDED TO PROTECT THE STORMTRAP FROM EXCESSIVE WATER INFLUX. THE WEIR LANE SHALL BE FINISHED TO MATCH THE FINISH OF THE SURROUNDING CONCRETE.
- THE FULL GROUT AROUND THE STORMTRAP UNITS MUST BE DEPOSITED ON BOTH SIDES OF THE UNIT AND TO APPROXIMATELY THE SAME ELEVATION AS THE TOP OF THE UNIT. THE FULL GROUT SHALL BE MORE THAN 2" DEEP FROM THE PALET ON THE CONCRETE SLAB. GROUT SHALL BE COMPACTED TO THE PROPER DENSITY BY OTHER MEANS TO STORMTRAP INSTALLATION.
- ALL DIMENSIONS AND BOLTS CONDITIONS INCLUDING BUT NOT LIMITED TO THE DIMENSIONS AND BOLTS CONDITIONS SHALL BE AS SHOWN ON THE DRAWINGS AND SHALL BE SUBJECT TO THE STORMTRAP MANUFACTURER'S REVISIONS.
- FOR STRUCTURAL CALCULATIONS THE SOIL DENSITY IS ASSUMED TO BE 120 PCF.
- FOR STRUCTURAL CALCULATIONS THE WATER TABLE IS ASSUMED TO BE 150 PCF.
- STORMTRAP LATEST MATERIALS. CONTACT STORMTRAP FOR WATERPROOFING OPTIONS. WATERPROOFING APPLICATION TO BE PROVIDED BY OTHERS.

STORMTRAP SPECIFICATION

- TOTAL COVER MIN. 5.0' MAX. 5.0' CONSULT STORMTRAP FOR ADDITIONAL COVER OPTIONS.
- CONCRETE CHAMBER DESIGNED FOR 4000 PSI MINIMUM STRENGTH CONCRETE.
- ALL DIMENSIONS AND BOLTS CONDITIONS INCLUDING BUT NOT LIMITED TO THE DIMENSIONS AND BOLTS CONDITIONS SHALL BE AS SHOWN ON THE DRAWINGS AND SHALL BE SUBJECT TO THE STORMTRAP MANUFACTURER'S REVISIONS.
- FOR STRUCTURAL CALCULATIONS THE SOIL DENSITY IS ASSUMED TO BE 120 PCF.
- FOR STRUCTURAL CALCULATIONS THE WATER TABLE IS ASSUMED TO BE 150 PCF.
- STORMTRAP LATEST MATERIALS. CONTACT STORMTRAP FOR WATERPROOFING OPTIONS. WATERPROOFING APPLICATION TO BE PROVIDED BY OTHERS.

HAMMER MILL MF
NASHVILLE, TN

DESIGN ASSUMPTIONS
COVER: MIN. 5.0' MAX. 5.0'
GROUNDWATER TABLE: BELOW SYSTEM INVERT
SOIL PRESSURE: 120 PCF
LOADING: HEADWIND LOAD

SHEET INDEX	REV.
1.00 COVER SHEET	1
2.00 DOUBLETRAP INSTALLATION SPECIFICATIONS	1
3.00 DOUBLETRAP PRELIMINARY SPECIFICATIONS	1
4.00 STANDARD 8" DOUBLETRAP UNIT TYPES	1

JOB SITE INFORMATION
DESCRIPTION: HAMMER MILL MF
JOB ADDRESS: NASHVILLE, TN
ENGINEERING OR CONTACT NAME: JEN HILL
CONTACT PHONE: 615.441.4620
CONTACT FAX: 615.441.4620
STORMTRAP MANUFACTURER: STORMTRAP
CONTACT NAME: SCOTT PANKALL
CONTACT PHONE: 504.899.8888
CONTACT EMAIL: SPANKALL@STORMTRAP.COM
WATER STORAGE PROVIDED: 7.94 CU YD (21,328 GAL)
WATER STORAGE HEAD: 4.10' ELEV. 417.00'
UNIT HEADROOM: 7.94' CU YD (21,328 GAL)
UNIT QUANTITY: 13 UNITS - 28 TOTAL PIECES

DESCRIPTION	REV.
1.00 COVER SHEET	1
2.00 DOUBLETRAP INSTALLATION SPECIFICATIONS	1
3.00 DOUBLETRAP PRELIMINARY SPECIFICATIONS	1
4.00 STANDARD 8" DOUBLETRAP UNIT TYPES	1

DOUBLETRAP INSTALLATION SPECIFICATIONS

REV.	DATE	DESC.	BY.
1	21 MAY 2016	PRELIMINARY	JPH
1	21 MAY 2016	PRELIMINARY	JPH

REV.	DATE	DESC.	BY.
1	21 MAY 2016	PRELIMINARY	JPH
1	21 MAY 2016	PRELIMINARY	JPH

REV.	DATE	DESC.	BY.
1	21 MAY 2016	PRELIMINARY	JPH
1	21 MAY 2016	PRELIMINARY	JPH

DOUBLETRAP INSTALLATION SPECIFICATIONS

REV.	DATE	DESC.	BY.
1	21 MAY 2016	PRELIMINARY	JPH
1	21 MAY 2016	PRELIMINARY	JPH

REV.	DATE	DESC.	BY.
1	21 MAY 2016	PRELIMINARY	JPH
1	21 MAY 2016	PRELIMINARY	JPH

REV.	DATE	DESC.	BY.
1	21 MAY 2016	PRELIMINARY	JPH
1	21 MAY 2016	PRELIMINARY	JPH

RECOMMENDED PIPE INSTALLATION INSTRUCTIONS

- CLEAN AND LIGHTLY OIL OR TANK TO ALLOW NO SHARP EDGES, SEVEL AND LUBRICATE LAYOUT OF PIPE.
- ALIGN CENTER OF PIPE TO CONNECTION LOCATION AND INSERT INTO OPENING.

STORMTRAP PRE-CAST DETENTION VAULT SYSTEM

NO SCALE

BYPASS WEIR STRUCTURE

NO SCALE

Littlejohn

An S&ME Company

1805 21st Avenue South, NASHVILLE, TENNESSEE 37212
F. 615.385.4444 E. 615.385.4020 www.littlejohn.com

HAMMER MILL MULTIFAMILY

NASHVILLE, DAVIDSON COUNTY, TENNESSEE

Case No: 2016SP-005-003
SP PLAN AMENDMENT

Gateway TBR Hammer Mill, GP


1575 NORTHSIDE DRIVE
BUILDING 100, SUITE 200
ATLANTA, GA 30318

DATE: 2017.09.28 REVISIONS: 20150950

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8


COMBINED SEWER CONNECTION

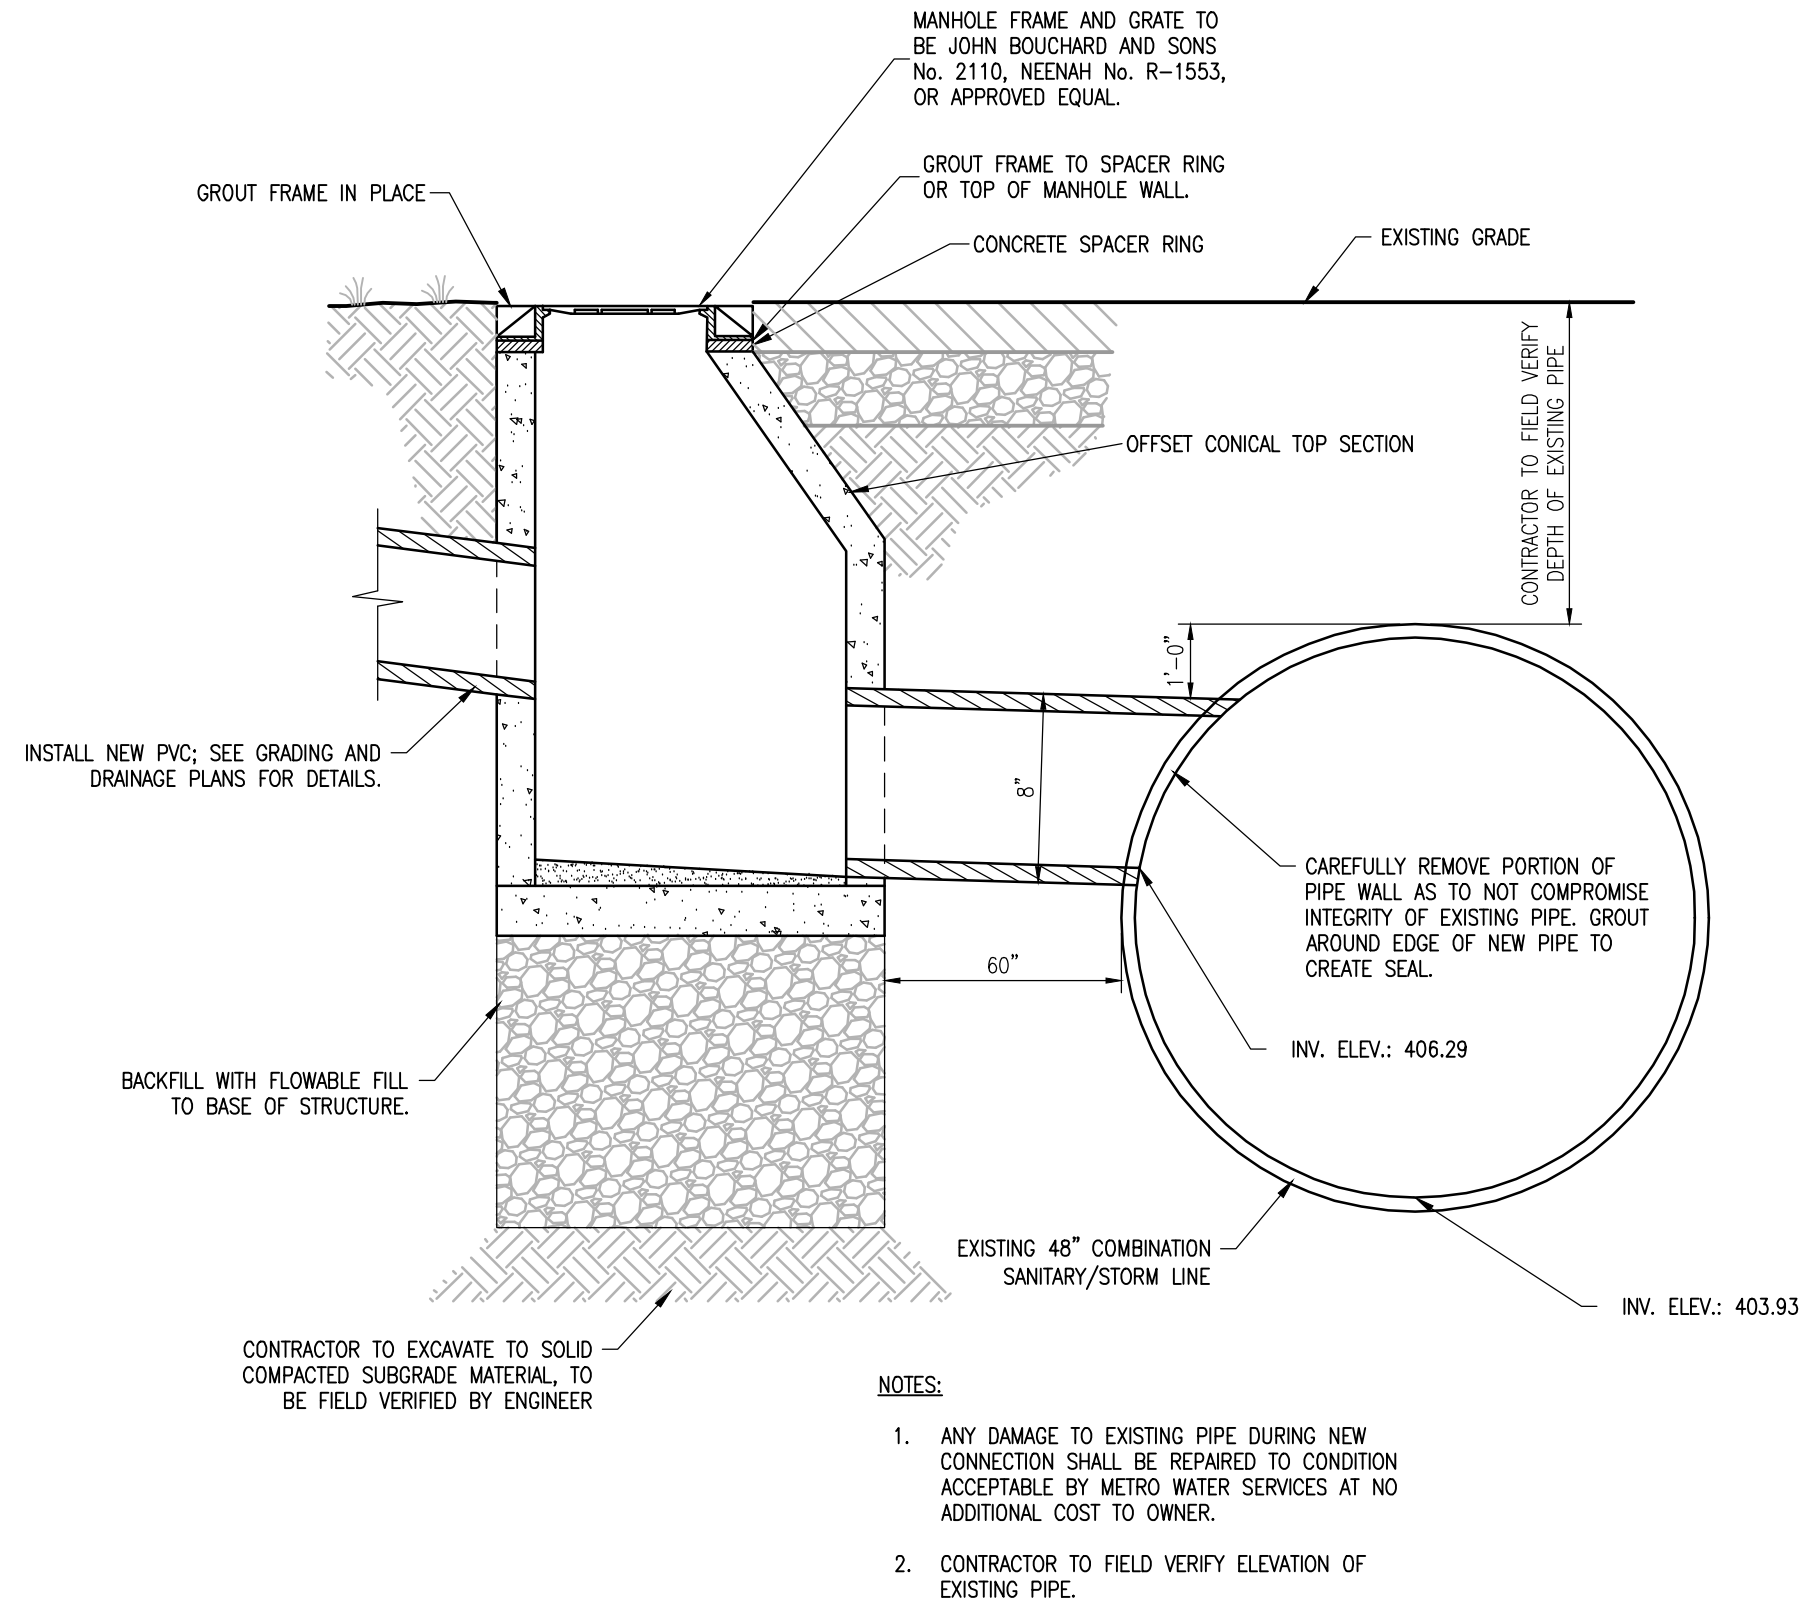

- NOTES:
1. ANY DAMAGE TO EXISTING PIPE DURING NEW CONNECTION SHALL BE REPAIRED TO CONDITION ACCEPTABLE BY METRO WATER SERVICES AT NO ADDITIONAL COST TO OWNER.
 2. CONTRACTOR TO FIELD VERIFY ELEVATION OF EXISTING PIPE.

9


72" BRICK STORM CONNECTION

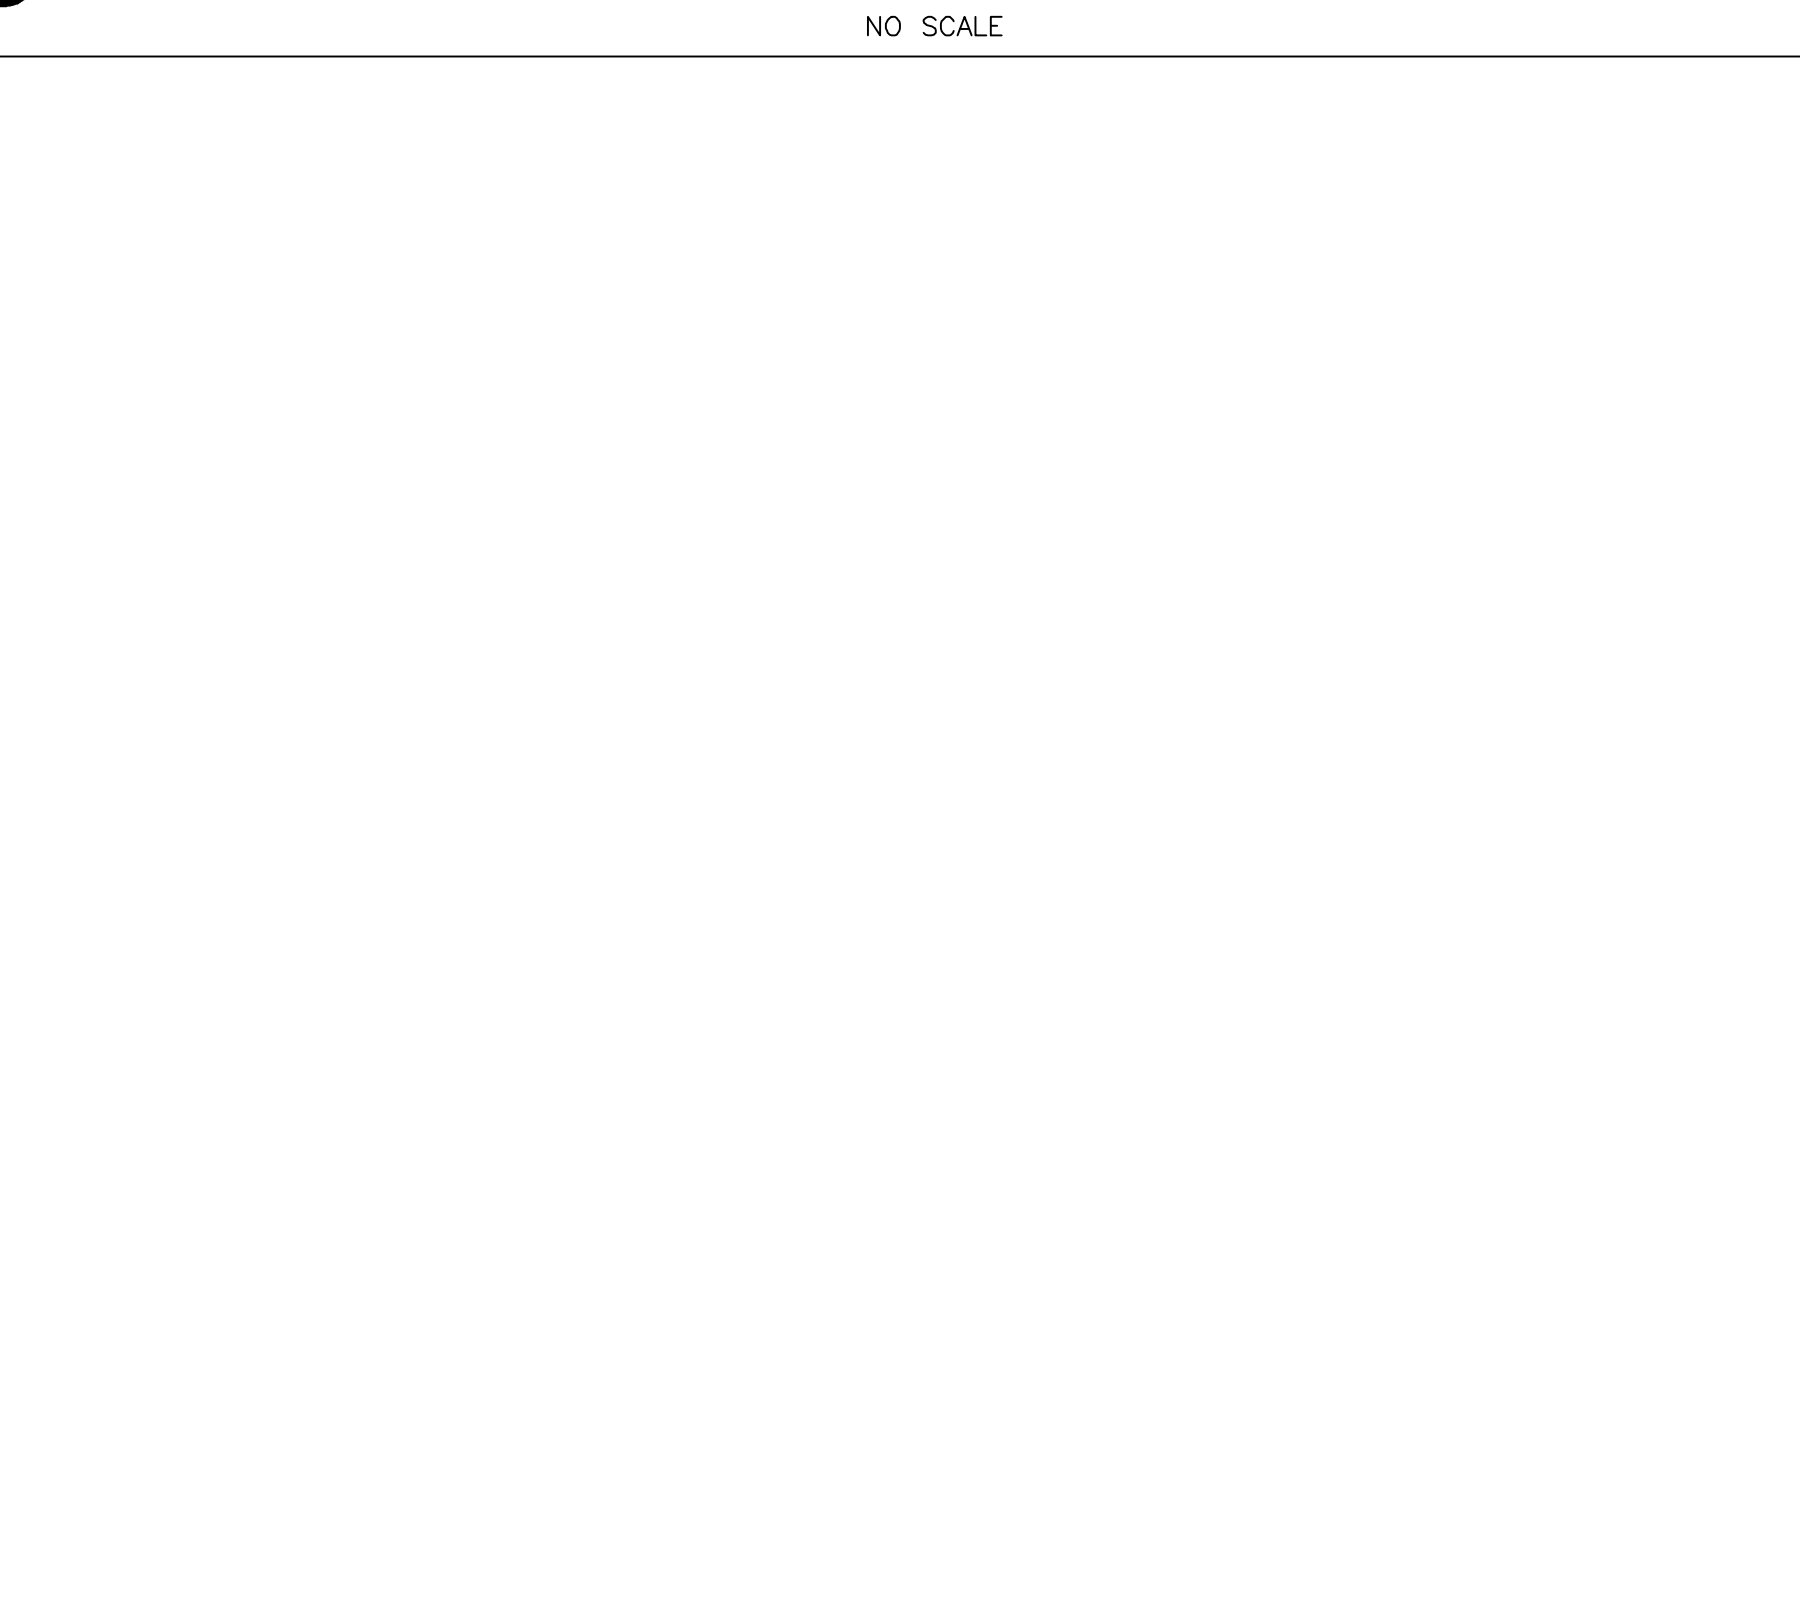

- NOTES:
1. ANY DAMAGE TO EXISTING PIPE DURING NEW CONNECTION SHALL BE REPAIRED TO CONDITION ACCEPTABLE BY METRO WATER SERVICES AT NO ADDITIONAL COST TO OWNER.
 2. CONTRACTOR TO FIELD VERIFY ELEVATION OF EXISTING PIPE.

6

2" WATER METER

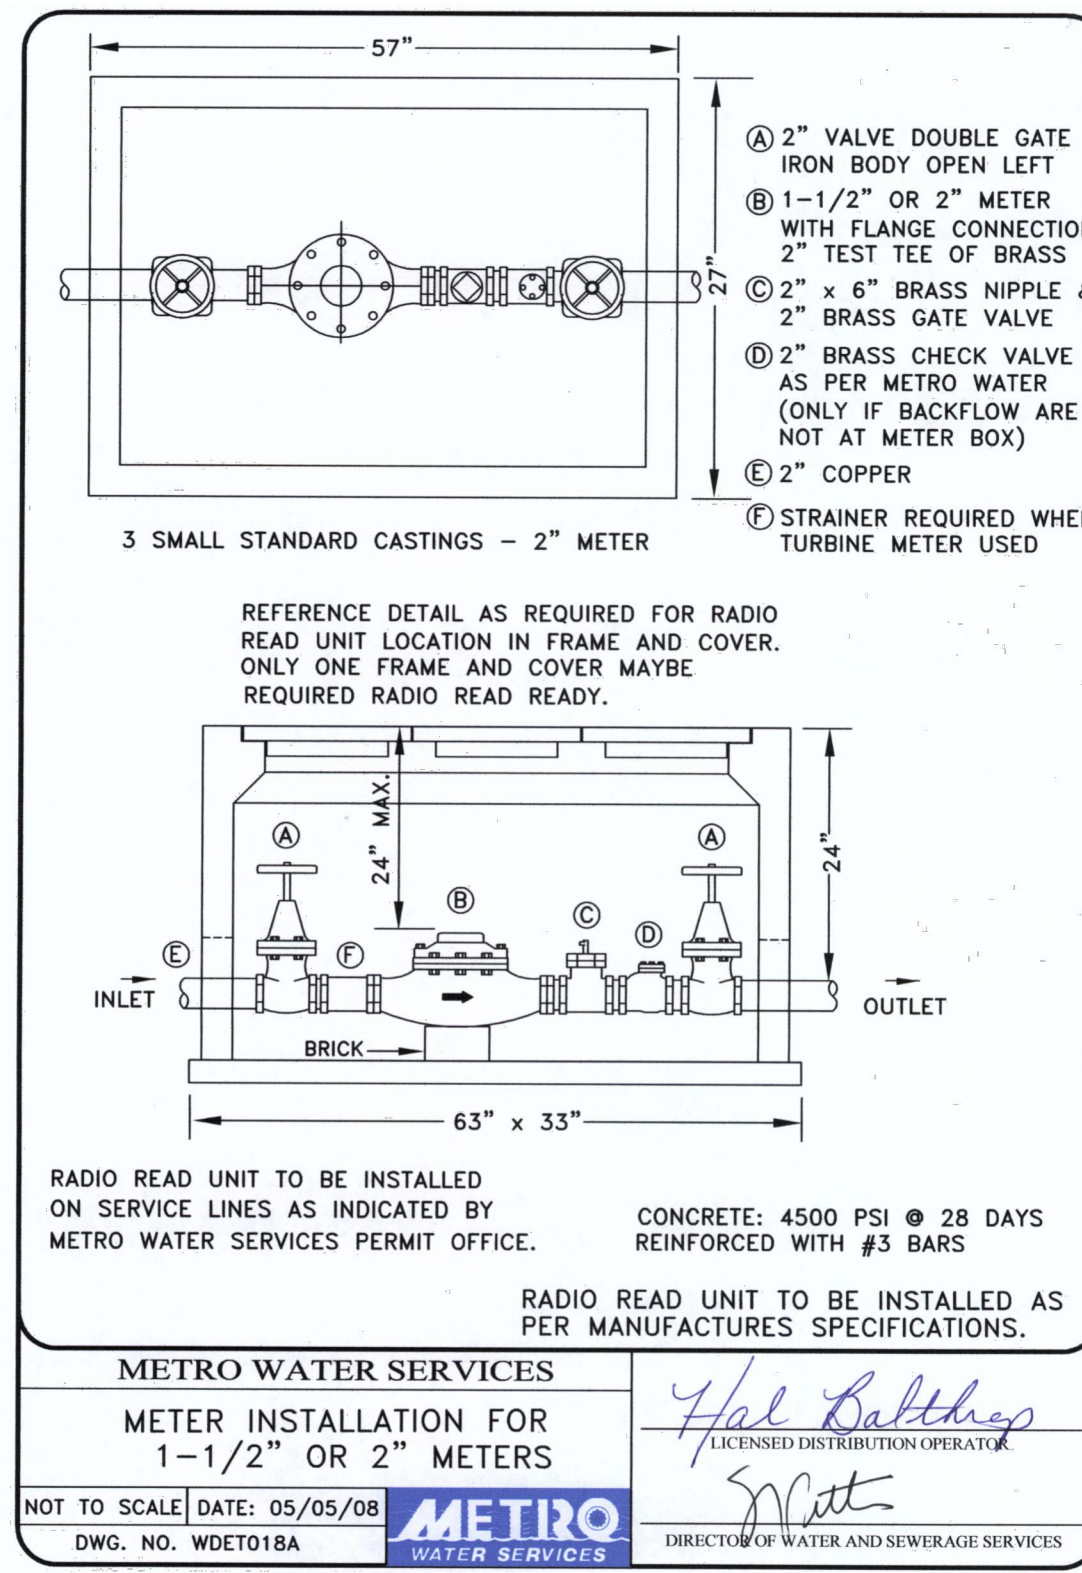

METRO WATER SERVICES
METER INSTALLATION FOR
1-1/2" OR 2" METERS

NOT TO SCALE DATE: 05/05/08
DWG. NO. WDET018A

METRO WATER SERVICES
DIRECTOR OF WATER AND SEWERAGE SERVICES

7

4" WATER METER




METRO WATER SERVICES
METER BOX FOR 4" METER
FOR 4" SERVICE

NOT TO SCALE DATE: 05/05/08
DWG. NO. WDET018C

METRO WATER SERVICES
DIRECTOR OF WATER AND SEWERAGE SERVICES

5

2" METER FOR 3" SERVICE

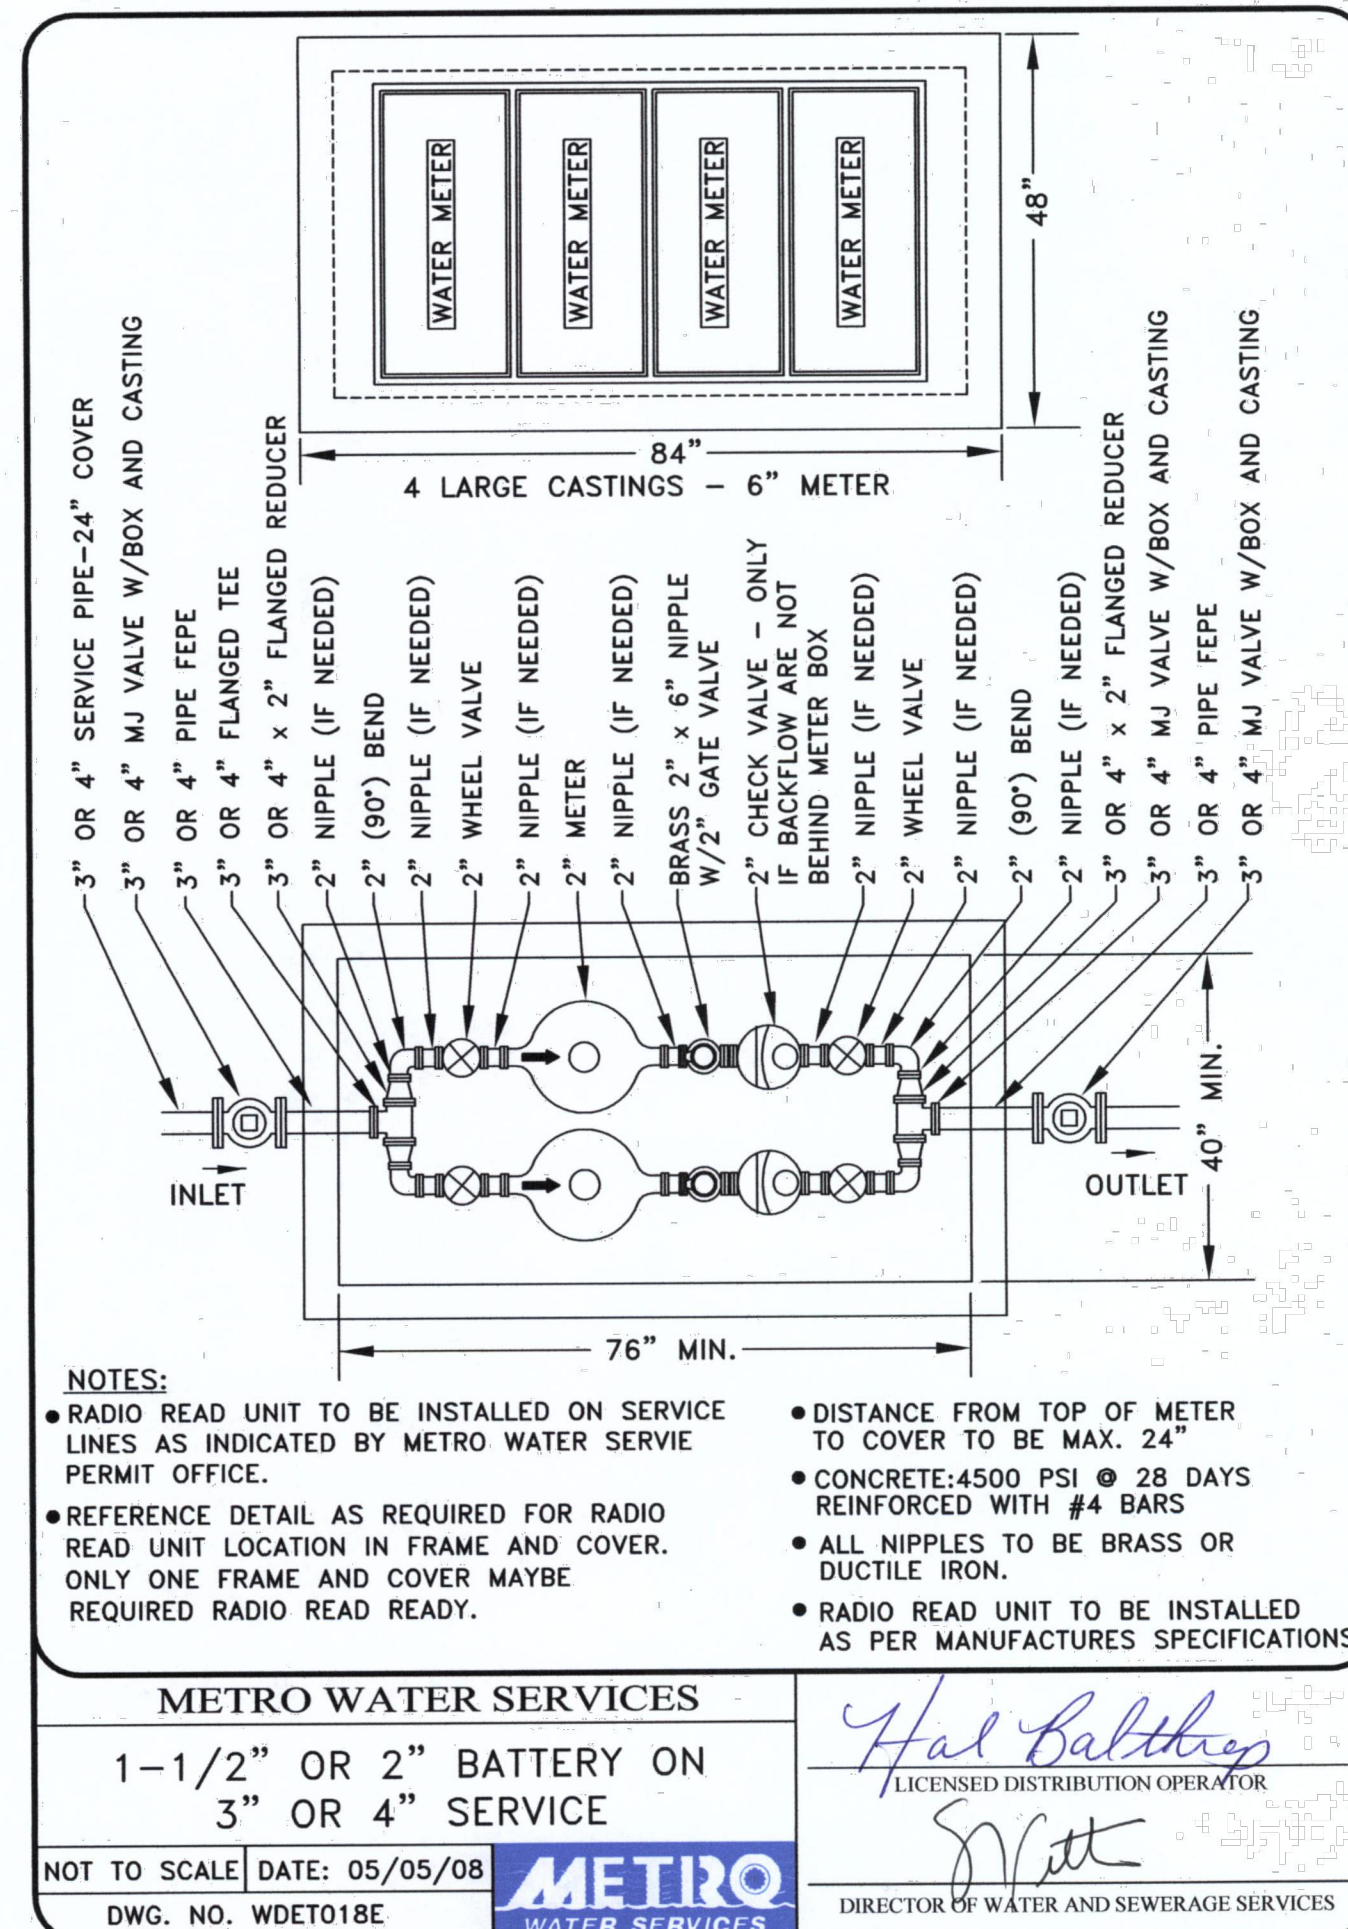


METRO WATER SERVICES
1-1/2" OR 2" BATTERY ON
3" OR 4" SERVICE

NOT TO SCALE DATE: 05/05/08
DWG. NO. WDET018E

METRO WATER SERVICES
DIRECTOR OF WATER AND SEWERAGE SERVICES

4


THRUST BLOCKING

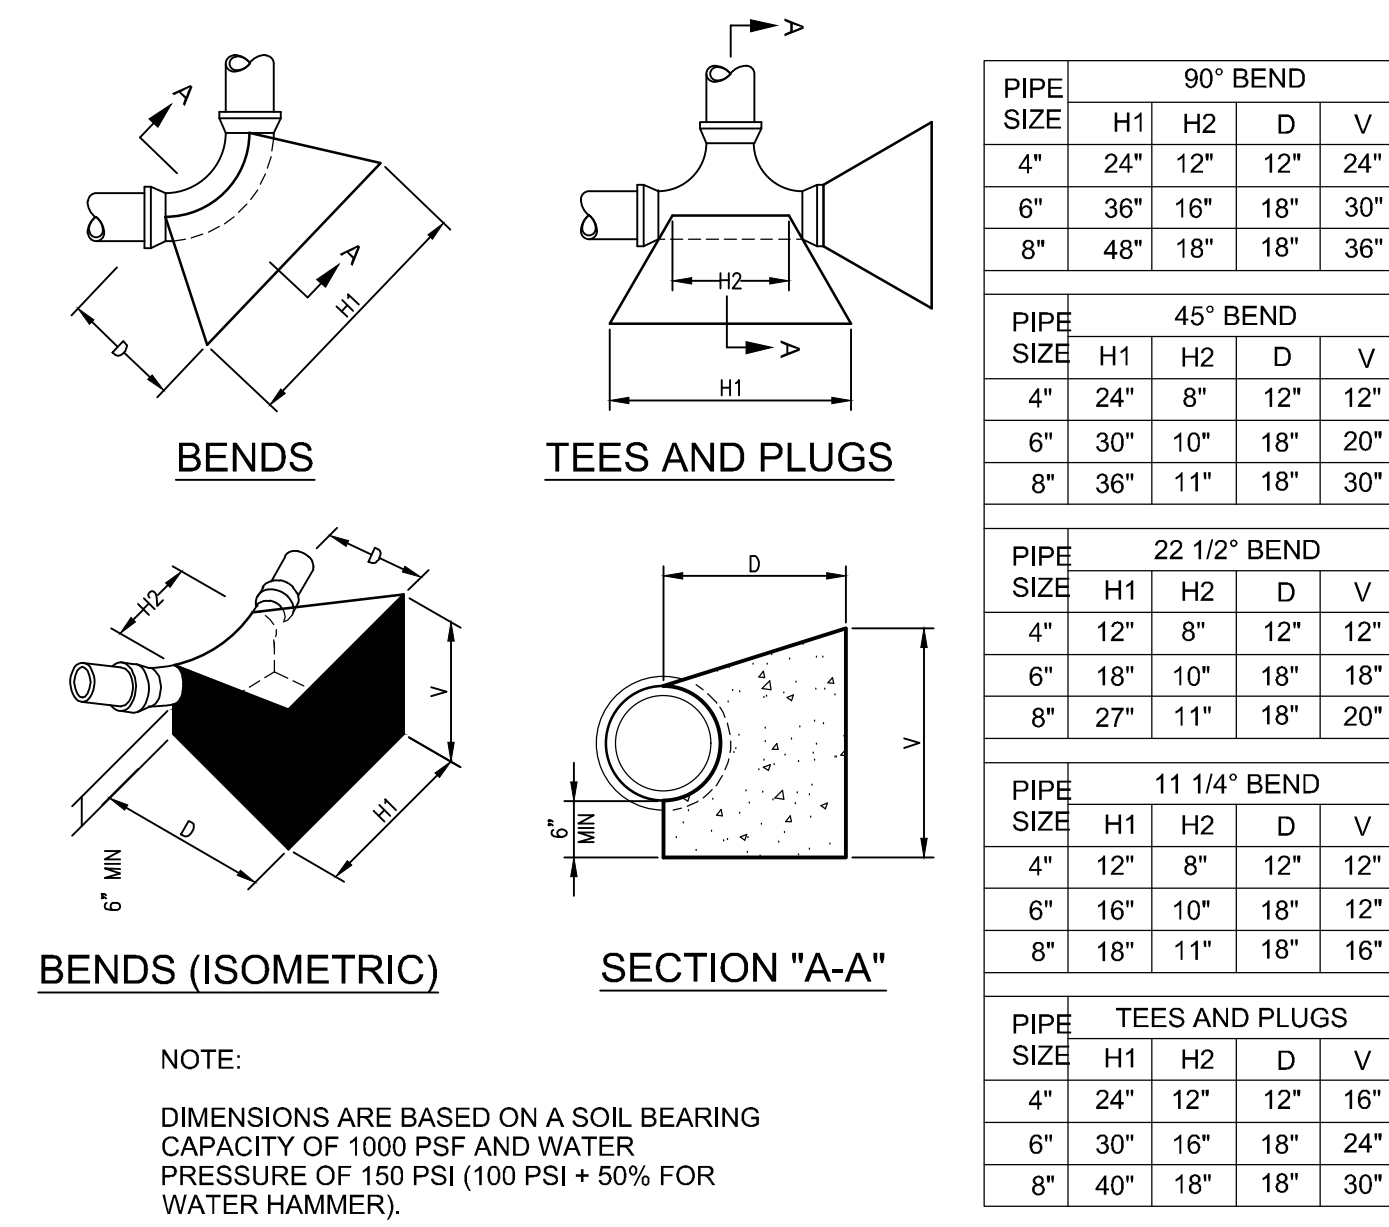

NOTES:
DIMENSIONS ARE BASED ON A SOIL BEARING CAPACITY OF 1000 PSF AND WATER PRESSURE OF 150 PSI (100 PSI + 50% FOR WATER HAMMER).

2

TRENCH REPAIR

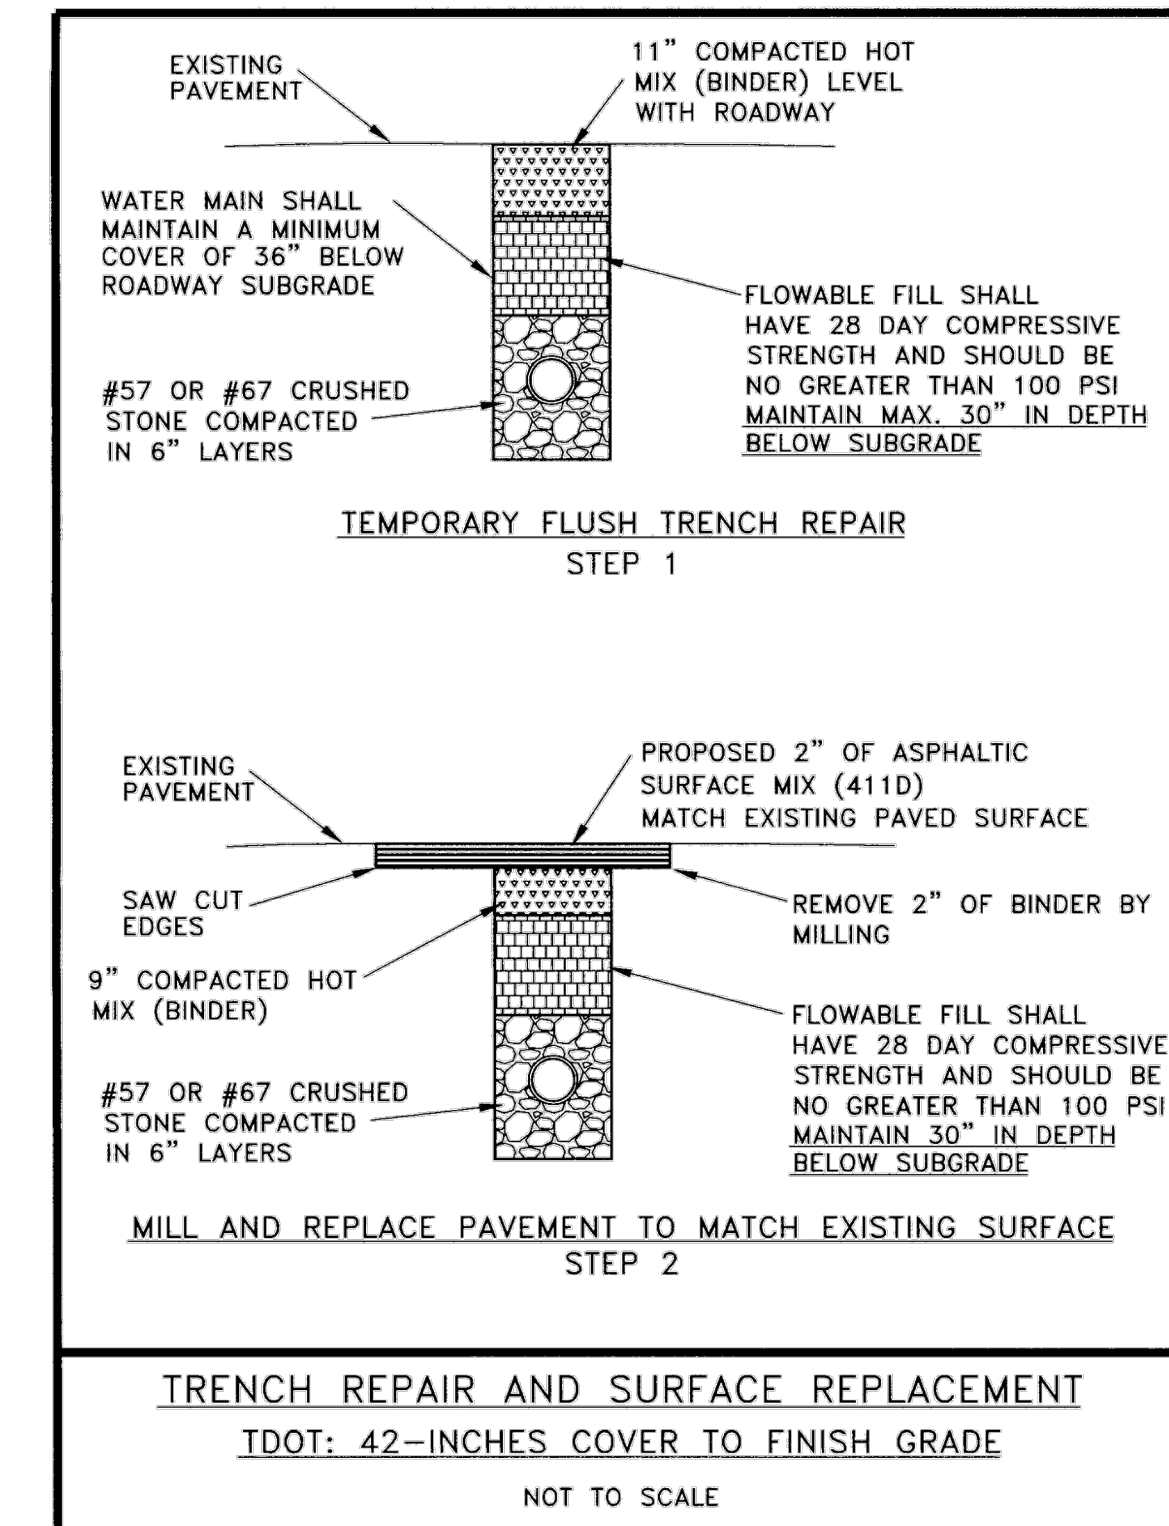


TRENCH REPAIR AND SURFACE REPLACEMENT
DOT: 42-INCHES COVER TO FINISH GRADE

NOT TO SCALE

1

PRECAST CONCRETE SEWER MANHOLE

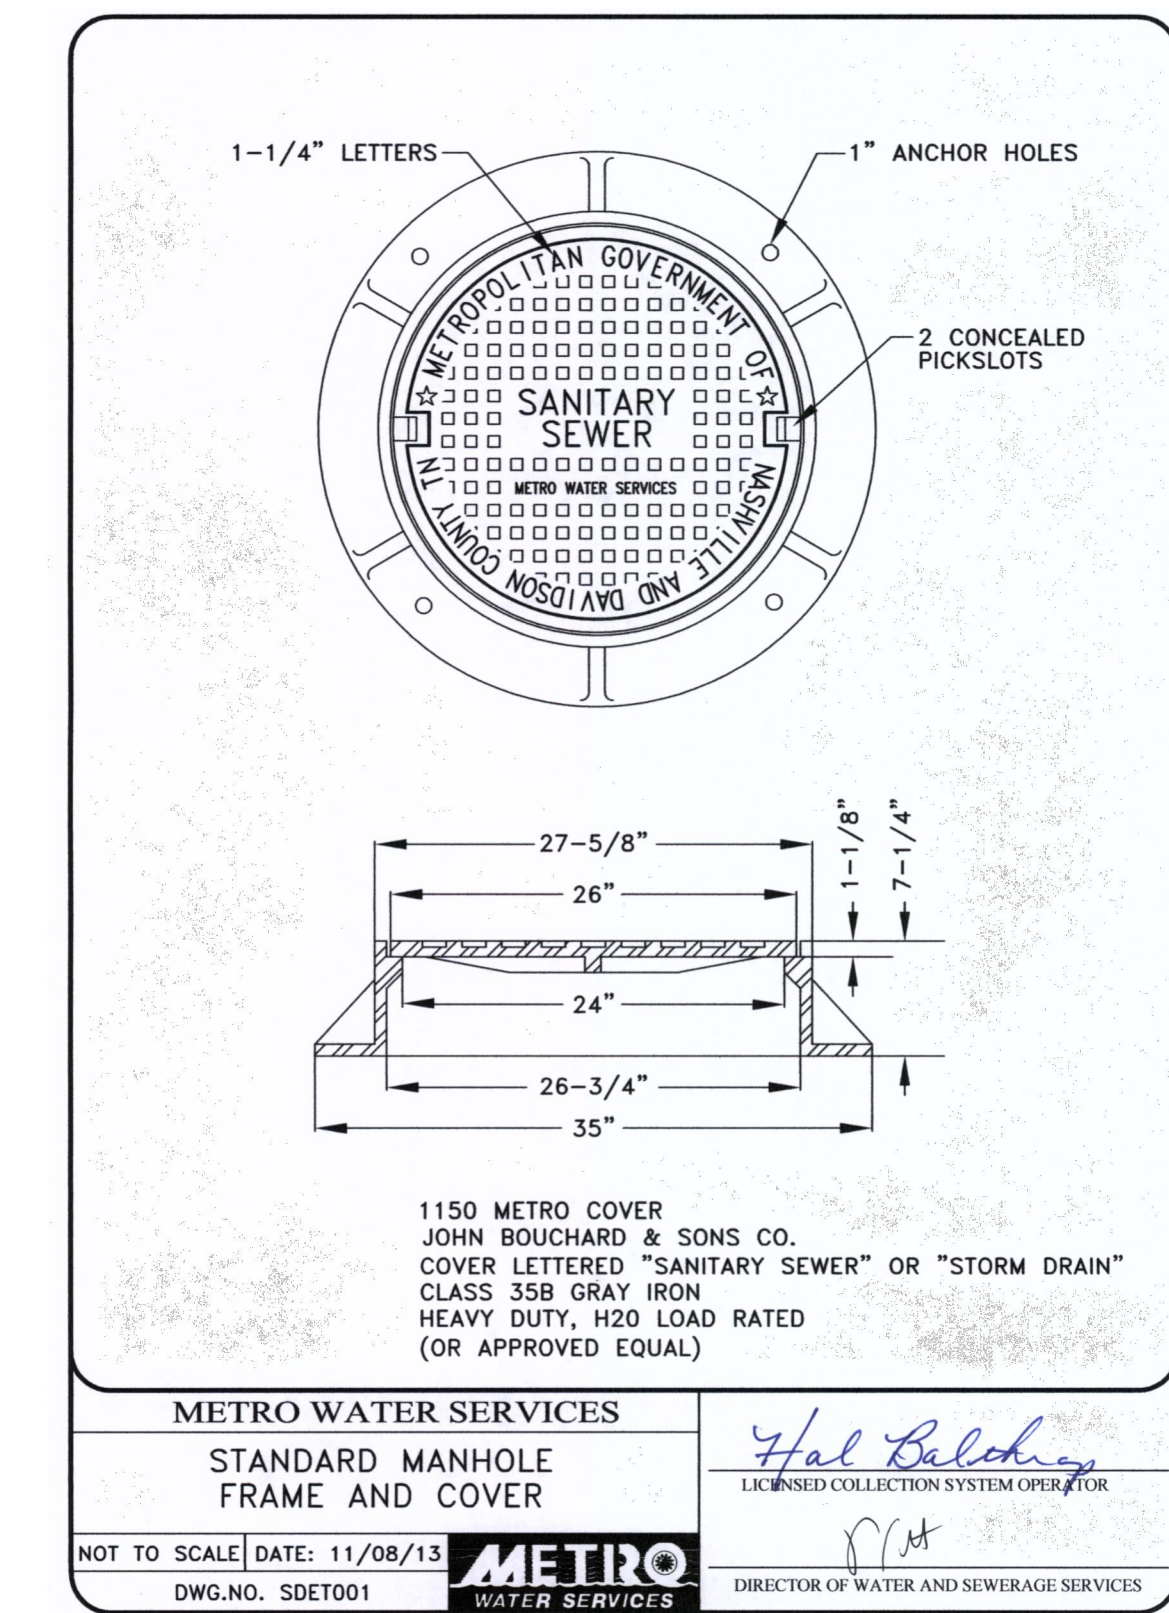


METRO WATER SERVICES
STANDARD MANHOLE
FRAME AND COVER

NOT TO SCALE DATE: 11/08/13
DWG. NO. SDET001

METRO WATER SERVICES
DIRECTOR OF WATER AND SEWERAGE SERVICES

3

FIRE HYDRANT ASSEMBLY



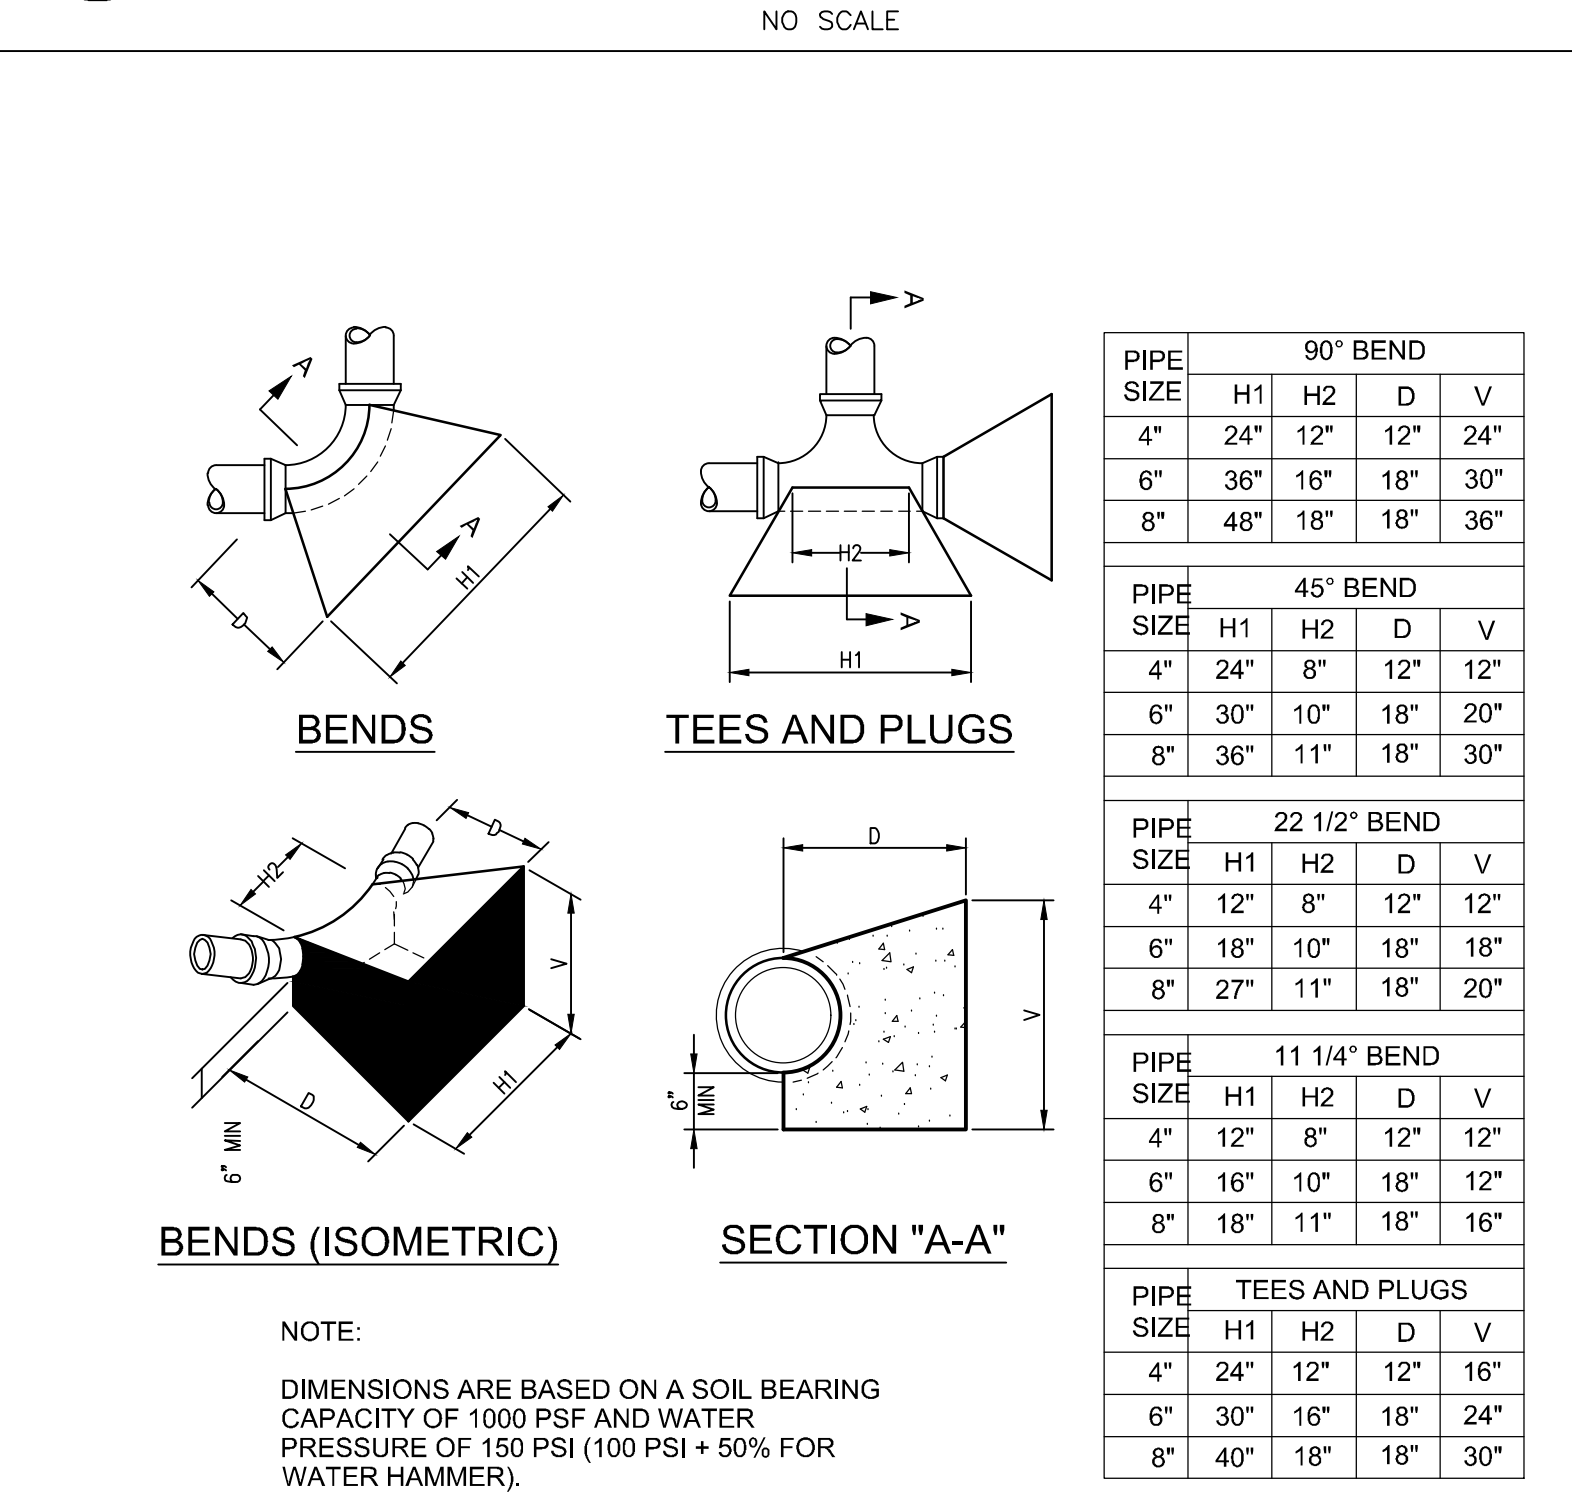


NOTES:
SEE STANDARD SPECIFICATIONS FOR WATER AND SEWER CONSTRUCTION FOR ADDITIONAL DETAILS AND CLARIFICATION.



DATE	REVISIONS
2017.09.28	20150950

TYPICAL PAVEMENT MARKINGS AT PASSIVE RAILROAD-HIGHWAY GRADE CROSSINGS

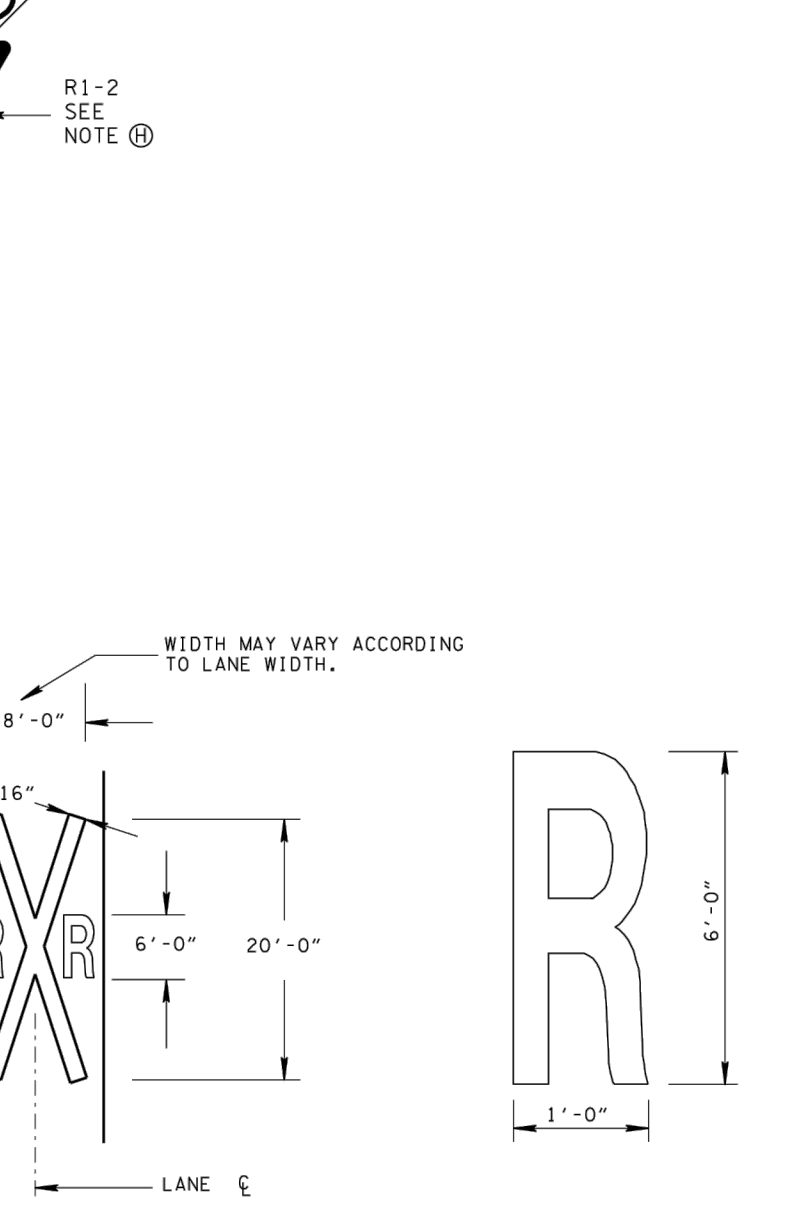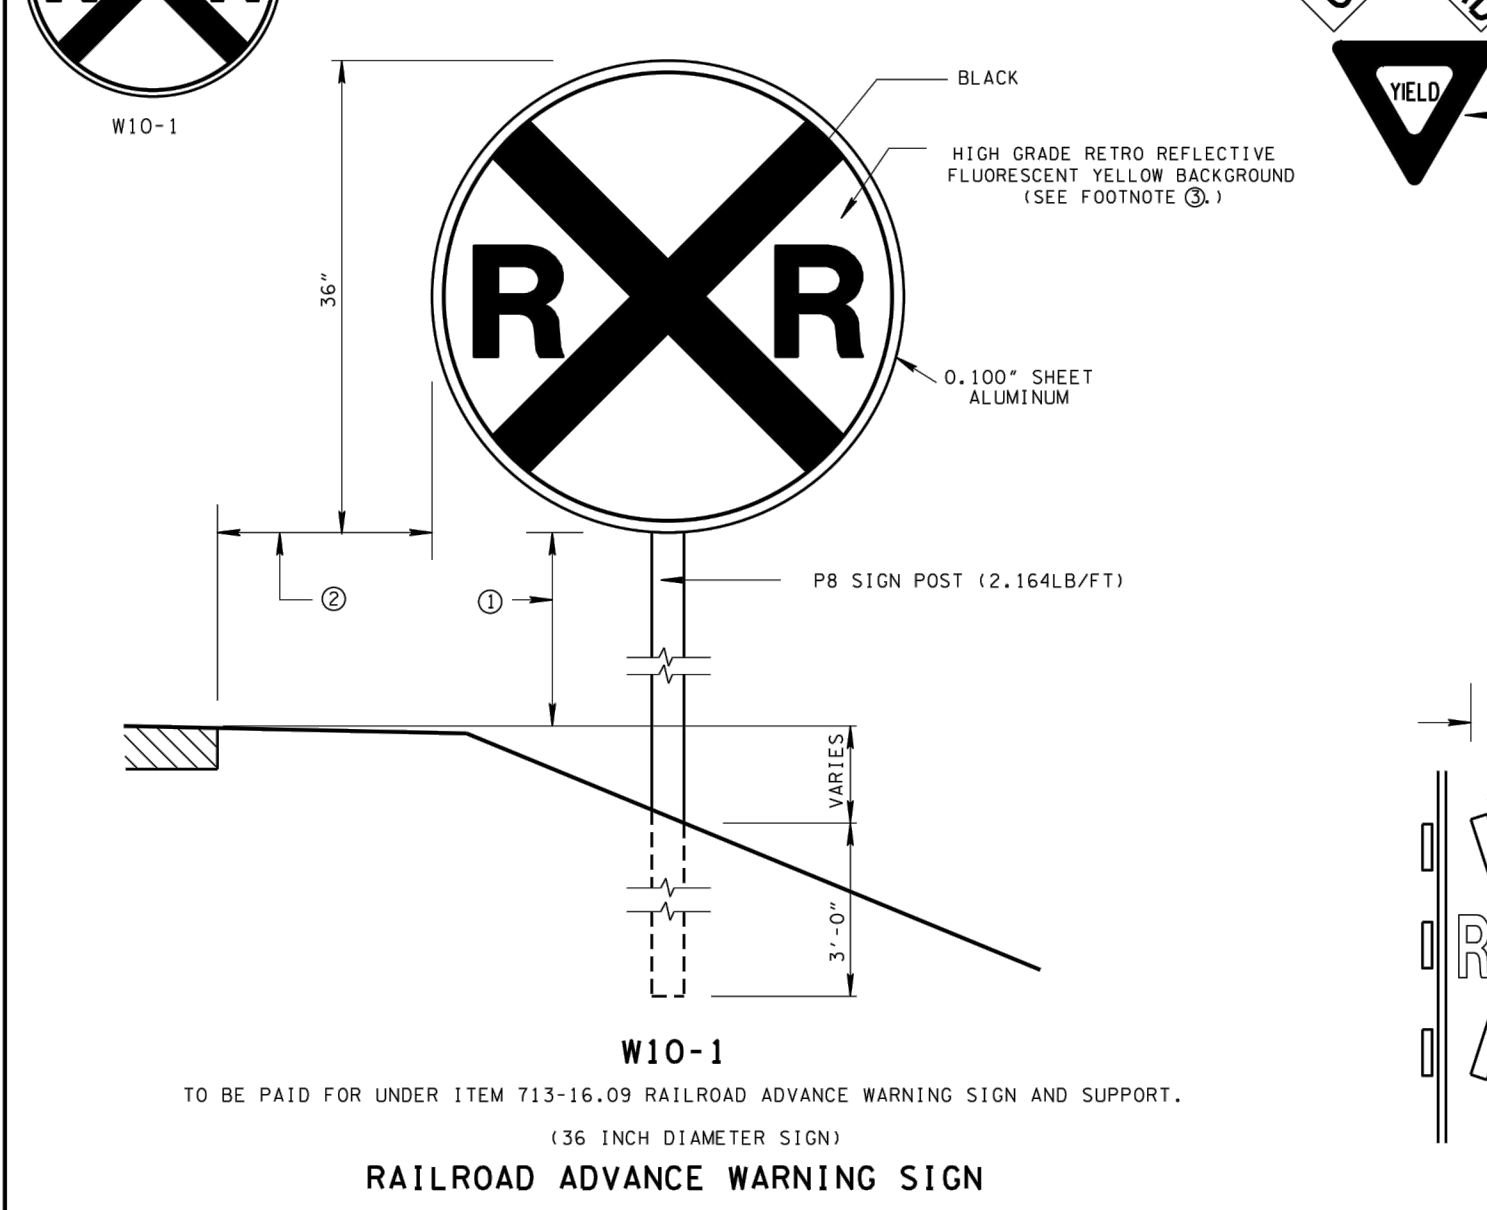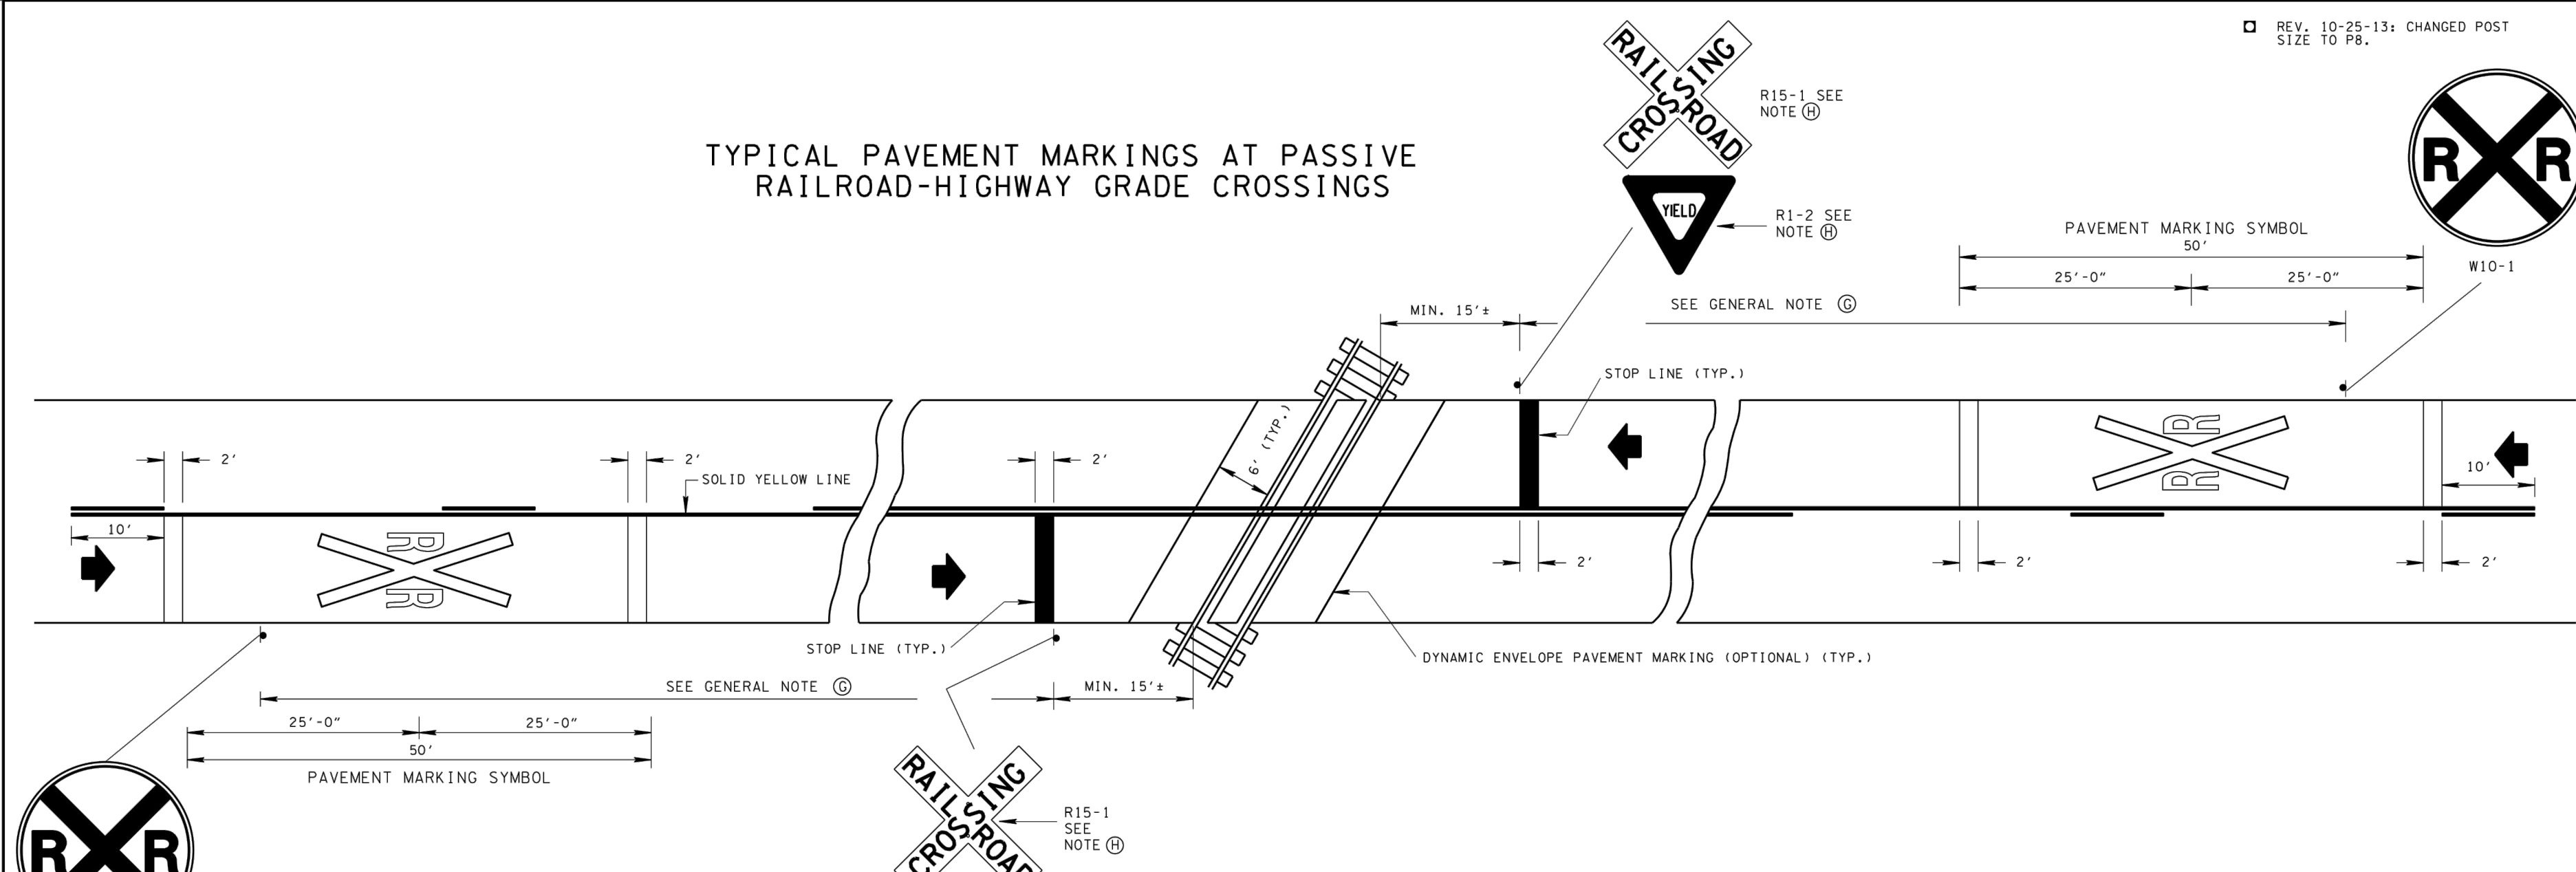

GENERAL NOTES

- A PORTION OF PAVEMENT MARKING SYMBOL SHOULD BE DIRECTLY OPPOSITE THE ADVANCE WARNING SIGN (W10-1).
- A THREE LANE ROADWAY SHOULD BE MARKED WITH A CENTERLINE FOR TWO LANE APPROACH OPERATION ON THE APPROACH TO A CROSSING.
- ON MULTI-LANE ROADS, THE TRANSVERSE BANDS SHOULD EXTEND ACROSS ALL APPROACH LANES, AND INDIVIDUAL "RR" SYMBOLS SHOULD BE USED IN EACH APPROACH LANE.
- PAVEMENT MARKING MATERIAL CAN BE EITHER PAINT OR PLASTIC AS SHOWN ON THE PLANS OR DIRECTED BY THE ENGINEER.
- REFER TO STANDARD ALPHABET FOR HIGHWAY SIGNS AND MARKINGS FOR "RR" SYMBOLS AT EACH RAILROAD CROSSING.
- THE COST OF ALL TRANSVERSE BANDS SHALL BE IN THE PRICE BID FOR THE "RR" SYMBOLS AT EACH RAILROAD CROSSING.
- PLACEMENT OF THE RAILROAD ADVANCE WARNING SIGN SHALL GENERALLY BE IN ACCORDANCE WITH SECTION 202-3 TABLE 202-4 CONDITION B OF THE MANUAL ON UNIFORM TRAFFIC CONTROL DEVICES.
- RAILROAD CROSS-BACK SIGN AND SUPPORT SHALL BE INSTALLED IN ACCORDANCE WITH 15-515; REFER TO 15-516A AT PASSIVE RAILROAD GRADE CROSSINGS FOR STOP SIGN OR YIELD SIGN INSTALLATION.

FOOTNOTES

- SIGNS ERECTED AT THE SIDE OF THE ROAD IN RURAL DISTRICTS SHALL BE MOUNTED AT A HEIGHT OF AT LEAST 9 FEET, MEASURED FROM THE BOTTOM OF THE SIGN TO THE NEAR EDGE OF THE PAVEMENT. IN BUSINESS, COMMERCIAL AND RESIDENTIAL DISTRICTS WHERE PARKING AND/OR PEDESTRIAN MOVEMENT IS LIKELY TO OCCUR OR WHERE THERE ARE OTHER OBSTRUCTIONS TO VIEW, THE CLEARANCE TO THE BOTTOM OF THE SIGN SHALL BE AT LEAST 7 FEET.
- NORMALLY, SIGNS SHOULD NOT BE CLOSER THAN 6 FEET FROM THE EDGE OF THE SHOULDER, OR IF NONE, 12 FEET FROM THE EDGE OF THE TRAVELED WAY. IN URBAN AREAS A LESSER CLEARANCE MAY BE USED WHERE NECESSARY. ALTHOUGH 2 FEET IS RECOMMENDED AS A WORKING URBAN MINIMUM, A CLEARANCE OF 1 FOOT FROM THE CURB FACE IS PERMISSIBLE WHERE SIDEWALK WIDTH IS LIMITED OR WHERE EXISTING POLES ARE CLOSE TO THE CURB.
- SEE TDOT SPECIAL PROVISION 713A REGARDING SPECIFICATIONS FOR HIGH GRADE REFLECTIVE SHEETING.

REV. 10-25-13; CHANGED POST SIZE TO P8.


MINOR REVISION - FIRM APPROVAL NOT REQUIRED.

STATE OF TENNESSEE DEPARTMENT OF TRANSPORTATION


TYPICAL SIGNING AND MARKING AT PASSIVE RAILROAD HIGHWAY GRADE CROSSINGS

10-23-06 T-RR-6


4 OFF-SITE RAILROAD CROSSING STRIPING AND SIGNAGE IMPROVEMENTS

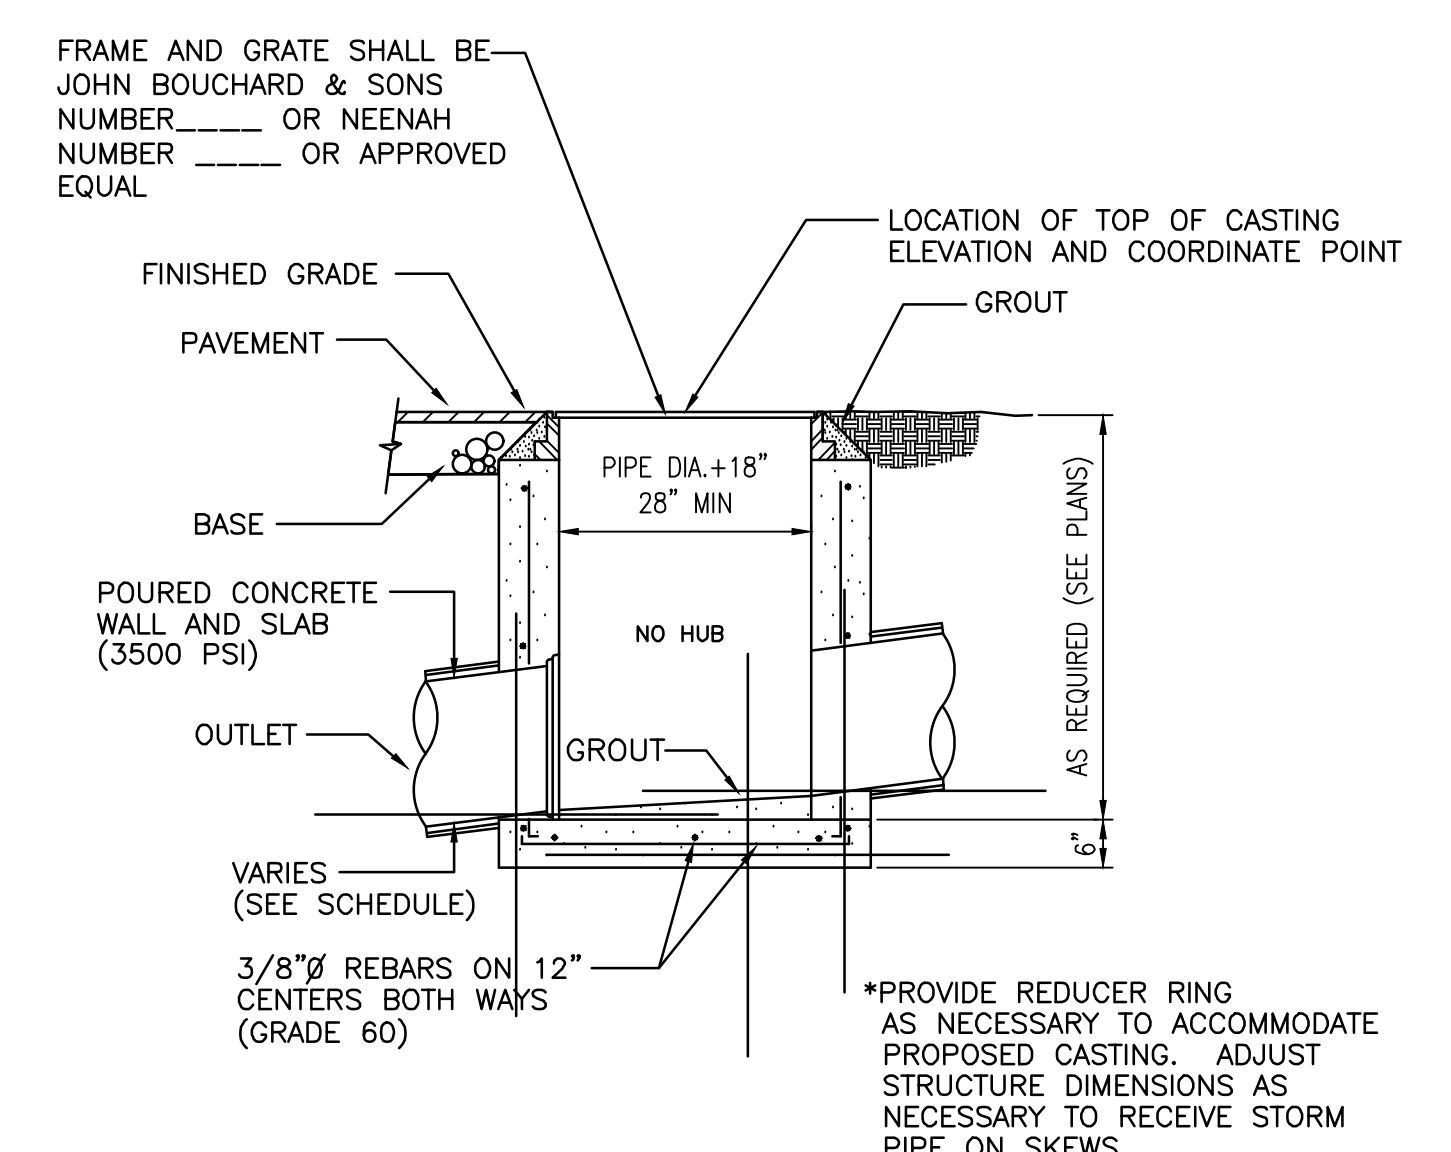

2 SINGLE CATCH BASIN

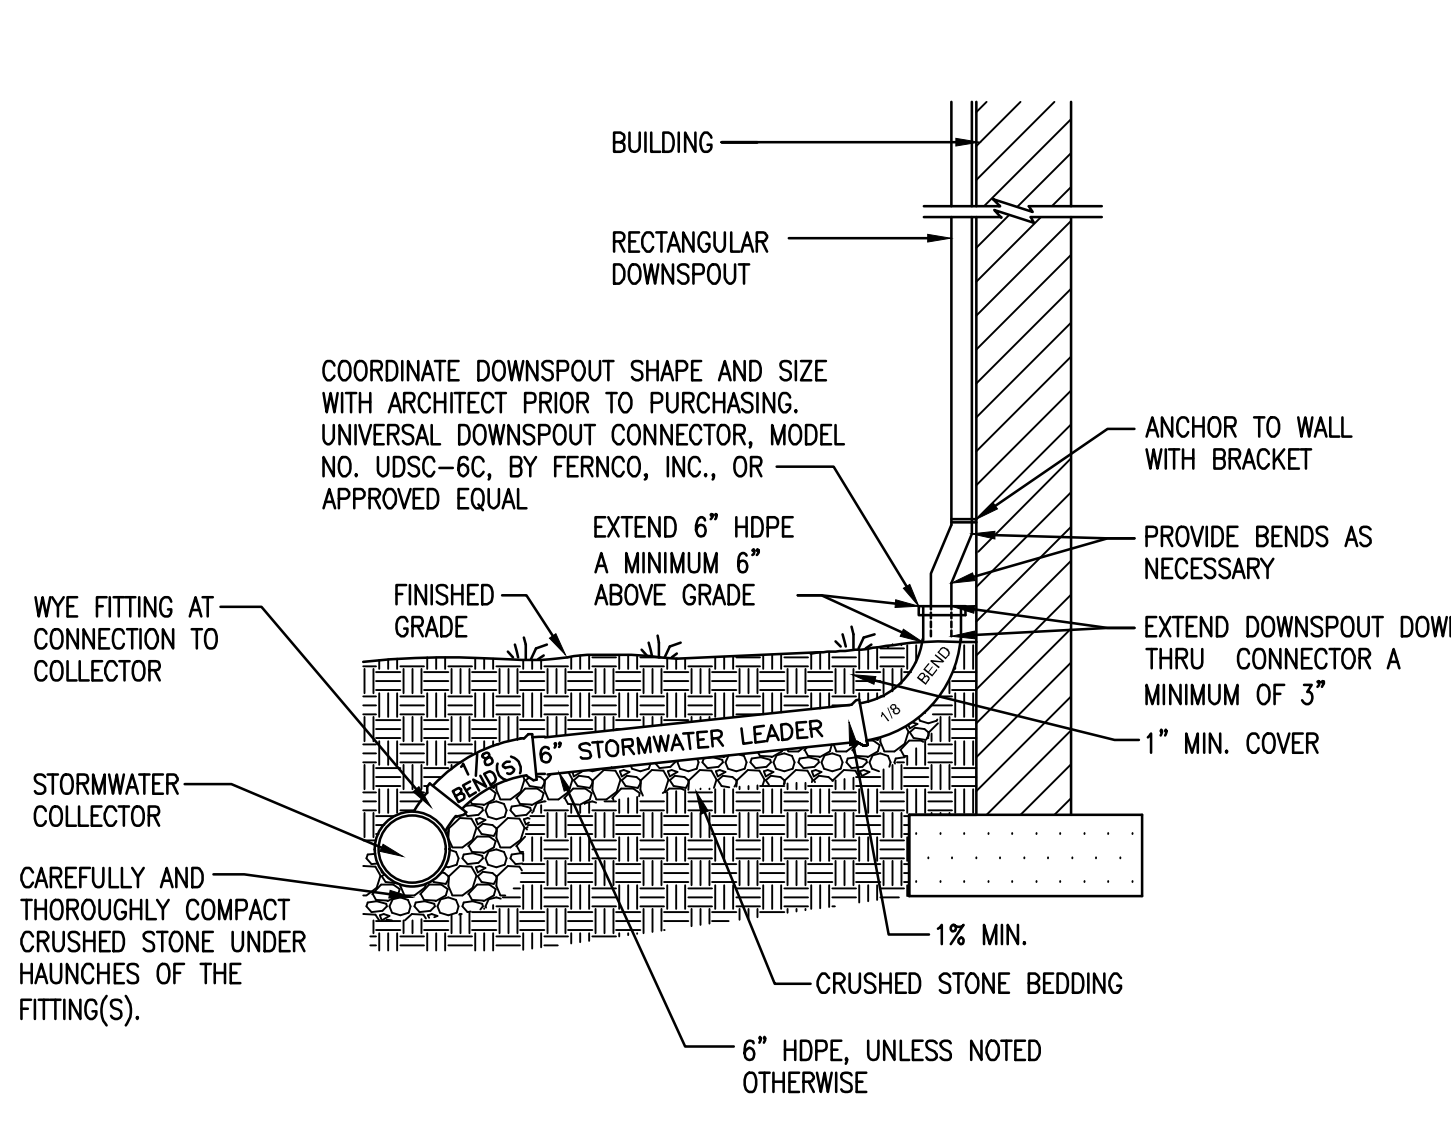

3 BUILDING DOWNSPOUT COLLECTOR

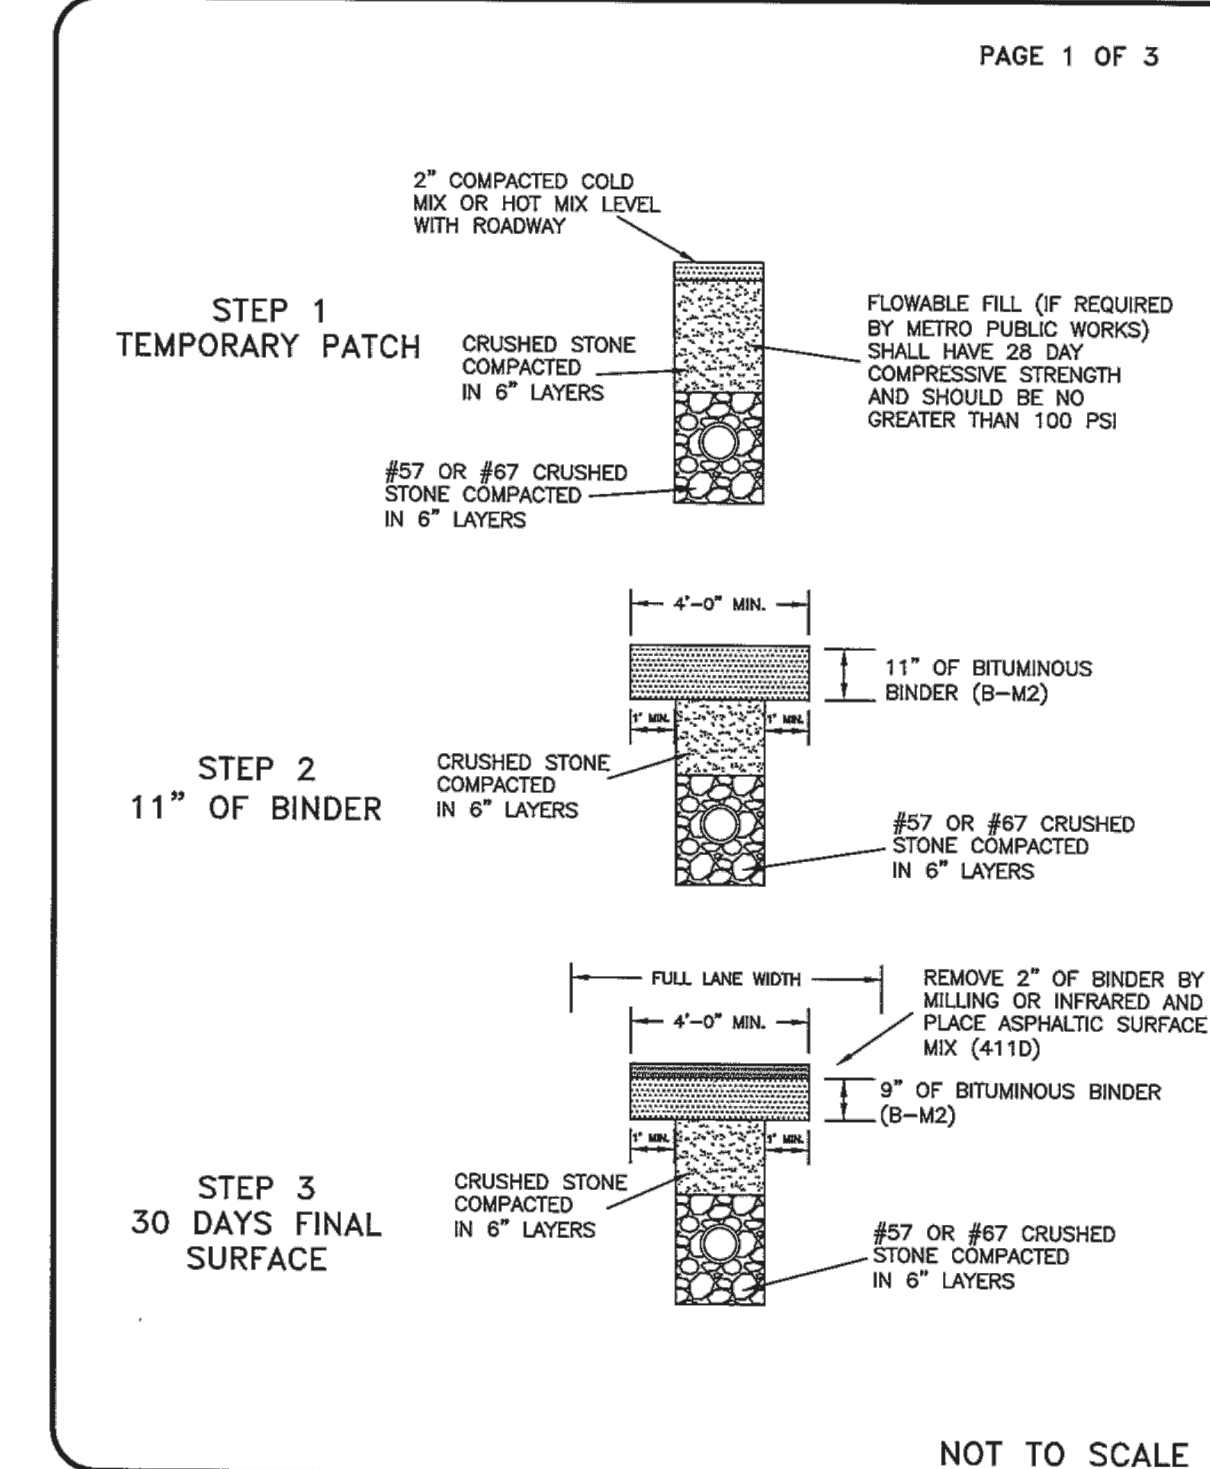

METROPOLITAN GOVERNMENT OF NASHVILLE AND DAVIDSON COUNTY DEPARTMENT OF PUBLIC WORKS

FLUSH TRENCH REPAIR WITH STONE

DIR. OF ENG.: *[Signature]* DATE: 7/15/15

DWG. NO. ST-270a

REVISED:	04/01/08
REVISED:	11/17/08
REVISED:	03/24/10
REVISED:	07/15/15

GENERAL NOTES

- PRIOR TO PLACEMENT OF CRUSHED STONE OR FLOWABLE FILL THE DEPARTMENT OF PUBLIC WORKS PERMITS OFFICE WILL BE NOTIFIED AND AN INSPECTION OF THE TRENCH WILL BE MADE BY A REPRESENTATIVE OF THE DEPARTMENT OF PUBLIC WORKS PERMITS OFFICE. AT THE COMPLETION OF THE INSTALLATION OF THE CRUSHED STONE OR FLOWABLE FILL THE DEPARTMENT OF PUBLIC WORKS PERMITS OFFICE WILL BE NOTIFIED AND AN INSPECTION OF THE BACKFILL WILL BE MADE BY A REPRESENTATIVE OF THE DEPARTMENT OF PUBLIC WORKS. AFTER ACCEPTANCE OF THE BACKFILL BY THE REPRESENTATIVE OF THE DEPARTMENT OF PUBLIC WORKS PERMITS OFFICE, THE ASPHALT PAVEMENT CAN BE APPLIED.
- INSPECTION PERSONNEL OF THE DEPARTMENT OF PUBLIC WORKS SHALL BE NOTIFIED BY CONTRACTOR/PERMITEE AT LEAST TWO (2) DAYS PRIOR TO REQUEST FOR INSPECTION.
- THE WORK PERFORMED SHALL BE FREE FROM WORKMANSHIP DEFECTS FOR A PERIOD OF ONE (1) YEAR AFTER THE DATE OF ACCEPTANCE BY THE DEPARTMENT OF PUBLIC WORKS PERMIT OFFICE.
- EXISTING PAVEMENTS, BASES, CURBS & GUTTERS AND SIDEWALKS SHALL BE CUT AND BROUGHT TO A NEAT LINE BY USE OF AN AIR HAMMER, SAW OR OTHER SUITABLE EQUIPMENT. EXPANSION JOINTS REMOVED SHALL BE REPLACED.
- THE MINIMUM WIDTH TO BE TRIMMED ON EACH SIDE OF THE TRENCH LINE, AS SEEN IN THE SECTION MAY BE WAIVED OR AMENDED UPON APPROVAL OF THE METRO DEPARTMENT OF PUBLIC WORKS, HOWEVER, A MINIMUM WIDTH OF REPLACEMENT SHALL BE 4'-0" TO ALLOW FOR A ROLLER.
- IF PERMANENT PAVEMENT REPAIRS CANNOT BE MADE WITHIN THREE (3) DAYS, THEN TEMPORARY REPLACEMENT SHALL BE MADE WITH 2" COLD MIX. PERMANENT PAVEMENT REPAIR TO BE COMPLETED WITHIN THE REQUIRED TIME PERIOD AS PER METRO CODE 13.20.
- ALL EXCAVATIONS MADE WITHIN PUBLIC RIGHT-OF-WAY REQUIRE EXCAVATIONS AND STREET CLOSURE PERMITS FROM THE DEPARTMENT OF PUBLIC WORKS PRIOR TO COMMENCING WORK AS PER METRO CODE 13.20.
- FLOWABLE FILL WILL BE REQUIRED ON ALL ARTERIALS, COLLECTORS AND DOWNTOWN STREETS. FLOWABLE FILL SHALL MEET THE REQUIREMENTS IN TENNESSEE DEPARTMENT OF TRANSPORTATION STANDARD SPECIFICATIONS SECTION 204, EXCEPT AS MODIFIED BY PUBLIC WORKS TECHNICAL SPECIFICATIONS 02225, LATEST REVISION.
- IN THE EVENT OF ANY CONFLICT, DISCREPANCY, OR INCONSISTENCY AMONG THE PLANS AND THESE STANDARD DETAILS, THE REQUIREMENTS OF THE STANDARD DETAILS SHALL GOVERN.
- ALL REPAIRS SHALL INCLUDE FULL LANE WIDTH RESURFACING EXCEPT WHEN UTILIZING INFRARED TECHNOLOGY. SEE INFRARED SPECIFICATIONS ATTACHED. THERE WILL BE A MAXIMUM OF 40 FT LONGITUDINAL REPAIR WHEN USING INFRARED TECHNOLOGY ON AN EXCAVATED PATCH.
- ALL REPAIRS SHALL UTILIZE A 1-FOOT CUTBACK ON ALL SIDES EXCEPT THE EDGE OF PAVEMENT.

METROPOLITAN GOVERNMENT OF NASHVILLE AND DAVIDSON COUNTY DEPARTMENT OF PUBLIC WORKS

FLUSH TRENCH REPAIR WITH STONE NOTES

DIR. OF ENG.: *[Signature]* DATE: 7/15/15

DWG. NO. ST-270a

REVISED:	04/01/08
REVISED:	11/17/08
REVISED:	03/24/10
REVISED:	07/15/15

GENERAL NOTES CONTINUED:

- NEW UTILITY CUTS WILL BE MILLED AND PAVED TO ANY EXISTING UTILITY CUT OR DAMAGED PAVEMENT WITHIN 10- FEET. IF EXISTING CUT OR DAMAGED PAVEMENT IS LESS THAN 10- FEET IN LENGTH, THE EXISTING CUT OR DAMAGED PAVEMENT SHALL ALSO BE MILLED AND PAVED.
- ASPHALT REPAIR ADJACENT TO CURB AND GUTTER ALONG A ROADWAY GREATER THAN 24-INCHES SHALL HAVE FULL LANE WIDTH PAVING.
- WHEN GRADED STONE (I.E. #57, #78 STONE) IS USED THERE IS GENERALLY NO COMPACTION EQUIPMENT REQUIRED. THE MATERIAL DOES, HOWEVER, NEED TO BE PUT IN THE TRENCH IN APPROXIMATELY 12-INCH LIFTS.
- GRADED STONE PLACED IN TRENCH SHOULD BE CAPPED WITH 8 TO 12-INCHES OF PUG MIX (MX IS ESSENTIALLY TYPE A BASE, GRADE D, OR MORE COMMONLY KNOWN AS "CRUSHER RUN"). SEE TDOT STANDARD SPECIFICATION 303.07.
- TYPE "A" BASE, GRADE "D" CAN BE USED FOR THE ENTIRE BACKFILL AND COMPACTED BY MECHANICAL METHODS IN NO MORE THAN 6-INCH LIFTS AS PROVIDED IN SECTION 204.11 OF TDOT STANDARD SPECIFICATIONS.
- THE PUG MIX SHOULD BE COMPACTED IN 6-INCH LIFTS WITH A STEEL SHELL ROLLER OR OTHER MECHANICAL VIBRATORY COMPACTION EQUIPMENT. SEE TDOT STANDARD SPECIFICATIONS 303.08 AND 303.09. MATERIAL SHOULD BE ALLOWED TO CURE UNTIL ALL THE MOISTURE IS GONE FROM STONE (USUALLY 24-48 HOURS).
- THE TRENCH SHOULD THEN HAVE 11-INCHES OF BINDER PLACED LEVEL WITH THE ROADWAY IN A MINIMUM OF TWO (2) LIFTS AND COMPACTED WITH MECHANICAL COMPACTION EQUIPMENT.
- THE BINDER SURFACE SHALL BE MILLED OR HEATED USING INFRARED TECHNOLOGY TWO 2-INCHES IN DEPTH AND REPLACED WITH TWO (2) INCHES OF SURFACE MIX AND COMPACTED WITH MECHANICAL COMPACTION EQUIPMENT.
- INTERSECTION REPAIRS WILL ONLY REQUIRE FULL LANE WIDTH PAVING.
- ANY DISTURBED PAVEMENT MARKINGS MUST BE RESTORED TO CURRENT METRO STANDARDS.
- DIAGONAL REPAIRS WILL BE REQUIRED TO BE SQUARED OFF AND MILLED AND PAVED. NO INFRARED TECHNOLOGY ALLOWED ON THIS TYPE OF REPAIR.
- ALL LONGITUDINAL REPAIRS MORE THAN 40 FT IN LENGTH WILL BE REQUIRED TO BE MILLED AND PAVED.
- FOR ANY DISCREPANCIES OR VARIATIONS FROM SPECIFICATIONS, OBTAIN APPROVAL FROM THE DEPARTMENT OF PUBLIC WORKS.
- ALL FILL SHALL MEET MANUFACTURING SPECIFICATIONS, IF APPLICABLE.

METROPOLITAN GOVERNMENT OF NASHVILLE AND DAVIDSON COUNTY DEPARTMENT OF PUBLIC WORKS

FLUSH TRENCH REPAIR WITH STONE NOTES

DIR. OF ENG.: *[Signature]* DATE: 7/15/15

DWG. NO. ST-270a

REVISED:	04/01/08
REVISED:	11/17/08
REVISED:	03/24/10
REVISED:	07/15/15

1 TRENCH REPAIR



Case No: 2016SP-005-003

SP PLAN AMENDMENT

HAMMER MILL MULTIFAMILY


NASHVILLE, DAVIDSON COUNTY, TENNESSEE

Gateway TBR Hammer Mill, GP

1575 NORTHSIDE DRIVE

BUILDING 100, SUITE 200

ATLANTA, GA 30318

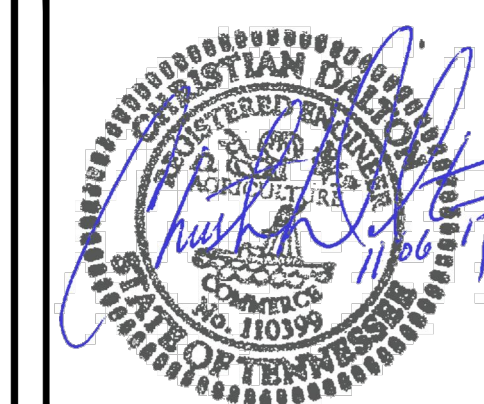


DATE	REVISIONS
2017.09.28	20150950

C8.4

SITE DETAILS


G:\Projects\2015\20150950\dwg\Final SP Amendment\20150950 A-FSP C8.0 DTL.dwg-19 20150950 A-FSP C8.4 DTL Nov 06, 2017 - 2:35pm alegg

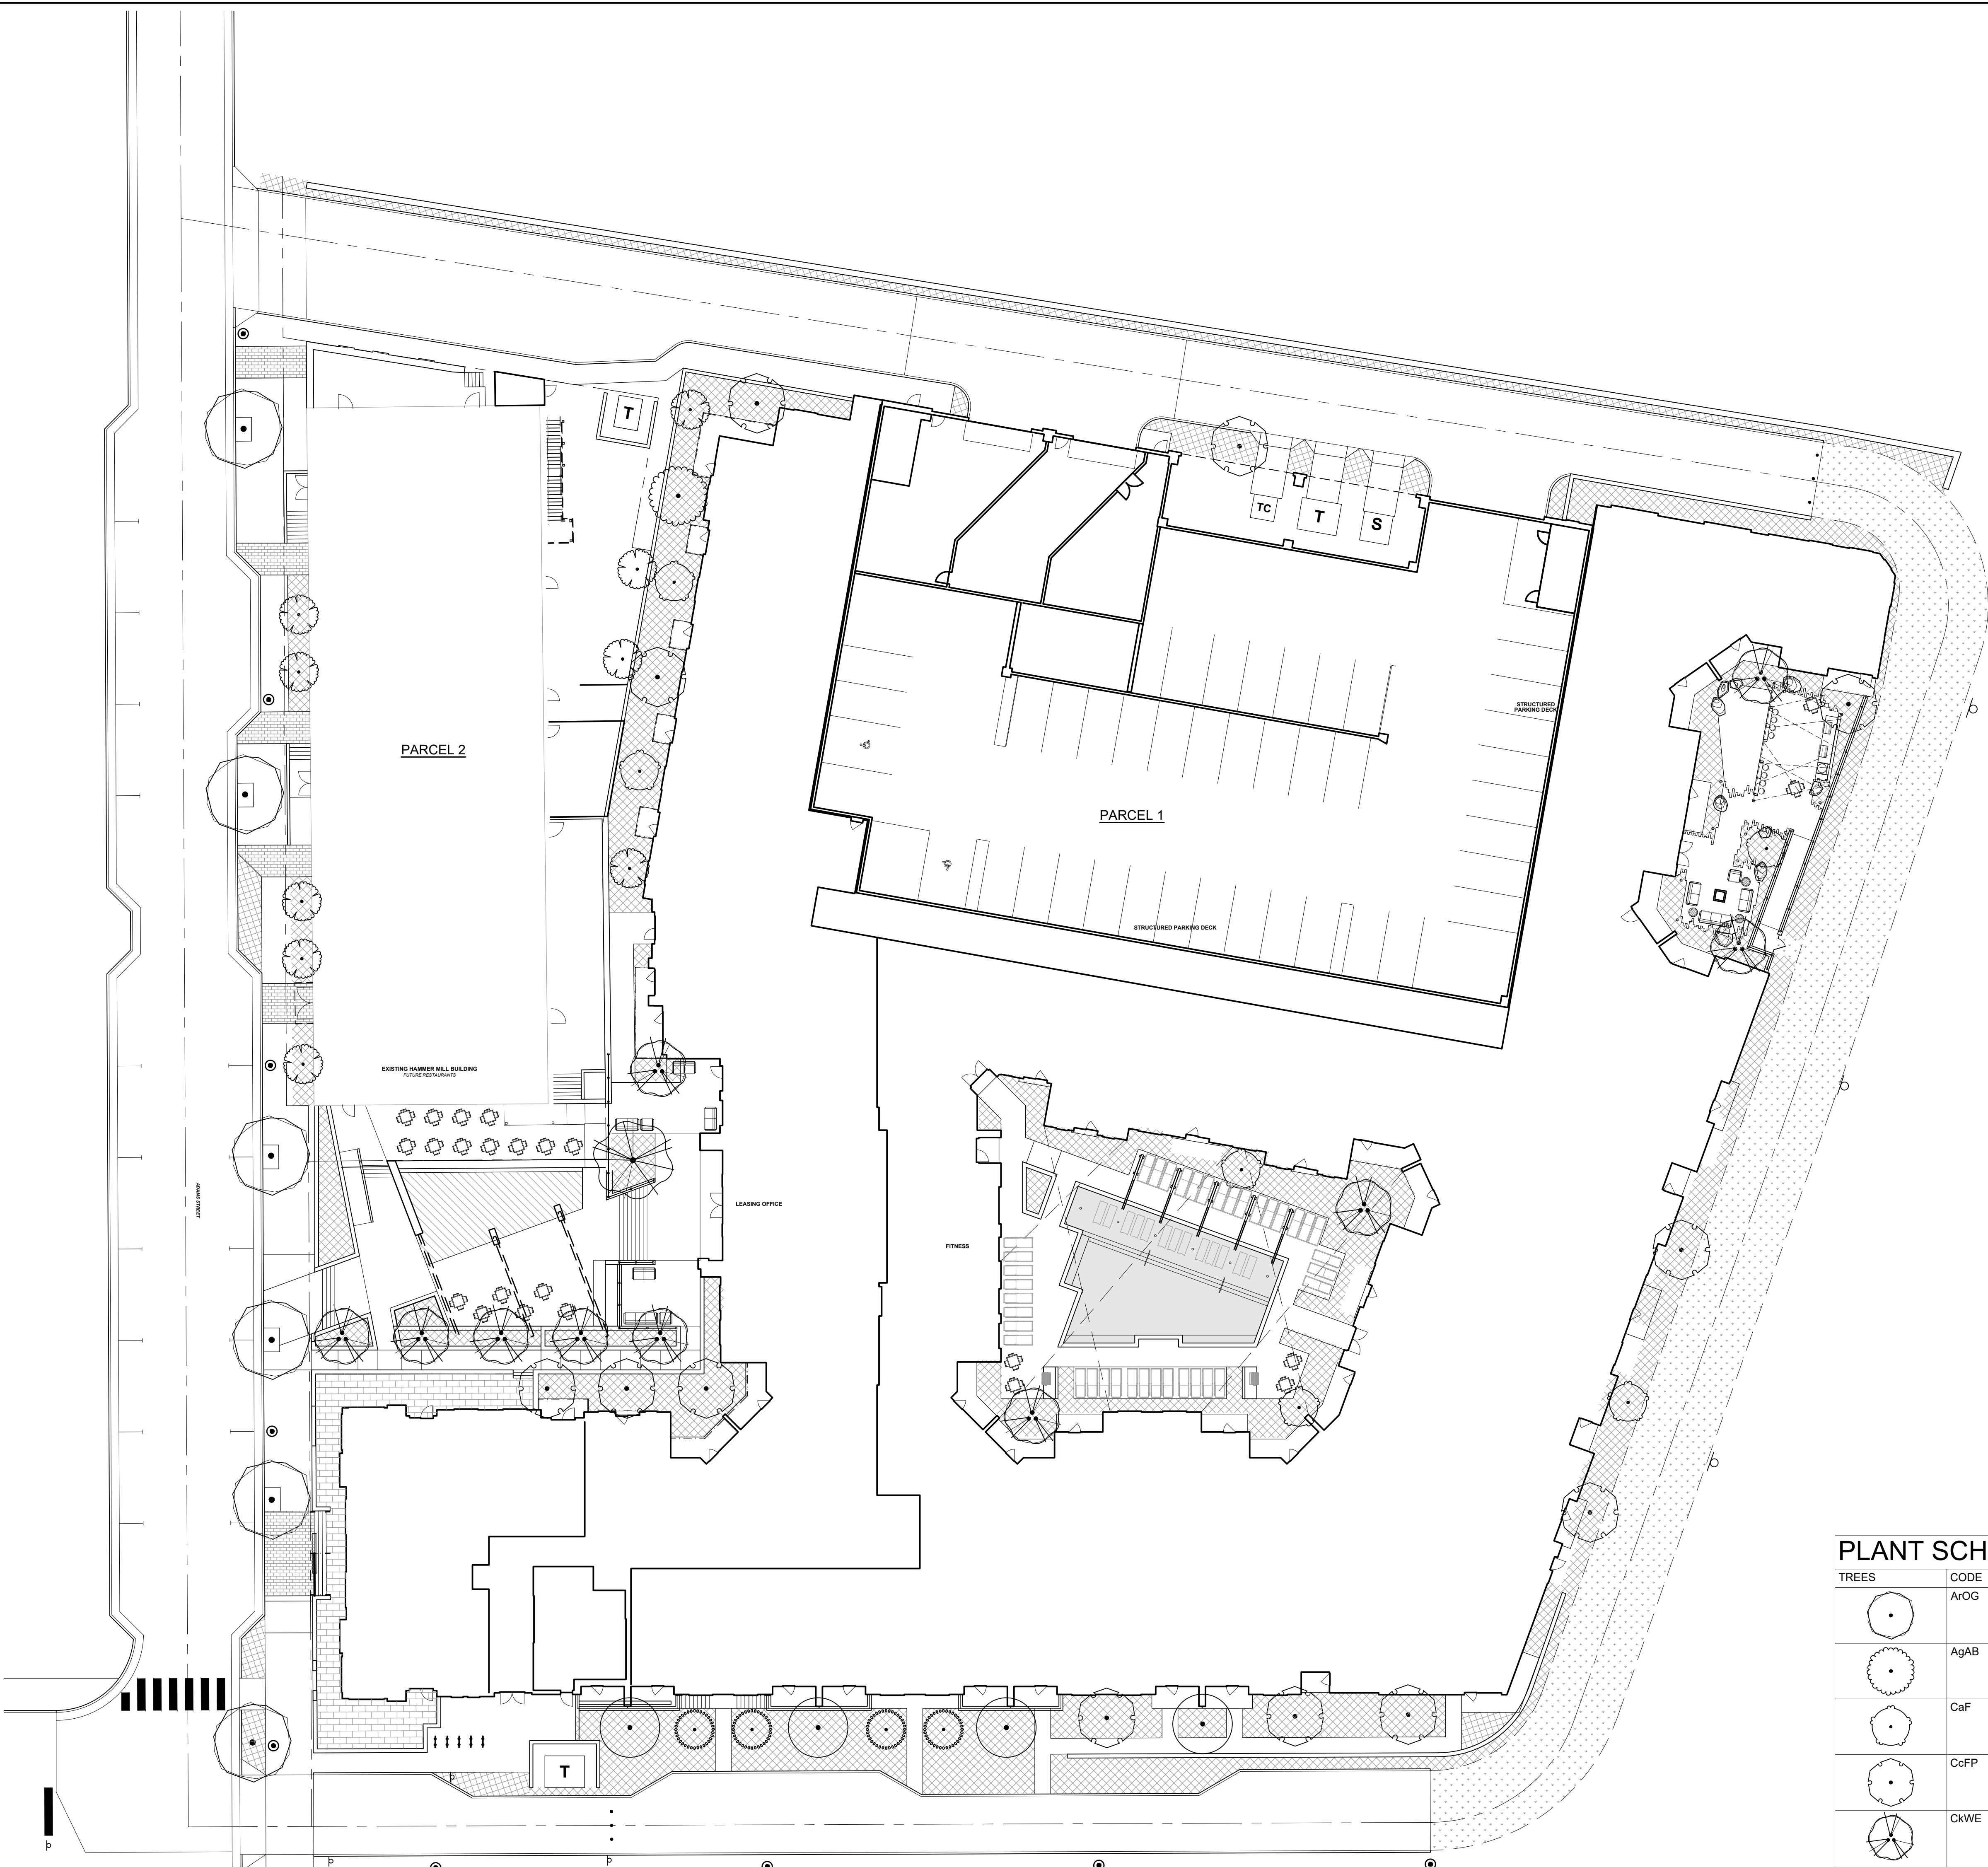

LANDSCAPE DATA: PARCEL 1		LANDSCAPE DATA: PARCEL 2	
OVERALL SITE ACREAGE:	3.33 ACRES	OVERALL SITE ACREAGE:	0.36 ACRES
ZONING:	IG	ZONING:	IG
LAND USE:	OPEN STORAGE	LAND USE:	OPEN STORAGE
SITE TREE DENSITY CALCULATIONS		SITE TREE DENSITY CALCULATIONS	
OVERALL SITE ACREAGE:	3.33 ACRES	OVERALL SITE ACREAGE:	0.36 ACRES
PROJECT ACREAGE (DISTURBED AREA):	3.33 ACRES	PROJECT ACREAGE (DISTURBED AREA):	0.36 ACRES
BUILDING ACREAGE:	1.70 ACRES	BUILDING ACREAGE:	0.24 ACRES
ADJUSTED ACREAGE:	1.63 ACRES	ADJUSTED ACREAGE:	0.12 ACRES
TREE DENSITY UNITS REQUIRED:	22.9 TDU	TREE DENSITY UNITS REQUIRED:	1.7 TDU
(14 TDU/ACRES x 1.63 ACRES)		(14 TDU/ACRES x 1.63 ACRES)	
TREE DENSITY UNITS PROVIDED:	0.0 TDU	TREE DENSITY UNITS PROVIDED:	0.0 TDU
TOTAL EXISTING TREE TDU:	0.0 TDU	TOTAL EXISTING TREE TDU:	0.0 TDU
PROPOSED TREE TDU:	21.0 TDU	PROPOSED TREE TDU:	2.4 TDU
35'-3" CAL. TREES @ 0.6		4'-3" CAL. TREES @ 0.6	
5'-4" CAL. TREES @ 0.7	3.5 TDU	TOTAL (PROPOSED TDU):	2.4 TDU
TOTAL (PROPOSED TDU):	24.5 TDU	*TREE DENSITY REQUIREMENT SATISFIED	
*TREE DENSITY REQUIREMENT SATISFIED		*TREE DENSITY REQUIREMENT SATISFIED	

PLANT SCHEDULE

TREES	CODE	QTY	PARCEL 1	PARCEL 2	RIGHT-OF-WAY	BOTANICAL NAME	COMMON NAME	CONT	CALIPER	HEIGHT	REMARKS
	ArOG	5			5	Acer rubrum 'October Glory'™	October Glory Maple	B & B	3" MIN.	13'-15' HT.	
	AgAB	1	1			Amelanchier x grandiflora 'Autumn Brilliance'	'Autumn Brilliance' Serviceberry	B & B	3" MIN.	12'-14' HT.	
	CaF	6	6			Cedrus atlantica 'Fastigiata'	Columnar Blue Atlas Cedar	B & B	3" MIN.	8'-10' HT.	
	CcFP	12	12			Cercis canadensis 'Forest Pansy'™	Forest Pansy Redbud	B & B	3" MIN.	8'-10' HT.	
	CkWE	10	10			Cornus kousa 'Wolf Eyes'	Variiegated Kousa Dogwood	B & B	3" MIN.	8'-10' HT.	
	Gli	1	1			Gleditsia triacanthos inermis	Thornless Common Honeylocust	B & B	4" MIN.		thornless / fruitless only
	LS	9	2	4	3	Liquidambar styraciflua 'Slender Silhouette'	Columnar Sweet Gum	B & B	3" MIN.	8'-10' HT.	
	MgA	4	4			Magnolia grandiflora 'Alta'	Alta Magnolia	B & B	3" MIN.		
	UpA	4	4			Ulmus parvifolia 'Athena'	Athena Elm	B & B	4" MIN.	13'-15' HT.	
GROUND COVERS	CODE	QTY	PARCEL 1	PARCEL 2	RIGHT-OF-WAY	BOTANICAL NAME	COMMON NAME	CONT	SPACING	SIZE	REMARKS
	OO2	14,534 sf	13,472 sf	434 sf	628 sf	Evergreen/Deciduous Shrubs & Groundcover	OTHER	VARIES		VARIES	
	FF	7,901 sf	7,901 sf			Festuca x	Fescue Seed	BR			
	SynT	696 sf	696 sf			Synthetic Turf - EasyTurf Olive Ultra	1.5/8" Polyethylene, 3/8" Guage	BR			

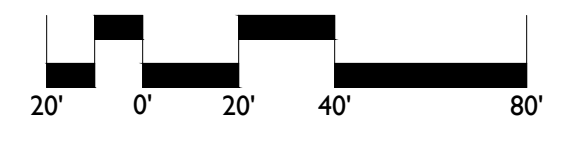


NOTE: FINAL SUPPLEMENTAL PLANTING PLAN TO BE COMPLETED AT A LATER DATE THAT WILL INCLUDE ALL SPECIES OF TREES/SHRUBS/GROUNDCOVER. SPECIES SHOWN IS SUBJECT TO CHANGE.

REVISIONS:
 DATE: 09/09/2016
 DESIGNED BY: SAH/DAY
 12/22/2016 BUILDING PERMIT SET
 CHECKED BY: DAY
 10/24/2017 5P AMENDMENT
 Q.C. BY: RP
 PROJECT #: 10.022
 SHEET #:
**HAMMER MILL
 MULTI FAMILY/RETAIL**
 Gateway TBR Hammer Mill, GP, Nashville, Tennessee
REQUIRED PLANTING PLAN




1 SP SUBMITTAL - OVERALL NORTH ELEVATION
1/16" = 1'-0"

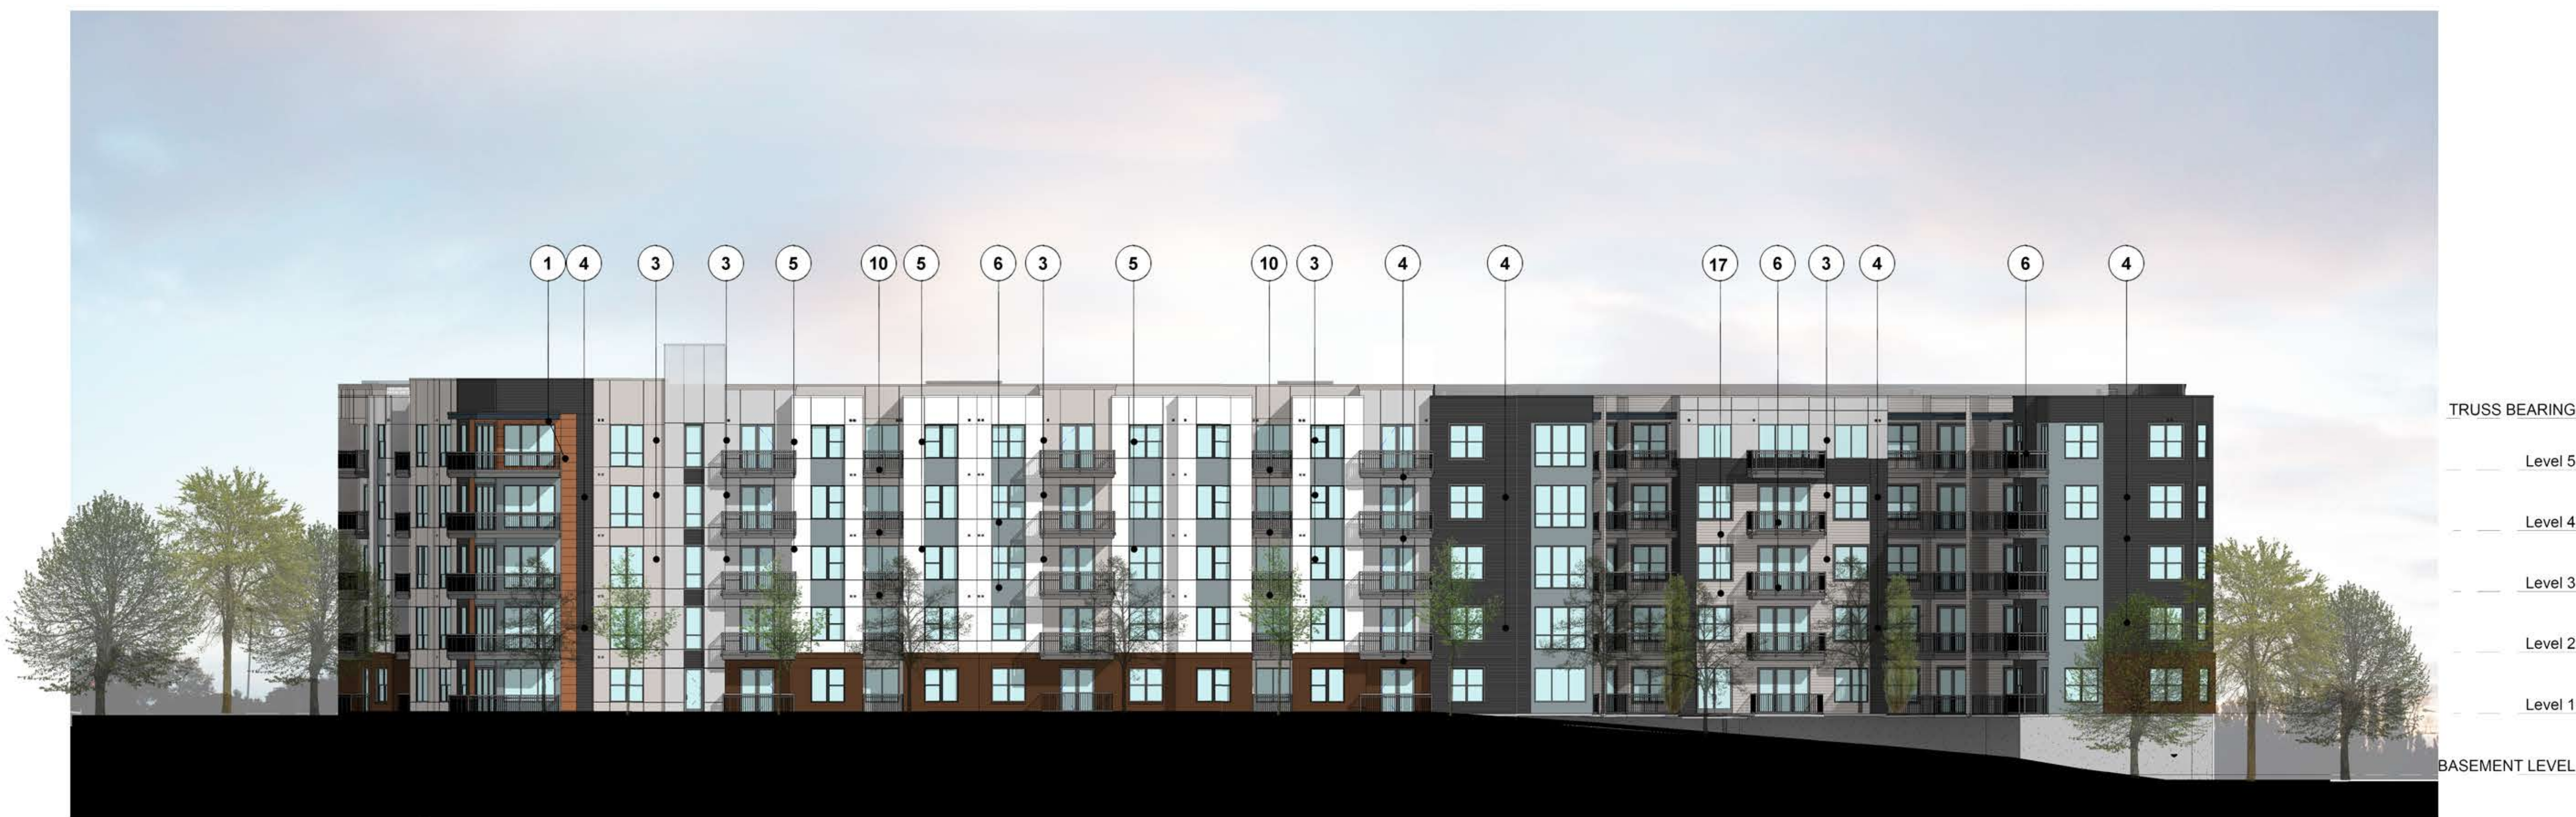

2 SP SUBMITTAL - OVERALL EAST ELEVATION
1/16" = 1'-0"

MATERIAL FINISH LEGEND	
1 NICHIA PANEL	9 METAL CANOPY-2
2 BRICK-1	10 CEMENTITIOUS PANEL
3 STUCCO FINISH 1	11 STORE FRONT WINDOW
4 CEMENTITIOUS LAP SIDING (IN VARIOUS SIZE)	12 GARAGE DOOR WITH GLASS PANEL
5 STUCCO FINISH 2	13 PAINTED PRECAST PARKING DECK
6 METAL PICKET RAILING	14 METAL ROLL UP DOOR
7 METAL CANOPY-1	15 - NOT USED -
8 C.I.P. CONCRETE	16 BRICK-2

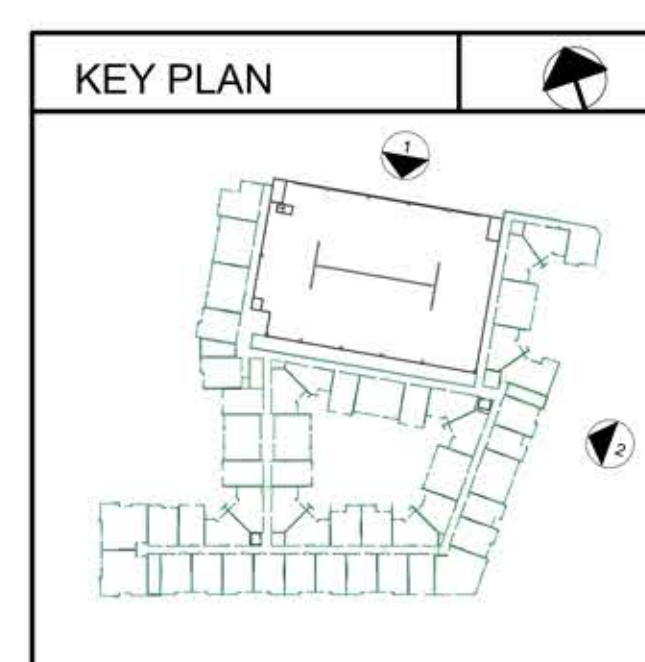

ISSUE	DATE	DESCRIPTION

REVISION	DATE	DESCRIPTION	REV

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SHEET NAME

SITE PLAN SUBMITTAL - ELEVATIONS

JOB NUMBER: 150706

DRAWN BY: Author
CHECKED BY: Checker

SP4-01
ISSUED FOR CONSTRUCTION



1 SP SUBMITTAL - OVERALL SOUTH ELEVATION
1/16" = 1'-0"




2 SP SUBMITTAL - OVERALL WEST ELEVATION
1/16" = 1'-0"



3 SP SUBMITTAL - PARTIAL BUILDING ELEVATION - WEST
1/16" = 1'-0"

MATERIAL FINISH LEGEND

- | | |
|--|---------------------------------|
| 1 NICHHA PANEL | 9 METAL CANOPY-2 |
| 2 BRICK-1 | 10 CEMENTITIOUS PANEL |
| 3 STUCCO FINISH 1 | 11 STORE FRONT WINDOW |
| 4 CEMENTITIOUS LAP SIDING (IN VARIOUS SIZES) | 12 GARAGE DOOR WITH GLASS PANEL |
| 5 STUCCO FINISH 2 | 13 PRECAST PARKING DECK |
| 6 METAL PICKET RAILING | 14 METAL ROLL UP DOOR |
| 7 METAL CANOPY-1 | 15 - NOT USED - |
| 8 C.I.P. CONCRETE | 16 BRICK-2 |

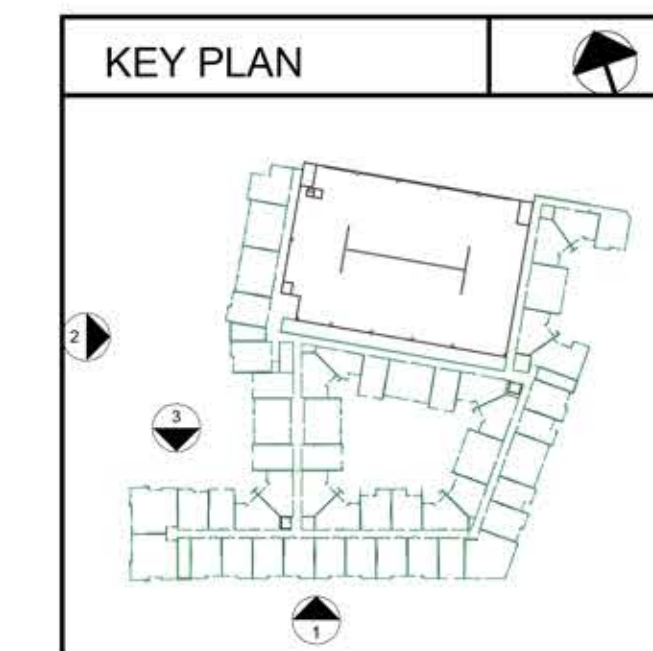

ISSUE DATE DESCRIPTION

REVISION DATE DESCRIPTION REV

DATE

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SHEET NAME:

SITE PLAN SUBMITTAL - ELEVATIONS

JOB NUMBER: 150706

DRAWN BY: Author
CHECKED BY: Checker

SP4-02