

## ONE PHASE

PHASING SCHEDULE

• UNE PHASE		
UNIT DATA		
UNIT NO.	FLOOR AREA (S.F.)	
1	1510	
2	1510	
3	1510	
4	1510	
5	1650	
6	1650	
7	1650	
8	1650	
TOTAL	12,600	

#### NOT TO SCALE VICINITY MAP

#### SP NOTES

- 1. THE PURPOSE OF THIS SP IS TO ALLOW 4 DETACHED RESIDENTIAL UNITS.
- 2. METRO FIRE MARSHALL: The required fire flow shall be determined by the Metropolitan Fire Marshall's Office, prior to the issuance of a building permit.
- . METRO WATER SERVICES STORMWATER: Any excavation, fill or disturbance of the existing ground elevation must be done in accordance with storm water management ordinance No. 78—840 and approved by the Metropolitan Department of Water Services.
- METRO WATER SERVICES STORMWATER: Size driveway culverts per the design criteria set forth by the Metro Stormwater Manual. (minimum driveway culvert in Metro ROW is 15" CMP).
- METRO WATER SERVICES STORMWATER: This drawing is for illustration purposes to indicate the basic premise of the development. The final lot count and details of the plan shall be governed by the appropriate regulations at the time of final application.
- METRO WATER SERVICES STORMWATER: Metro Water Services shall be provided sufficient and unencumbered ingress and egress at all times in order to maintain, repair, replace, and inspect any stormwater facilities within the property.
- METRO WATER SERVICES WATER & SEWER: Note to Prospective Owners: You are strongly advised to contact Metro Water Services Engineering (Development Services) to determine adequacy of public water and sewer facilities for intended development of property.
- No structure shall be more than three stories and shall be limited to a maximum height of 35 feet, measured to the roofline. Building elevations for all street and courtyard facing facades shall be provided with the final site plan. The following standards shall be met:
- a. Building facades fronting a street and courtyard shall provide a minimum of one principal entrance (doorway) and a minimum of 25% glazing.
- b. Windows shall be vertically oriented at a ratio of 2:1 or greater, except dormers
- c. EIFS, vinyl siding and untreated wood siding shall be prohibited.
- d. Finished ground floors and porches shall be elevated a minimum of 18" to a maximum of 36" from the abutting average ground elevation.

	PLANT MATERIAL SCHEDULE					
KEY	QTY	BOTANICAL NAME	COMMON NAME	HEIGHT	TRUNK	COMMENT
BN	4	BETULA NIGRA	RIVER BIRCH	12'-14'	2.0"-2.5" cal.	5 FT CLEAR TRUNK
CA	5	CERCIS CANADENSIS 'ALBA'	WHITE REDBUD	10'-12'	2.0"-2.5" cal	4 FT CLEAR TRUNK

#### LANDSCAPE REQUIREMENTS

- 1. BUFFERYARDS: NONE
- 2. TREE DENSITY:

LAND AREA 0.40 ACRES
- BLDG AREA 0.10 ACRES
NET AREA = 0.30 ACRES x DENSITY 14 UNITS/ACRE

PROPOSED TREES 0.5 x 9 (2" CAL)= 4.5 UNITS

4.2 TDU REQUIRED

- 3. PERIMETER PARKING: NONE
- 4. INTERIOR PARKING: NONE

		GRAPHI	IC SCALE	
20	0 10	20 I	40	
		( IN 1 inch	FEET ) = 20 ft.	


## PROJECT NOTES

- 1. EXISTING CONDITIONS TAKEN FROM SURVEY BY HFR SURVEYING, DATED APRIL 27, 2015. DATUM NAD83 AND NGVD88.
- 2. THIS PROPERTY IS LOCATED IN A ZONE X WHICH IS NOT WITHIN THE 100 YEAR FLOOD HAZARD ACCORDING TO FLOOD MAP PANEL NO. 47037C0216F, DATED APRIL 20, 2001.
- 3. OWNERSHIP FOR UNITS MAY BE DIVIDED BY A HORIZONTAL PROPERTY REGIME OR A SUBDIVISION WITH A MINIMUM LOT SIZE OF 1000 S.F.



Nashville & Davidson County JUL 16 2015

Metropolitan Planning Department

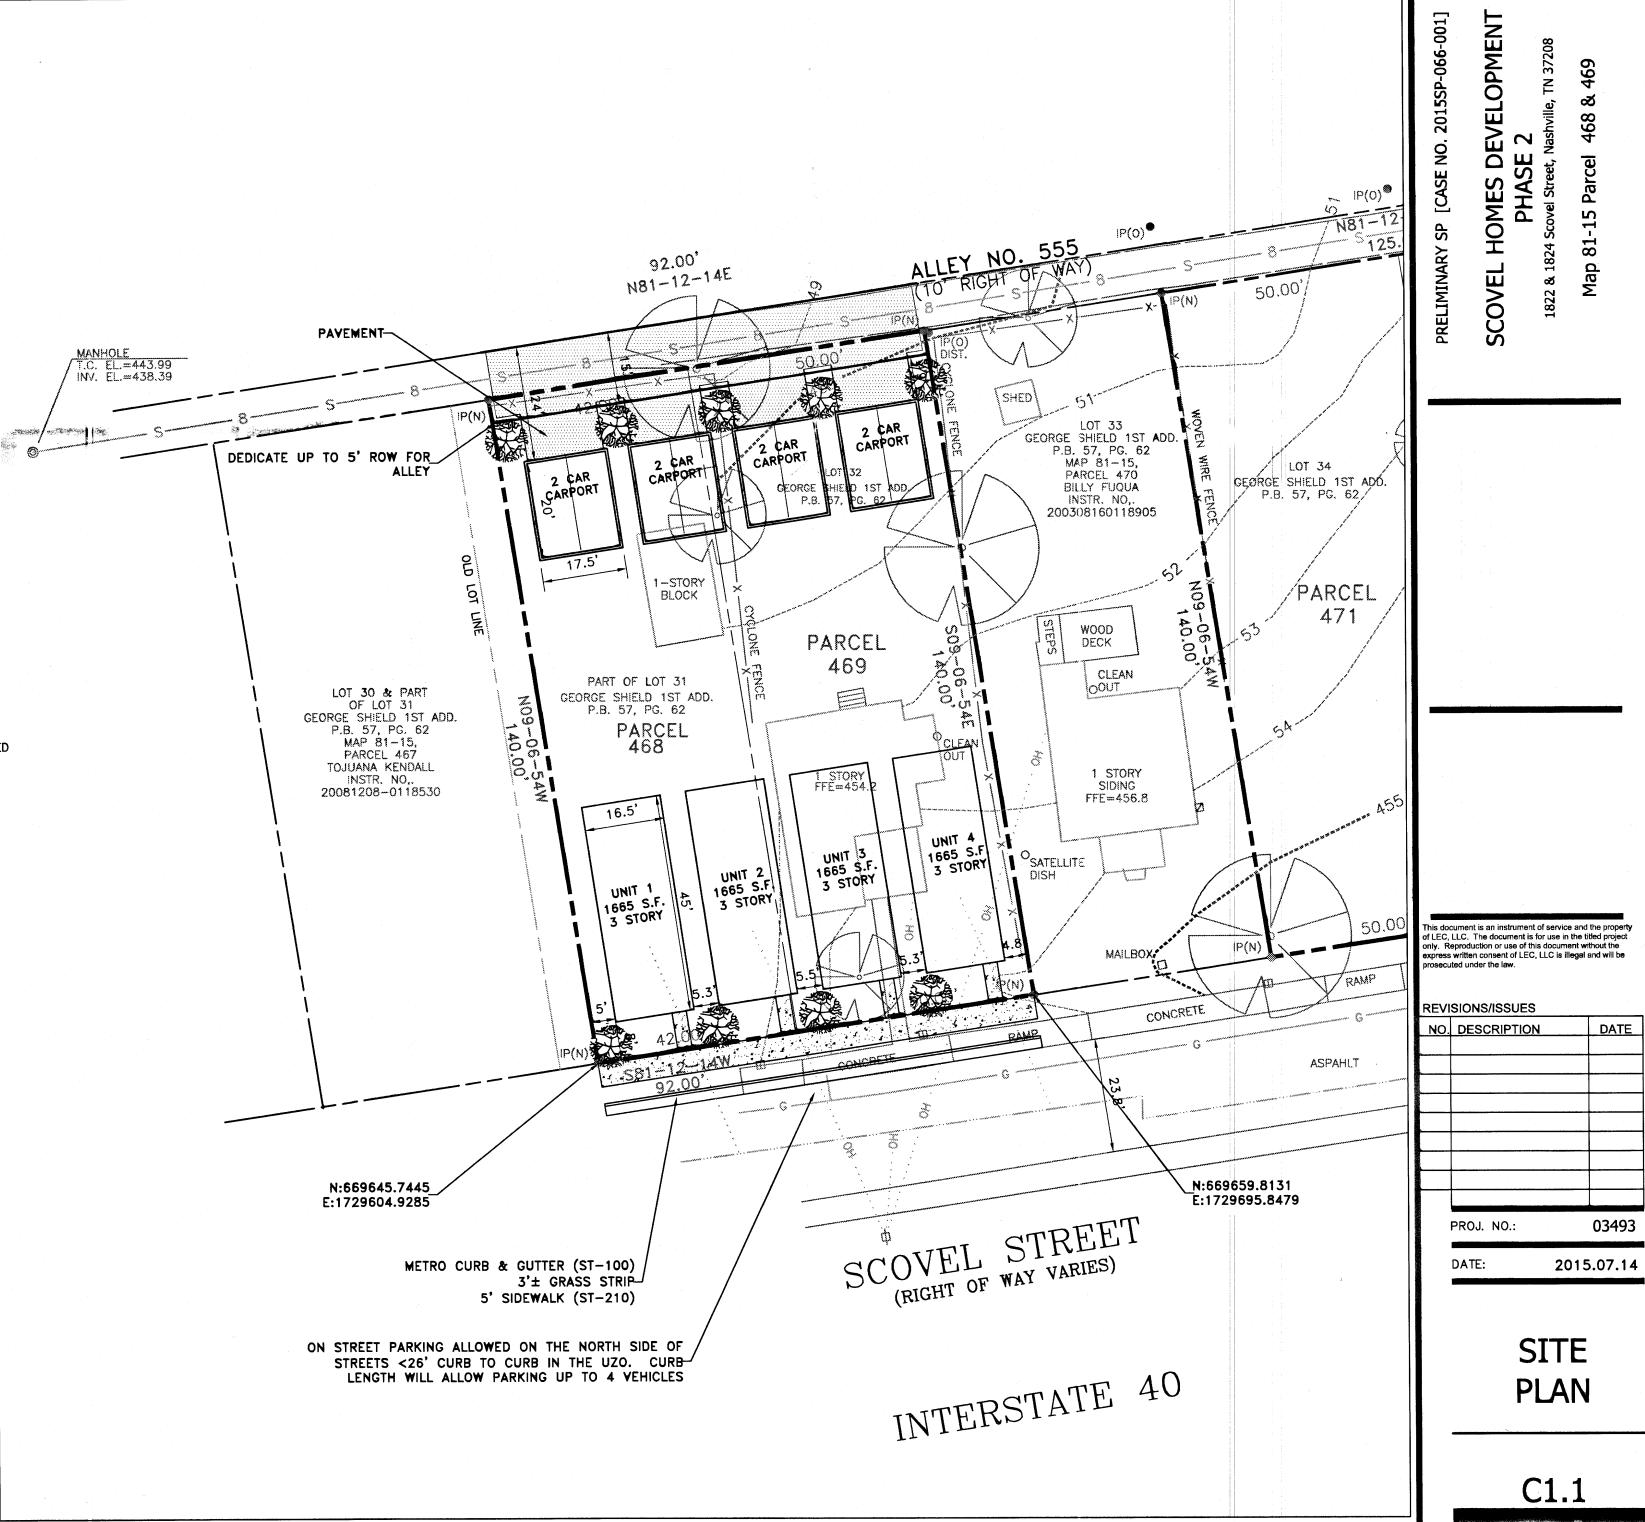

$\odot$			
REPROD	DEVELOPMENT/SITE DATA TABLE		
B	ACREAGE	0.296 ACRES (12,880 S.F.)	
DOCUMENT MAY	DENSITY	14 UNITS/AC	
OMEN	DWELLING UNITS	4 UNITS	
	FLOOR AREA RATIO (FAR)	0.51 (6,620 / 12,880)	
THIS	LOTS	1	
OF.	IMPERVIOUS SURFACE RATIO (ISR)	0.40 (5,072/12,880)	
S)NOI	BUILDINGS	4,400 S.F.	
NO PORTION(S)	DRIVEWAYS & SIDEWALKS	672 S.F.	
RESERVED. N	PARKING CALCULATION	2 SPACES PER DETACHED UNIT	
RIGHTS RES	PARKING CREDITS	10% TRANSIT = 10% REDUCTION ON-STREET PARKING UP TO 2 SPACES	
ALL F	PARKING REQUIRED	REQUIRED: 4x2 = +8	
2014 -	PARKING PROVIDED	8 SPACES	
rRIGHT	USES	DETACHED RESIDENTIAL	
-Œ			

## DEVELOPMENT SUMMARY

- COUNCIL DISTRICT: 21
- COUNCILMEMBER: LANGSTER
- OWNER OF RECORD:

SCOVEL HOMES DEVELOPMENT, LLC PARCEL 468 102 WOODMONT BLVD, s-244

NASHVILLE, TN 37205

1822 SCOVEL STREET, NASHVILLE, TN 37208

The state of the s


- SP NAME: SCOVEL HOMES DEVELOPMENT PHASE 2
- SP NUMBER: 2015SP-066-001
- PLAN PREPARATION DATE: 2015.05.19
- SCALE: 1"=20'

PARCEL 469

- JIM LUKENS, P.E. DESIGN PROFESSIONAL: LUKENS ENGINEERING CONSULTANTS P.O. BOX 1586, BRENTWOOD, TN 37024
- 615.804.4617 • FEMA FIRM: 47037C0216F

DATE

03493

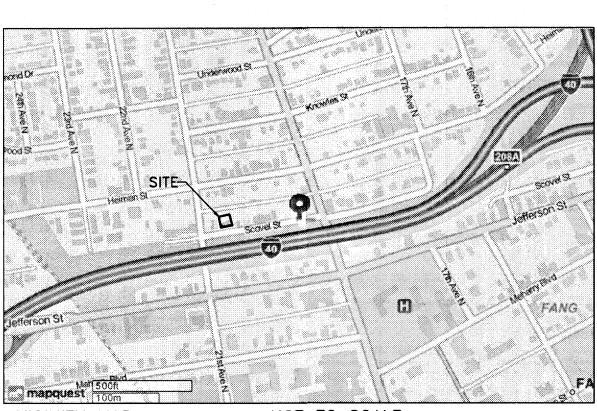

VICINITY MAP

NOT TO SCALE

## AS-BUILT NOTE

IN ACCORDANCE WITH THE METRO STORMWATER MANAGEMENT MANUAL, VOLUME I, SECTION 3.9, AS-BUILT CERTIFICATIONS, MWS STORMWATER DIVISION MUST APPROVE THE FOLLOWING AS-BUILTS PRIOR TO ISSUANCE OF THE USE & OCCUPANCY PERMIT:

- UNDERGROUND DETENTION AND WATER QUALITY INFRASTRUCTURE
  ABOVE GROUND DETENTION AND WATER QUALITY INFRASTRUCTURE
- PUBLIC STORM SEWER INFRASTRUCTURE
- CUT & FILL IN THE FLOODPLAIN
- SINK HOLE ALTERATIONS

THE ENGINEER SHALL CONTACT STORMWATER DEVELOPMENT REVIEW STAFF FOR SUBMITTAL REQUIREMENTS.


### STORMWATER NOTES

- 1. DAVIDSON COUNTY SOILS MAPPING SHOWS THE SOIL TO BE MAURY (McB) SOILS WITH HYDROLOGICAL GROUP A.
- 2. OFF-SITE IMPROVEMENTS MAY BE REQUIRED TO CONVEY THE ON-SITE RUNOFF.
- 3. WATER QUALITY CONCEPT:
- EXEMPT FROM GRADING PERMIT.

TENNESSEE CONSTRUCTION GENERAL PERMIT NOTICE OF COVERAGE (NOC) CERTIFICATION


The project associated with these submitted plans does not require coverage covered under Tennessee Construction General Permit.

07/13/2015

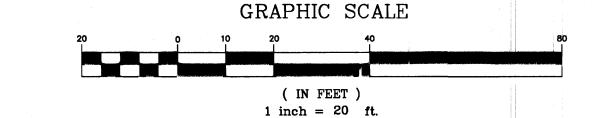


## PROJECT NOTES

- 1. EXISTING CONDITIONS TAKEN FROM SURVEY BY HER SURVEYING, DATED APRIL 27, 2015. DATUM NAD83 AND NGVD88.
- 2. THIS PROPERTY IS LOCATED IN A ZONE X WHICH IS NOT WITHIN THE 100 YEAR FLOOD HAZARD ACCORDING TO FLOOD MAP PANEL NO. 47037C0216F, DATED APRIL 20, 2001.

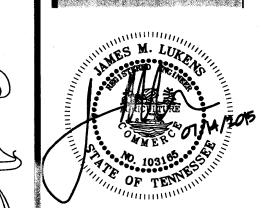



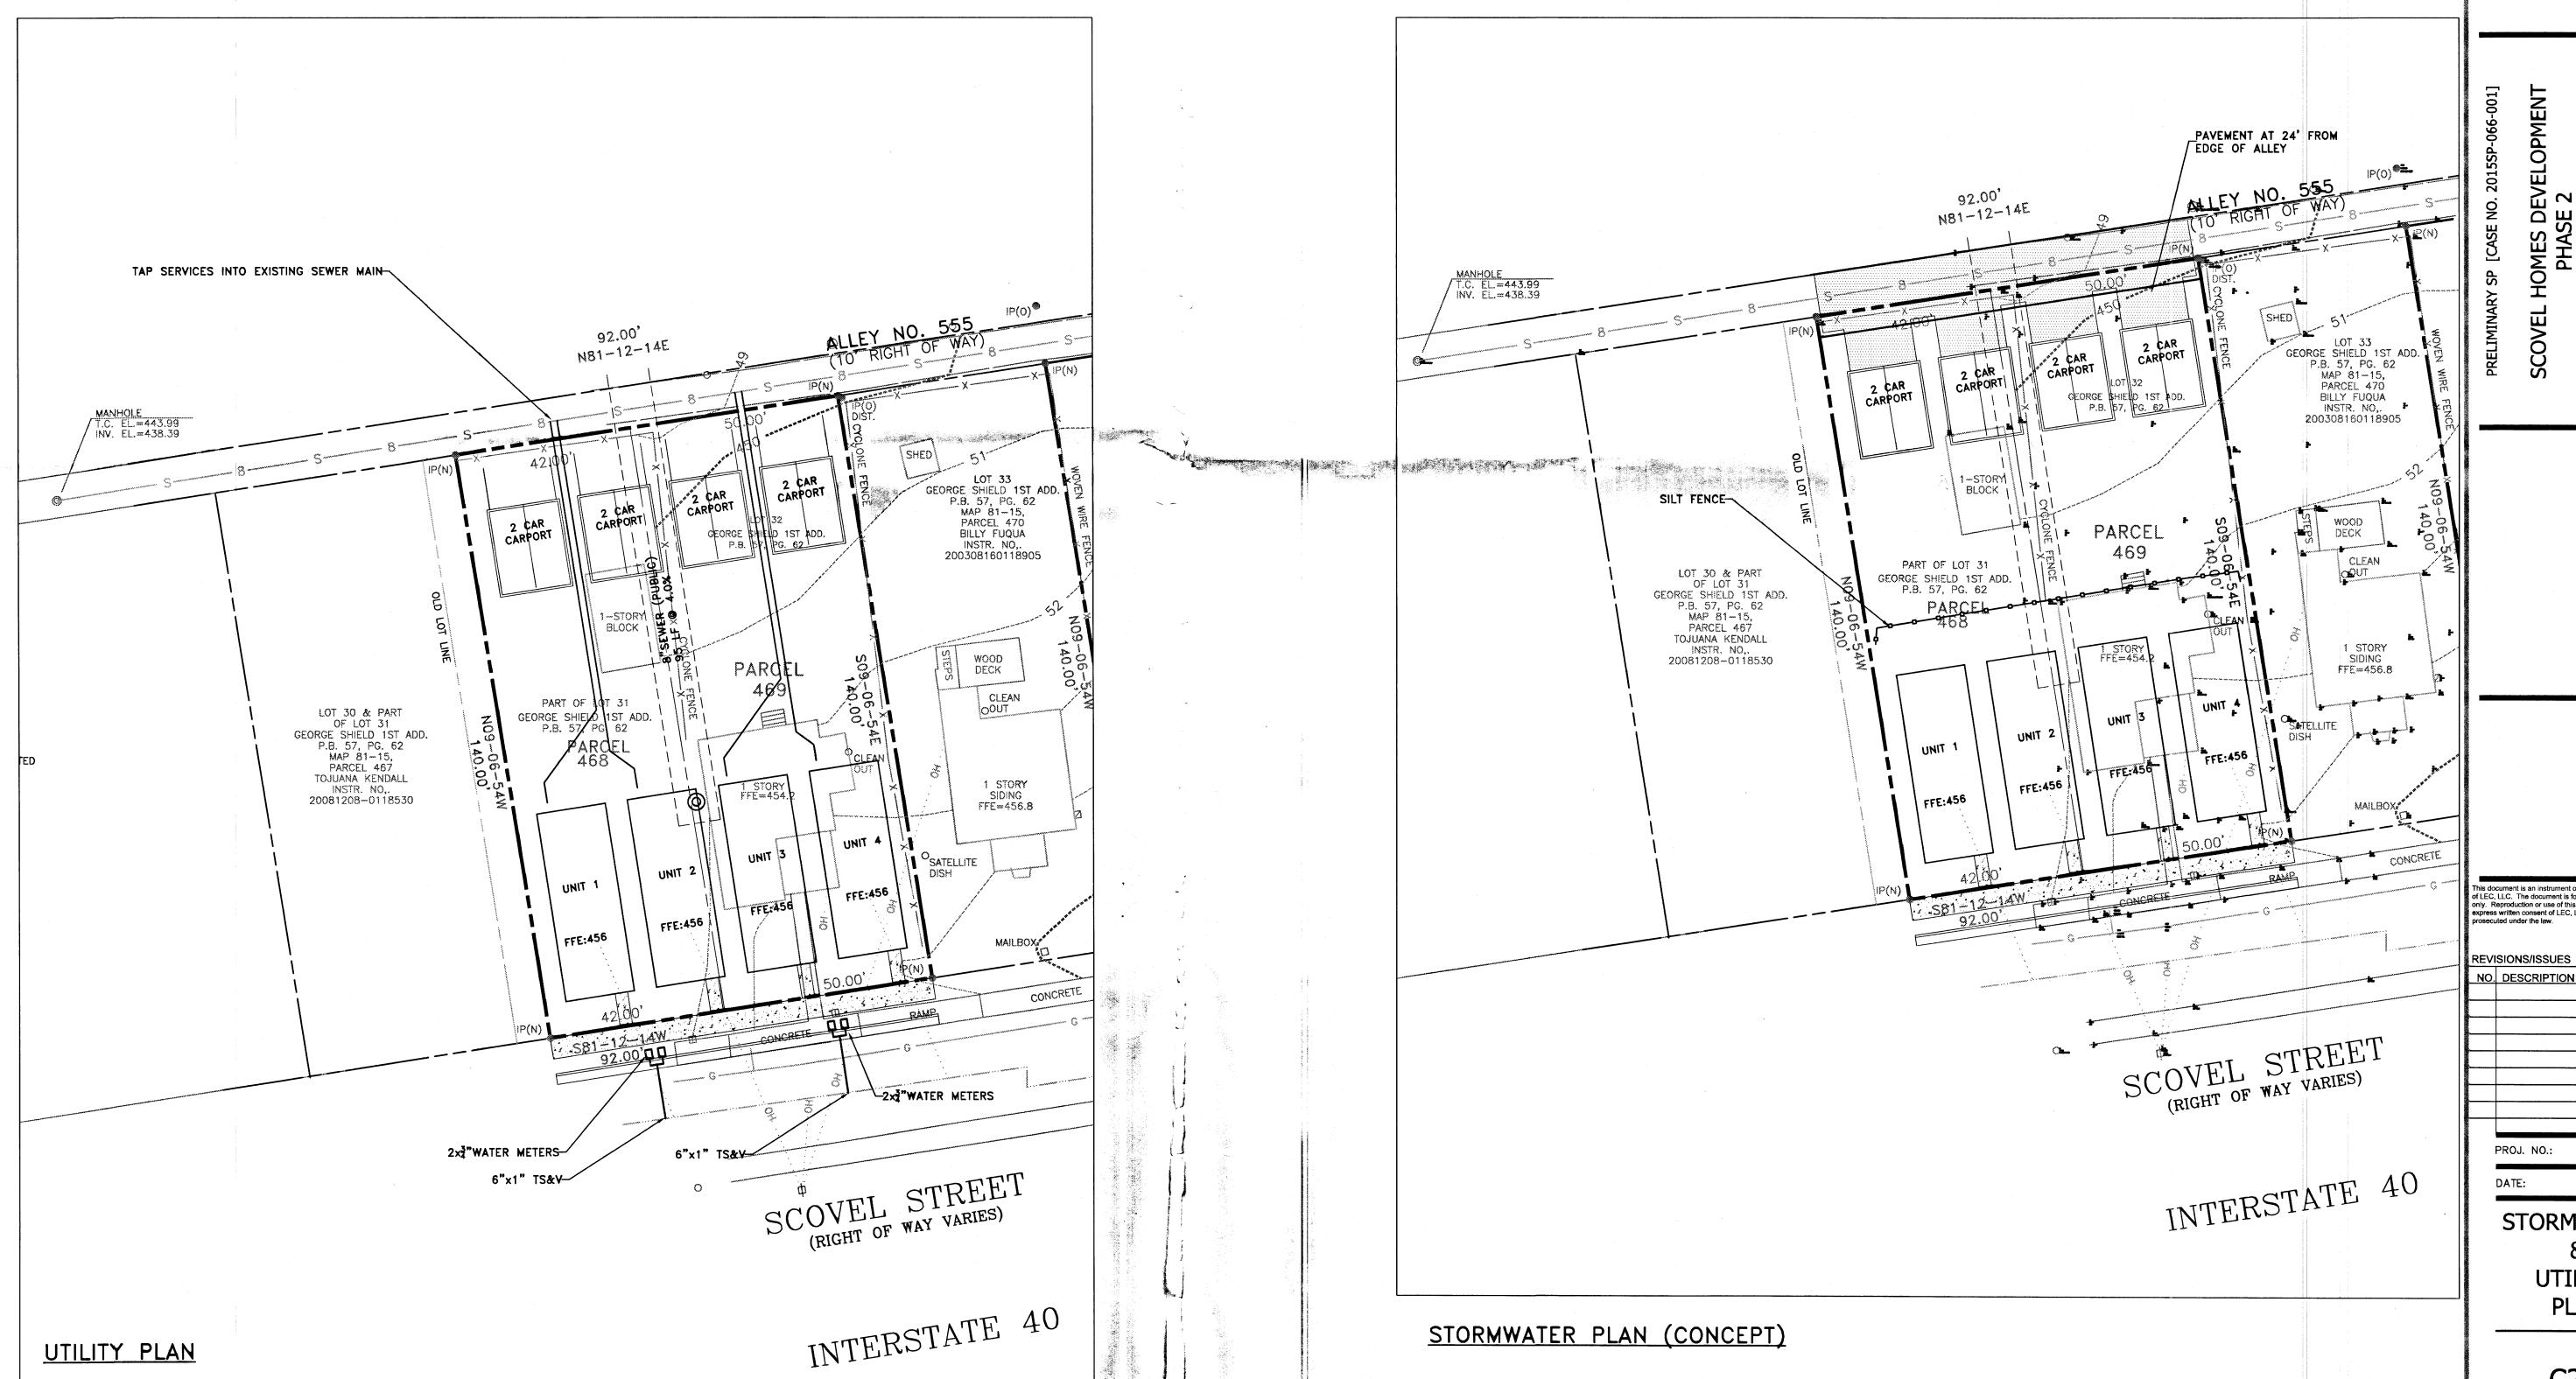

This document is an instrument of service and the property of LEC, LLC. The document is for use in the titled project only. Reproduction or use of this document without the express written consent of LEC, LLC is illegal and will be prosecuted under the law.

REVISIONS/ISSUES NO. DESCRIPTION

DATE

03493

2015.07.14 **STORMWATER** 

UTILITY **PLAN** 



# ELEVATIONS FACING SCOVEL STREET LOT A - PHASE TWO(2) ALL FACING SOUTH CASE NUMBER 2015SP-066-001



ELEVATIONS FACING SCOVEL STREET LOT B - PHASE ONE(1)
ALL FACING SOUTH
CASE NUMBER 2015SP-065-001



PROVIDED WITH THE FINAL SITE PLAN. THE FOLLOWING STANDARDS SHALL BE MET:

A. BUILDING FACACES FRONTING A STREET AND COURTYARD SHALL PROVIDE A MINIMUM OF THE PROVIDE A MINIMUM OF THE PROVIDE A MINIMUM OF THE PROVIDED BY TRANSFER OF THE PROVIDED BY THE PROVIDED B

A MINIMUM OF ONE PRINCIPAL ENTRANCE (DODRWAY) AND A MINIMUM OF ONE 26% GLAZING, I. WINDOWS SHALL BE VERTICALLY ORIENTED AT A RATIO OF 2:1 OR GREATER,

EACEP IDUMNESS.

CEPS, VINYL SIDING AND UNTREATED WOOD SIDING SHALL BE PROHIBITED.

D. FINISHED GROUND FLOORS AND PORCHES SHALL BE ELEVATED A MINIMUM OF 18 INCHES TO A MAXIMUM OF 36 INCHES FROM THE ABUTTING AVERAGE (SPOILING E) EVATOR.



PROPOSED ELEVATIONS

SCOVEL HOMES DEVELOPMENT LLC

RE	VISIONS
DATE	DESCRIPTION
PROJECT NO	
DRAWING DATE 07/17/2015	
DRAWN BY	J. MYATT RA
CHECKED BY	,

A-1